

TOWN OF DAVIDSON DESIGN REVIEW BOARD 7:00PM Board Room in Town Hall a 216 S Main St, Davidson, NC

August 21, 2019

- I. CALL TO ORDER
- II. SILENT ROLL CALL
- III. CHANGES TO THE AGENDA
- IV. REVIEW/APPROVAL OF THE MINUTES
 - (a) Minutes 2019 July 17
- V. OLD BUSINESS
- VI. NEWBUSINESS
 - (a) Davidson Gateway Building FYI
- VII. OTHER ITEMS
- VIII. ADJOURN



Agenda Title: Minutes 2019 July 17

Summary:

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ATTACHMENTS:

Description **Upload Date** Type Minutes 2019 July 17

8/12/2019 Exhibit

Meeting Minutes Design Review Board

Town of Davidson, NC July 17, 2019

A meeting of the Town of Davidson *Design Review Board* was held in the Town Hall, Board Room, 216 S. Main St.

Call to Order: 7:01 p.m.

Silent Roll Call and Determination of Quorum:

Members Present signified by ∑:

□ Bruce Barteldt, Chair □ John Burgess □ Lorraine Degree □ Brian Bumann □ Jeff Osman

Chair □ Bob Sipp
□ Mike Kessler □ EB Dyer

Town Staff Present: Lindsay Laird (Planner)

Changes to the Agenda: None.

Review/Approval of the Minutes

A motion was made (BSipp) to approve the meeting minutes of June 19, 2019 as submitted. It was seconded (BBumann) and the motion was approved unanimously.

Consent Item: None.

Old Business:

1. Wells Fargo ATM (Continued)

Located at 601 Griffith St (Parcel ID 00321403) Special Use Planning Area Proposed ATM; approved under 1997 SUP

Lindsay Laird gave an overview of the project, noting that there is a Special Use Permit associated with the property which allows for a standalone ATM on site. The proposed ATM will be located on the existing cement pad at the corner of the parking lot, near the Griffith Street and Jetton Street roundabout. The DRB discussed the following conditions, which the applicant addressed with updated renderings of the proposed ATM:

1) the ATM enclosure shall be clad in brick to match adjacent buildings, 2) the electrical meter shall be reoriented so that it faces away from the side of the ATM structure and does not face the parking lot or the street, 3) the color of the light pole base and clearance bar shall be painted to match the meter pedestal (bronze), and 4) the signage on top of the ATM canopy shall not be internally illuminated.

After additional discussion, a motion was made (BBumann) to approve the proposed project with a fifth condition: that the new cut off light shall not exceed 1-2' in height above the existing light pole (to be removed) and the new light shall be shielded from Griffith and Jetton Streets. The motion was seconded (MKessler) and approved unanimously.

New Business: None.	
Other Items: None.	
Adjourn: A motion was made to unanimously. The meeting was ac	adjourn (BSipp), seconded (LDegree), and approved djourned at 7:10 pm.
Approval of Minutes:	
Date:	By:

Please note: This is a summary of the meeting and not to be considered a complete transcript.



Agenda Title: Davidson Gateway Building FYI

Summary:

ATTACHMENTS:

Description Upload Date Type

□ Davidson Gateway Building FYI 8/15/2019 Cover Memo

Town of Davidson, NC Design Review Board: Staff Analysis for FYI Review August 21, 2019

Project: Davidson Gateway Building FYI

Location: 635 Davidson Gateway Drive (Parcel ID 00321117)

Applicant: David Martini-Plank

Designer: David Martini-Plank, Architect

Planning Area: Central Business District

This is an FYI review. The applicant proposes a new four-story commercial/office building at 635 Davidson Gateway Drive, which is part of the 1998 Southeast Quadrant Master Plan. The proposed building will be +/- 34,264 square feet total, with restaurant space on the first floor, office space on the second and third floors, and roof top event space on the fourth floor. The first floor will also have a large +/- 2,049 square foot patio off the south side of the building. The exterior building materials will primarily be brick, glass, and stucco (less than 25% per façade).

DAVIDSON PLANNING ORDINANCE:

4.4 GENERAL BUILDING DESIGN REQUIREMENTS

Section 4.4.1 Standards

B. Form and Massing

2. For large scale buildings, the front façade shall create repetitive bays, or the façade shall be divided into an asymmetrical, yet balance composition.

C. Facade Articulation

All building facades visible from a public street or park/open space shall have:

- A recognizable base, distinguished from the body of the building by features such as, but not limited to:
 - a. Thicker walls, ledges or sills;
 - b. Visually heavier materials (such as brick, stone, tile or other masonry) than those used on the body of the building; and/or
 - c. Lighter or darker colored materials, mullions, panels or planters.
- 2. A recognizable top, occupying the highest portion of the building and distinguished from the body of the building by features such as, but not limited to:
 - a. A dimensional cornice capping the top of a building wall;
 - b. Different materials or differently colored materials;
 - c. A roof overhang with brackets; and/or
 - d. Stepped parapets.
- 3. Large building facades shall be modulated through the use of repetitive bays separated by piers or columns, the use of reveals or recesses in the surface of the wall itself, the placement of window and door openings, or the placement of balconies, awnings, canopies, and sunshades.

E. Materials

- 1. Materials shall be selected for suitability to the type of building and design for which they are used.
- 2. Piecemeal embellishment and frequent changes in material should be avoided.
- 3. All sides of the building should use materials consistent with those on the front if visible from public streets or neighboring properties, and should be carefully designed with similar detailing, comparable quality, and compatible materials.
- 4. Building materials and colors shall be:
 - a. Complementary to the materials already being used in the neighborhood, or
 - b. If dissimilar materials are being proposed, other characteristics such as scale, proportion, form, architectural detailing, color, and texture shall be used to ensure that the building relates to the rest of the neighborhood.
- 5. All facades visible from a public street or park/open space shall utilize high-quality finish materials including, but not limited to:
 - a. Brick, masonry, or stone
 - b. Integrally tinted, textured masonry block
 - c. Stucco
 - d. Wood or cementitious siding
 - e. Glass

Stucco or EIFC system finished may be used as secondary materials and should not be greater than 25 percent of a façade.

F. Architectural Details

- Windows and door openings shall be arranged and proportioned so that vertical dimensions dominate horizontal dimensions. To the extent possible, upper story windows shall be vertically aligned with the location of windows and doors on the ground level, including storefront or display windows.
- 2. Architectural treatments which create the appearance of false entrances facing the street are prohibited. Faux windows and doors are prohibited. Visible false fronts are prohibited.
- 3. Architectural elements like openings, sills, bulkheads, columns, and other architectural features shall be used to establish human scale at the street level.
- 4. Fenestration shall be architecturally related to the style, materials, colors, and details of the building.
- 6. The main entry to a building should be emphasized at the street level. Appropriate methods include, but are not limited to:
 - a. Recessing the door within a larger cased opening.
 - b. Flanking the door with columns, decorative fixtures or other details.
 - c. An awning or canopy, providing a sheltered transition to the interior.

4.5 SPECIFIC BUILDING TYPE REQUIREMENTS Section 4.5.6 Storefront Building Type

Storefront buildings may accommodate either single or multiple uses or tenants in a single building. A group of storefront buildings may be combined to form a mixed-use neighborhood center. Individual storefront buildings shall be designed to accommodate commercial/retail uses on the first floor, though office or residential uses are permitted. Upper Floors are appropriate for office or residential use. They are a minimum of two stories, typically are aligned adjacent to the public sidewalk and include a high percentage of transparency in the ground level façade to

encourage pedestrian activity. All storefront buildings are subject to the Individual Building process and Design Review Board approval.

- A. The first floor facing the primary streets shall be designed to accommodate retail uses.
- B. At least 65% of the first floor façade between 2'-0" and 10'-0" above grade facing the primary streets must be transparent. At least 30% of the upper floors facades between 3'-0" and 120'-0" above finished floor must be transparent.
- C. The first floor shall be taller than upper floors and lower floors should be differentiated architecturally to create a sense of human scale.
- D. Building elements shall have a dominant vertical proportion.
- E. All buildings shall provide street level, pedestrian-oriented, active uses on principal street fronts.
- F. Large buildings fronting multiple streets should provide entrances from each street.
- G. Major building entrances that provide access to the primary use of the building or a central lobby shall be distinguished from the entrances used for secondary uses.
- H. The principal entrance to a building, and any ground-floor tenant space entrance, both functionally and architecturally, shall front the primary public street or a public open space such as a square, plaza, courtyard, or sidewalk.

T:\Planning_Shared_(Common)\04.BOARDS COMMISSIONS\Design Review\Agenda Packets\2019 DRB Agendas\20190821_DRB_HPC Agendas\DRB\Davidson Gateway Building FYI



Design Review Application Packet Table of Contents

Introduction

- 1. Design Review Welcome Letter
- 2. Table of Contents

Forms, Process, & Requirements

- 3. Overview: Design Review / Development Process
- 4. Application Requirements
- 5. Contact Information
- 6. Project Description
- 7. Statement of Compliance
- 8. Planning Ordinance Excerpt: Design Review Process & Documentation Requirements
- 9. Verification Process
- **10.** Verification Letter Construction Documents
- 11. Verification Letter Construction / As-Built

Mecklenburg County Requirements

- 12. Address Requirements
- 13. Air Quality Zoning Instructions

Additional Information & Instructions

- 14. Planning Ordinance Excerpt: Termination of Applications & Approvals
- 15. Town of Davidson Fee Schedule



DAVIDSON GATEWAY CENTER

(Name of Project)

Contact Information

	Applicant's Information
Name:	DAVID MARTINI-PLANK, A/A.
E-Mail:	dmartiniplank@gmailicom
Mailing Address:	143 VILLAGE VIEW DR.
	SUITE 203
Business Phone:	704.777.4447 Mobile Phone: 704.777.4447.
	Property Owner's Information (If Different from Applicant)
Name:	NICK LYSSIKATOS
E-Mail:	NICK LYSSIKATOS@gmail.com.
Mailing Address:	CORNELIUS, NC 2803).
Business Phone:	704.927.2022 Mobile Phone: 704.301.9311.
	Architect's Information
Name of Firm:	DAVID MARTINI-PLANK, ARCHITECT.
Architect's Name:	DAVID MARTINI-PLANK
E-Mail:	dmartiniplank@gmail.com
Mailing Address:	143 VILLAGE VIEW DR.
	SUITE 203 MOORESVILLE, NC 28117
Business Phone:	704·777.4447 Mobile Phone: 704·777·4447



DAUIDSON GATEWAY CENTER (Name of Project)

Project Description

Application Date:	7.31.2019.
Project Location:	DAVIDSON NC 28036
Tax Parcel(s):	TXX PKRCEL: 00321117
Planning Area:	1.227 ACRES
Overlay District:	
Master or Cond.Plan (Attach Conditions of Approval)	
Gen. Statement of	DEVELOP 4 STORY MIXED USE
Intent:	OFFICE / RESTAURANT BUILDING
	WITH ROOF TOP EVENT PAULUION.
Project Details:	
Project Type:	Individual Bldg. Master Plan Conditional Planning Area
	Sign
Building Type:	Detached House Townhouse Attached House (Tri- or Quadplex)
	Institutional Live/Work Multi-family (Apts., Condos, Flats)
	Workplace Storefront Accessory Structure
· Use(s):	MIXED USE: OFFICE RESTAURANT EVENT
Height & Stories:	4 STORIES 591-2"
 Square Footage: 	34,264 SF
 Building Materials: 	BRKK, GLASS, STUCCO, METALS
Architectural	BRICK ARCHES, EXPOSED STEEL
Features:	ROSF TOP PAVILION & LARGE PATIOS
Existing Site	SLOPING 4-7 GRASS LOT, SOFT SOIL
Conditions:	W/WATER TABLE 15 BELOW GRAPE
See 14.12.2.D	•



DAVIDSON GATEWAY CENTER

(Name of Project)

Statement of Compliance


· ·							
For each category below that is applicable to the project submit a detailed analysis describing how the project does or does not comply with the Davidson Planning Ordinance and the specific regulations of each applicable section.							
 Planning Ordinance http://www.townofdavidson.org/1006/Planning-Ordinance (Includes all relevant criteria such as Planning Area, Permitted Uses & Building Types)							
 Section 2 Planning Areas							
 Permitted Use/Add'l Req. Not Permitted							
 Permitted Building Type Not Permitted							
Meets Setback Criteria Does Not Meet							
 Meets Open Space Criteria Does Not Meet							
 Meets Density Criteria Does Not Meet							
 Section 4 Design Standards							
 General Site Design Criteria (4.3)							
 General Building Design Criteria (4.4)							
Specific Building Type Criteria (4.5)							
 Existing Industrial Campuses Criteria (4.6)							
 Renovation of Existing Structures Criteria (4.7)							
 Section 8 Parking & Driveways							
 Section 9 Tree Preservation, Landscaping & Screening							
 Section 10 Lighting							
Section 22 Local Historic District Guidelines							



DAVIDSON GATE WAY CENTER (Name of Project)

Application Requirements

Date Received	
	Application Fee per Town of Davidson Fee Schedule
	Contact Information
	General Statement of Intent (Use, building type, approx. square footage, height, design features)
	Statement of Compliance with Section 2
	Master Plan or Conditional Planning Area (Including all documents, plans, maps, and conditions of approval)
	Environmental Inventory in accordance with Section 14.15.1 (Including adjacent properties and buildings)
<u> </u>	General Description (Including a description and color photographs to existing / adjacent site)
·	Site Schematic Design in accordance with Section 14.15.7
	Building Schematic Design in accordance with Section 14.15.3 (Including rendered elevations of each façade per 14.15.3 C)
	Landscape Schematic Design in accordance with Section 14.15.5
	Building Perspective
	Building Materials/Colors (Roofing, siding, doors, windows, etc.)
	pplicant, I hereby confirm that all the required materials for this application are
authe	atic and have been submitted to the Town of Davidson Planning Department.
	7.31.2019.
	Applicant's Signature Date

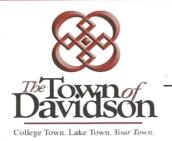

DAVIDSON GATEWAY CENTER

(Name of Project)

Development Process

Date Completed		Outline of Steps & Checklist
	1.	nitial Meeting
	2.	Application and Fee
	3.	Design Review Board Preliminary Review (Informational)
	4.	Planning Director Site Schematic Design Review
	5.	Design Review Board Approval
	6.	Building Construction Documents
	7. 9	Site and Landscape Construction Documents
	8. /	Architect's Letter of Verification (Construction Documents)
	9.	Building Permit Approval
		. CD Submittal with PDF of All Approved Documents uired within 45 Days of Approval
	11	. Architect's Letter of Verification (Construction/As-Built)
	12	. Certificate of Occupancy
T T	ote that the To	avidson Planning Ordinance Sections 14.11 Individual Building - 14.12 wn of Davidson encourages all paper submittals to be on 30% or

Davidson Gateway Preconstruction

2. 0	W	100% Waiting on report to Structures		5 4						0		9 (4		
First sees Santa		100%	%U	%0 %0	%O	%	%O	%0 %0			%O	%0		
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Finish	07/16/19	07/15/19	08/02/19	08/16/19	08/16/19		08/23/19	08/22/19	08/28/19	09/19/19	09/03/19	09/03/19	09/27/19	10/23/19
Slad	06/21/19	06/20/19	07/16/19	08/05/19	08/05/19		08/19/19	08/21/19	08/27/19	09/18/19	09/03/19	09/03/19	09/27/19	09/30/19
Puration	18d	18d	14d	10d	10d		2d	2d	2d	2d	1d	10	1d	18d
	EPM APPROVAL	KESSEL - REPORT	FND DESIGNED	FND PRICED	COORDINATE ARCH W/STRUC	STRUCTURAL DRAWINGS FINALIZED	COST FINALIZED	FYI	SUBMIT TO BANK	DRB	SUBMIT FOR SITE PERMIT	SUBMIT FOR STEEL PERMIT	SUBMIT FOR BUILDING PERMIT	PULL BLDG PERMIT
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Davidson Gateway Building – Existing Conditions


1. Existing Site (view from Davidson Gateway Drive towards the existing medical office building)



2. Existing Medical Office Building, (adjacent to subject site)



3. Existing Buildings (across Davidson Gateway Drive from subject site)

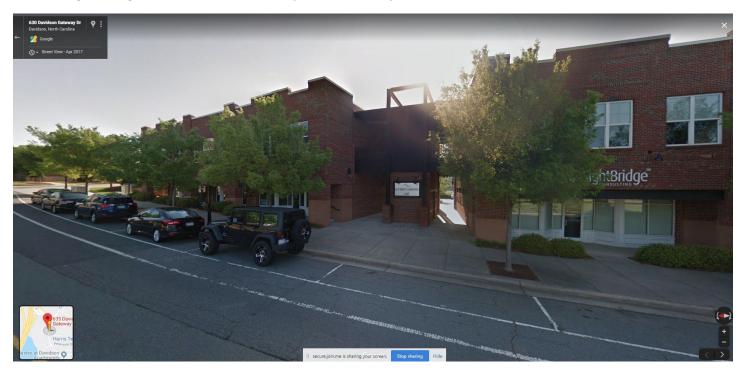

4. Existing Site (view from intersection of Davidson Gateway Drive and Gateway Crossing Drive)



DAVIDSON GATEWAY CENTER

635 DAVIDSON GATEWAY DRIVE DAVIDSON NC 28036



PROJECT CONTACTS

OWNER:

NICK LYSSIKATOS

ARCHITECT:

DAVID MARTINI-PLANK 143 VILLAGE VIEW DRIVE SUITE 203 MOORESVILLE, NC 28117 704-777-4447 DMARTINIPLANK@GMAIL.COM

STRUCTURAL ENGINNER

JIM KUNKLE STRUCTURES INC 344 ROLLING HILL RD. MOORESVILLE, NC 28117 704-664-9824 JIM@STRUCTURESINC.COM

MECHANICAL, ELECTRICAL, PLUMBING ENGINNER:

TODD CAREY AND ASSOC. 429 CANVASBACK RD. MOORESVILLE, NC 28117 704-664-9824 TODDCAREY@TODDCAREY.COM

CIVIL ENGINNER:

PAUL CARTER
EASTLAKE ENGINEERING, PLLC
470 N BROAD STREET SUITE A
MOORESVILLE, NC 28115
865-816-4557
PCARTERTN@GMAIL.COM



ARCHITECT

PROJECT TEAM:

ARCHITECT OF RECORD

David Martini - Plank, AIA

NC Registration : 5453

143 Village View Drive - Suite 203

Mooresville, NC 28117

704-777-4447

dmartiniplank@gmail.com

Architecture
Interiors

Master Planning
Development

GENERAL CONTRACTO
Kearey Builders
Ryan Kearey
2915 Charlotte Highway
Mooresville, NC 28117
980-444-6510



<u>PROJE</u>

DAVIDSON GATEWAY CENTER 635 DAVIDSON GATEWAY DRIVE DAVIDSON NC 28036

Se

Issue Date:

07/31/19


TITLE SHEET

CS-100-00

SHEET:

DAVIDSON GATEWAY CENTER PROJECT DATA:

VICINITY MAP
635 DAVIDSON GATEWAY DRIVE
DAVIDSON NC 28036

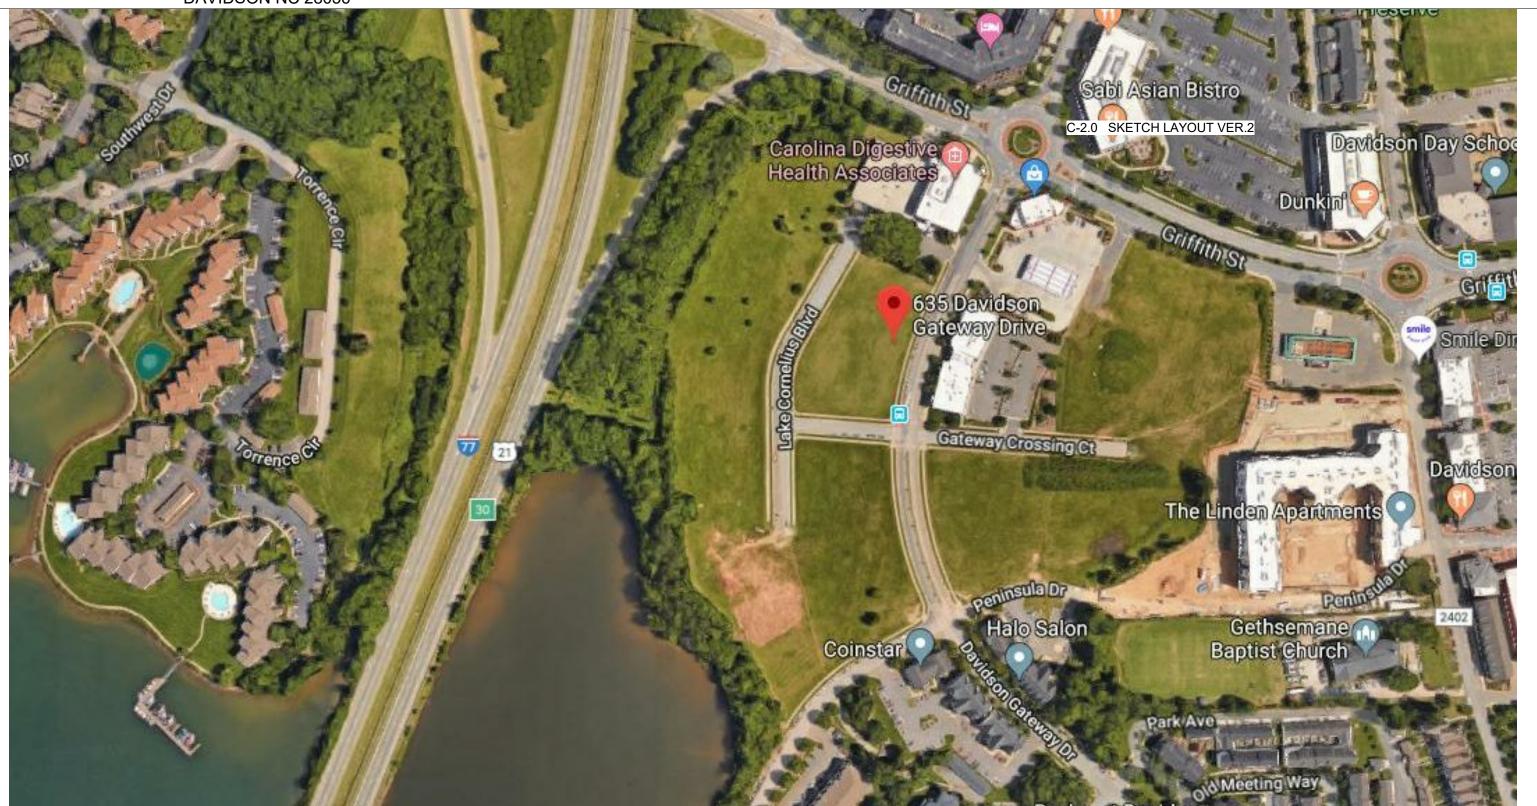



- ALL WORK SHALL BE IN ACCORDANCE WITH 2012 NORTH CAROLINA STATE BUILDING CODE & AIA A201 GENERAL CONDITIONS (LATEST EDITION)
- PRIOR TO PROJECT COMMENCEMENT, PROVIDE TO OWNERS SATISFACTION A. APPROVED ACCESS FOR CONSTRUCTION PERSONNEL, EQUIPMENT AND MATERIALS PRIOR TO CONSTRUCTION. B. APPROVED MEANS AND PATH FOR REMOVAL AND DISPOSAL OF DEBRIS OR MATERIAL FROM PROJECT SITE. C. APPROVED SECURE LOCATION(S) FOR NEW MATERIALS, MATERIALS REMOVED DURING DEMOLITION FOR REUSE IN THE NEW CONSTRUCTION AND MATERIALS TO BE RETURNED TO BUILDING STOCK. D. A VERIFIED LIST OF EXISTING MATERIAL QUALIFIED FOR REUSE IN NEW CONSTRUCTION OR RETURN
- E. LIST OF REQUIRED SIGNAGE, COMPLIANT WITH MUNICIPAL CODES, ACCESSIBILITY GUIDELINES AND
- OWNERS APPROVED PROPERTY STANDARDS SPECIFICATIONS. THE DOCUMENTS REFLECT CONDITIONS REASONABLY INTERPRETED FROM THE EXISTING VISIBLE CONDITIONS, OR FROM DRAWINGS OR INFORMATION FURNISHED BY THE OWNER. THE CONTRACTOR SHALL VISIT THE SITE AND BE RESPONSIBLE FOR VERIFYING EXISTING CONDITIONS AND THEIR IMPACT ON THE SCOPE OF THE WORK. ANY DISCREPANCIES BETWEEN EXISTING AND INDICATED CONDITIONS SHALL BE REPORTED IMMEDIATELY TO THE ARCHITECT. WORK SHALL PROCEED ONLY WITH THE ARCHITECTs APPROVAL.
- 4. SHOULD THE CONTRACTOR REQUIRE ANY ADDITIONAL DETAILS OR VERBAL CLARIFICATION NECESSARY FOR THE PROPER EXECUTION OF THE WORK, A WRITTEN REQUEST FOR INFORMATION SHALL BE SUBMITTED TO THE ARCHITECT IN A TIMELY MANOR SO AS NOT TO IMPEDE THE PROJECT SCHEDULE.
- 5. THE CONTRACTOR SHALL PAY FOR AND SECURE PERMITS, FEES, LICENSES AND INSPECTIONS NECESSARY FOR THE PROPER EXECUTION AND COMPLETION OF THE WORK UNLESS OTHERWISE INSTRUCTED BY THE ARCHITECT.
- 6. THE CONTRACTOR SHALL CARRY ALL INSURANCE IN ARTICLE II OF AIA A201, MOST RECENT EDITION. THE CONTRACTOR SHALL FILE CERTIFICATE OF INSURANCE ACCEPTABLE TO THE OWNER PRIOR TO THE COMMENCEMENT
- 7. THE CONTRACTOR SHALL BE AFFORDED ACCESS TO THE BUILDING IN ACCORDANCE WITH THE RULES AND REGULATIONS OF THE BUILDING MANAGEMENT. THE REASONABLE USE OF THE BUILDING WATER, ELECTRICITY AND HVAC AS REQUIRED FOR THE EXECUTION OF THE WORK IS AVAILABLE TO THE CONTRACTOR AT NO CHARGE TO THE CONTRACTOR. THE CONTRACTOR MAY USE THE TOILET ROOMS AS DIRECTED BY THE BUILDING MANAGEMENT.
- 8. THE CONTRACTOR SHALL BE RESPONSIBLE FOR THE PROTECTION OF ALL EXISTING WORK, ANY DAMAGE TO EXISTING WORK CAUSED AS A RESULT OF THE EXECUTION OF THIS PROJECT SHALL BE REPAIRED BY THE GENERAL CONTRACTOR, AS REQUIRED AT THE SOLE EXPENSE OF THE GENERAL CONTRACTOR.
- 9. UNLESS INSTRUCTED OTHERWISE BY THE OWNERs AGENT, THE REMOVAL AND DISPOSAL OF DEMOLITION AND/OR CONSTRUCTION MATERIAL SHALL BE THE RESPONSIBILITY OF THE GENERAL CONTRACTOR. THE CONTRACTOR SHALL KEEP THE CONSTRUCTION SITE FREE AND CLEAR OF ALL DEBRIS THROUGHOUT THE COURSE OF THE PROJECT. UPON COMPLETION OF THE WORK, THE ENTIRE CONSTRUCTION AREA, INCLUDING THE INTERIOR FACE OF GLAZING IS TO BE

THOROUGHLY CLEANED.

- 10. THE MECHANICAL, PLUMBING, FIRE PROTECTION, ELECTRICAL AND FIRE ALARM WORK PRESENTED IN THESE DOCUMENTS IS INTENDED TO SHOW THE GENERAL ARRANGEMENT AND LOCATION OF EXISTSING AND PROPOSED FIXTURES AND ACCESSORIES. THE CONTRACTOR SHALL MODIFY EXISTING ELECTRICAL, PLUMBING, MECHANICAL AND FIRE PROTECTION SYSTEMS AS REQUIRED TO ACCOMMODATE THE NEW LAYOUT AND AS REQUIRED TO MEET ALL APPLICABLE BUILDING CODES.
- 11. THE GENERAL CONTRACTOR SHALL BE RESPONSIBLE FOR COORDINATING THE WORK OF ALL ENGINEERS PROVIDING DESIGN AND SPECIFICATION INFORMATION FOR THE MECHANICAL, PLUMBING, FIRE PROTECTION AND ELECTRICAL
- 12. ALL WORK SHALL BE GUARANTEED BY THE CONTRACTOR FOR A PERIOD OF ONE YEAR AFTER SUBSTANTIAL COMPLETION OF THE WORK. THIS GUARANTEE SHALL COVER ALL WORK BY THE GENERAL CONTRACTOR AND SUB -CONTRACTORS. ANY DEFECTS IDENTIFIED DURING THE GUARANTEE PERIOD SHALL BE REPAIRED, AS REQUIRED, AT NO ADDITIONAL COST TO THE OWNERS.
- 13. CONSTRUCTION DOCUMENTS HAVE BEEN DEVELOPED TO ACHIEVE GENERAL COMPLIANCE WITH CURRENTLY APPLIED ACCESSIBILITY GUIDELINES. THE OWNERs AND IT'S RETAINED CONSULTANTS DO NOT ASSUME ANY LIABILITY REGARDING DECISIONS, AGREEMENTS, WARRANTIES, GUARANTEES AND INTERPRETATIONS MADE IN THE FIELD, THAT RESULT IN DEVIATION FROM THE EXISTING ACCESSIBILITY GUIDELINES AS THEY APPLY TO THESE CONTRACT
- DOCUMENTS. 14. ALL TRADE SHALL REVIEW ALL SHEETS IN THE CONSTRUCTION DOCUMENT SET FOR COORDINATION PURPOSES.
- 15. THE GENERAL CONTRACTOR SHALL PROVIDE WRITTEN NOTICE FOR CLAIMS OF ADDITIONAL OWNER COST DUE TO REVISIONS TO THE CONSTRUCTION DOCUMENTS IN A TIMELY MANNER TO THE ARCHITECT FOR REVIEW PRIOR TO EXECUTING THE WORK.
- 16. CONTRACTOR ASSUMES RESPONSIBILITY FOR ANY EXPENSE INCURRED (INCLUDING CONSTRUCTION SCHEDULE DELAYS). DUE TO NON DISCLOSURE OF DISCOVERED DISCREPANCIES OR CONFLICTS WITHIN CONSTRUCTION DOCUMENTS OR RELATED TO EXISTING CONDITIONS IN A TIMELY MANOR.
- 17. A QUALIFIED SUPERINTENDENT SHALL SUPERVISE THE PROJECT SITE. COORDINATE AND ATTEND GOVERNMENT INSPECTIONS, COORDINATE WORK AMONG TRADES AND MAINTAIN QUALITY OF MATERIAL AND CRAFTSMANSHIP.
- 18. CONTRACTOR ASSUMES RESPONSIBILITY FOR ANY EXPENSE INCURRED (INCLUDING CONSTRUCTION SCHEDULE DELAYS) DUE TO CONSTRUCTION PERSONNEL SCALING DRAWINGS FOR DIMENSIONAL INFORMATION AS IT PERTAINS TO THEIR WORK, DO NOT SCALE DRAWINGS. IF DIMENSIONS ARE IN QUESTION, OBTAIN CLARIFICATION FROM THE ARCHITECT

- 19. THE CONTRACTOR SHALL NOT BE ENTITLED TO ADDITIONAL FEES FOR PROVIDING OPENINGS IN PARTITIONS FOR
- 20. CONTRACTOR SHALL SECURE & PROTECT THE AREA RESTRICTING UNAUTHORIZED ACCESS AND SHALL SUFFICIENTLY
- 21. ALL STUDS, CEILING FURRING AND FRAMING MEMBERS SHALL BE PLACED AS TO AVOID INTERFERENCE WITH LOCATIONS OF CASEWORK, RECESSED LIGHTING FIXTURES, PIPING, DUCT WORK AND THE LIKE.
- 22. ALL PENETRATIONS THROUGH FLOOR SLAB S SUCH AS PIPING, CONDUITS, DUCTS, PNEUMATIC TUBES, ETC. SHALL BE PACKED AND SEALED WITH APPROPRIATE FIRE-RATED MATERIAL IN COMPLIANCE WITH APPLICABLE BUILDING CODES. PENETRATIONS SHALL BE SEALED TIGHT.
- 23. THE CONTRACTOR SHALL BE RESPONSIBLE FOR THE DESIGN AND INSTALLATION OF ADEQUATE SHORING AND BRACING REQUIRED FOR THE PROPER EXECUTING OF ALL WORK.
- 24. THE CONTRACTOR SHALL PERFORM A STRUCTURAL SURVEY, INCLUDING X-RAYS OR GROUND PENETRATING RADAR (GPR) OF ALL FLOOR SLABS ON GRADE AND SUPPORTING WALLS TO LOCATE EXISTING STRUCTURAL BARS, CABLES. IN-SLAB CONDUITS, UTILITIES AND OTHER INTERFERENCE THAT MAY BE IN CONFLICT WITH PROPOSED SLEEVE/PENETRATION LOCATIONS. THE X-RAY OR GPR SHALL BE PERFORMED PRIOR TO ANY CUTTING OR CHIPPING. IN THE EVENT OF CONFLICT, THE CONTRACTOR SHALL NOTIFY THE ARCHITECT AND OWNER FOR FURTHER DIRECTION.
- 25. NOISE PRODUCING WORK SHALL BE SCHEDULED WITH MANAGEMENT BEFORE 8 AM OR AFTER 6 PM. OIL, PAINT, CARPET GLUE AND OTHER ODOR PRODUCING WORK MUST BE SCHEDULED WITH MANAGEMENT FOR AFTER HOURS. BUILDING ENGINEERING MUST BE ON SITE FOR ALL AFTER HOURS WORK AT THE EXPENSE OF THE CLIENT
- 26. SYSTEMS BEING DEMOLISHED SHALL BE REMOVED BACK TO THE SOURCE. IE ELECTRICAL, TELEPHONE, DATA, PLUMBING AND HVAC. NO ABANDONED EQUIPMENT SHALL BE LEFT IN PLACE.
- 27. NEW WORK EXTENDING EXISTING CONDITIONS SHALL ALIGN WITH AND MATCH WORK EXCEPT WHERE
- OTHERWISE DIMENSIONED OR DETAILED. 28. PUBLIC AREA CORRIDORS AND CARPET MUST BE PROTECTED BY PLASTIC OR WALK OFF MASONITE MATS FROM THE
- ELEVATORS TO CONSTRUCTION SPACE (IF APPLICABLE). 29. MASONITE MUST BE USED AT ALL LOCATIONS WHERE ROLLING TRAFFIC WILL BE ROUTED.
- 30. DIMENSIONS ARE FROM THE FACE OF EXISTING FINISHED SURFACE OR NEW PARTITION SURFACE UNLESS OTHERWISE
- 31. MANAGEMENT SHALL RECEIVE A MINIMUM OF 3 DAYS NOTICE OF BUILDING SYSTEMS SHUT DOWN AND WILL BE DEPENDENT ON OWNER/AGENT APPROVAL.
- 32. ALIGNMENT INDICATION SHALL BE FINISHED SURFACE TO FINISHED SURFACE.
- 33. CENTERLINE DIMENSIONS SHALL BE MEASURED FROM CENTERLINE OF ASSEMBLY, FIXTURE OR DEVICE.
- 34. PARTITION ANGLES ARE PARALLEL, PERPENDICULAR OR 45 DEGREE ANGLES TO BUILDING PERIMETER UNLESS NOTED OTHERWISE.
- 35. ALL DIMENSIONS MARKED "CLEAR" OR "CLR" SHALL BE MAINTAINED.
- 36. CENTERLINE INDICATION AT PARTITIONS ABUTTING BUILDING ELEMENTS (MULLIONS, COLUMNS OR PIASTERS), SHALL ALIGN CENTER OF PARTITION ASSEMBLY WITH CENTER OF THE ELEMENT.
- 37. CONTRACTOR SHALL COORDINATE AND PROVIDE FIRE RETARDANT TREATED WOOD BLOCKING IN WALLS FOR MOUNTING ALL CABINETS, ALL TOILET ACCESSORIES AND ALL OTHER WALL MOUNTED ITEMS.
- 38. FIRE STOP ALL PENETRATIONS IN UL RATED PARTITIONS TO MAINTAIN/ACHIEVE LEVEL OF FIRE PROTECTION REQUIRED FOR PARTITION TYPE. FIRE STOP ALONG PERIMETER OF RATED PARTITIONS WHERE VOIDS OCCUR, SUCH AS FLOOR OR ROOF DECKING.
- 39. WHERE FACE OF A NEW PARTITION ALIGNS WITH THE FACE OF EXISTING FURRED COLUMNS OR PARTITIONS, REMOVE EXISTING CORNER BEAD, TAPE AND MUD NEW PARTITION TO EXISTING GYPSUM BOARD FOR A SMOOTH TRANSITION.
- 40. CONTRACTOR SHALL FURNISH AND INSTALL BUILDING STANDARD FIRE EXTINGUISHER CABINETS AND DEVICES PER
- 41. ALL ASPECTS OF THIS UPFIT AND SCOPE OF WORK TO MEET CURRENT ACCESSIBILITY CODES.

FIRE & EMERGENCY NOTES:

Page 19 of 45

- 1. ALL DOORS IN EXIT PATH AND ALL EXTERIOR DOORS SHALL BE EQUIPPED WITH AUTOMATIC DOOR CLOSERS.
- 2. ALL INTERIOR DOORS SHALL BE EQUIPPED WITH ADA APPROVED LEVER HANDLE HARDWARE.
- 3. ALL EXIT DOORS SHALL HAVE FREE EXITING HARDWARE OR BREAKER BARS.
- 4. RESTROOMS SHALL HAVE AUTOMATIC DOOR CLOSERS.
- 5. RESTROOMS TO BE EQUIPPED WITH STROBE AND ENUNCIATOR TIED DIRECTLY TO FIRE ALARM PULL STATIONS LOCATED AT EACH DOOR (IF APPLICABLE).
- 6. EACH EXIT DOOR SHALL HAVE IT'S OWN STROBE AND HORN MOUNTED ABOVE THE PULL STATION (PER CODE)

INDEX OF DRAWINGS

CIVIL	STRUCTURAL

ARCHITECTURAL


CS-100-00 TITLE SHEET C-101-00 PROJECT DATE AND SHEET INDEX C-102-00 ARCHITECTURAL SITE PLAN LS-100-00 APPENDIX B OC-100-00 OCCUPANCY PLANS FIRST FLOOR CONSTRUCTION PLAN A-101-00 SECOND FLOOR PLAN THIRD FLOOR PLAN FOURTH FLOOR CONSTRUCTION PLAN ROOF CONSTRUCTION PLAN FIRST FLOOR FURNITURE PLAN


A-161-00 FOURTH FLOOR FURNITURE PLAN A-200-00 **ELEVATIONS ELEVATIONS** A-300-00 BUILDING SECTION A-350-00 WALL SECTIONS

Issue Date:

PROJECT DATE AND SHEET **INDEX** C-101-00

07/31/19

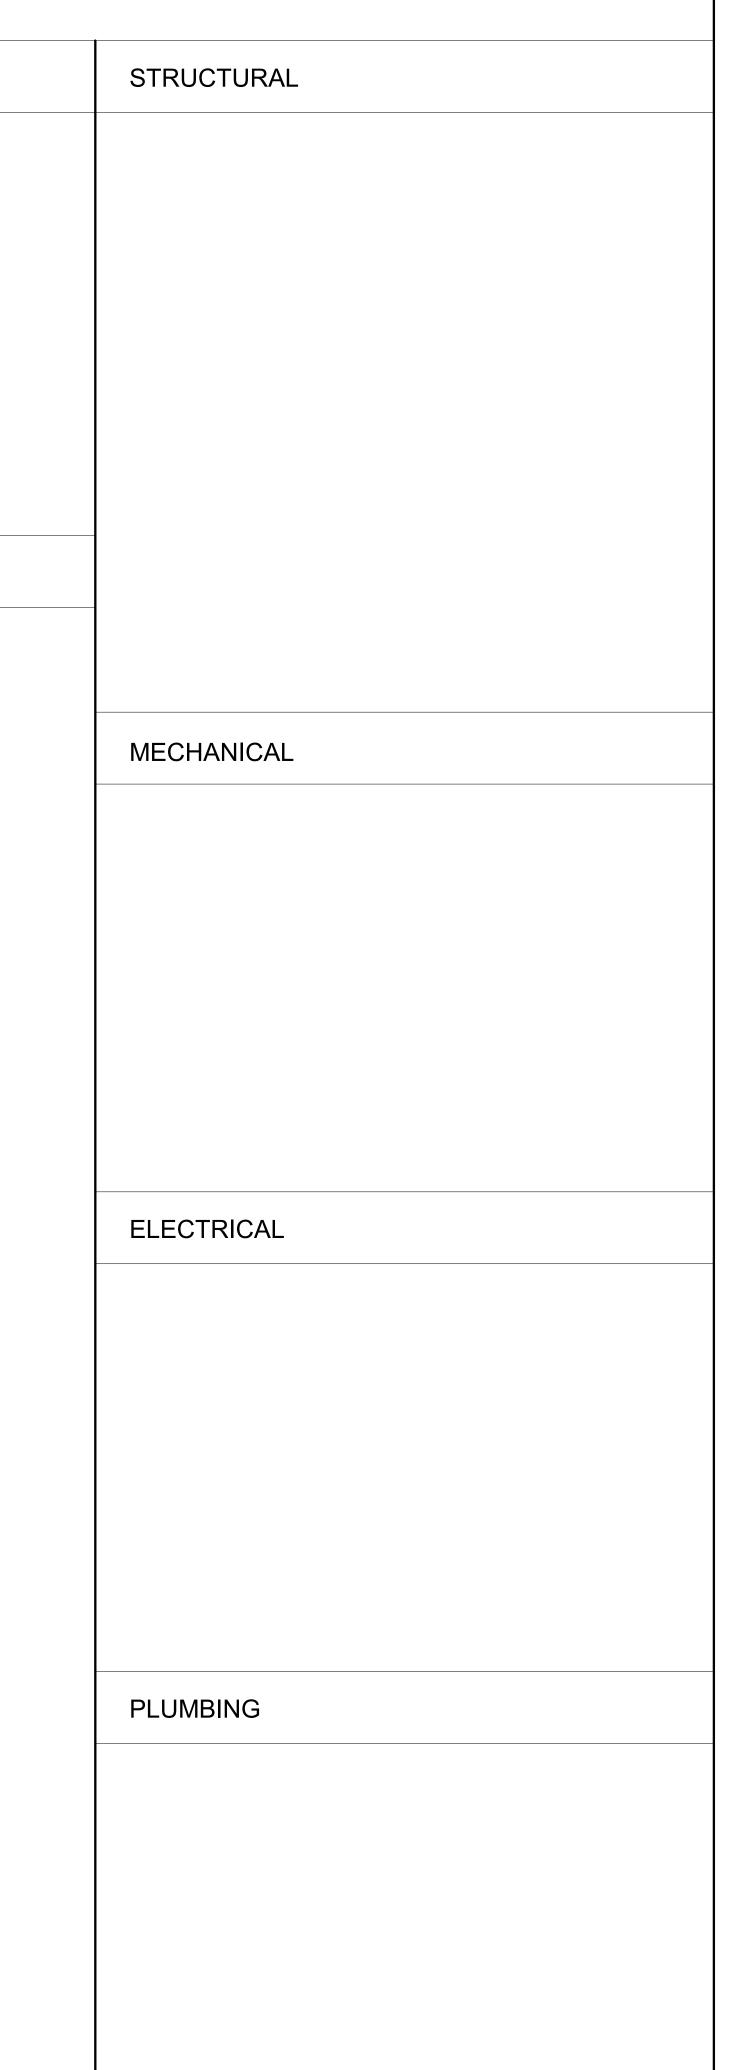

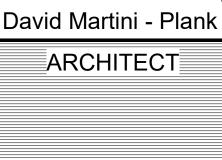


PROJECT TEAM: ARCHITECT OF RECORD David Martini - Plank, AIA NC Registration: 5453 143 Village View Drive - Suite 203 Mooresville, NC 28117 704-777-4447 dmartiniplank@gmail.com Architecture Interiors Master Planning Development

GENERAL CONTRACTOR Kearey Builders Ryan Kearey 2915 Charlotte Highway Mooresville, NC 28117 980-444-6510



DAVIDSON GATEWAY CENTER **635 DAVIDSON GATEWAY DRIVE DAVIDSON NC 28036**

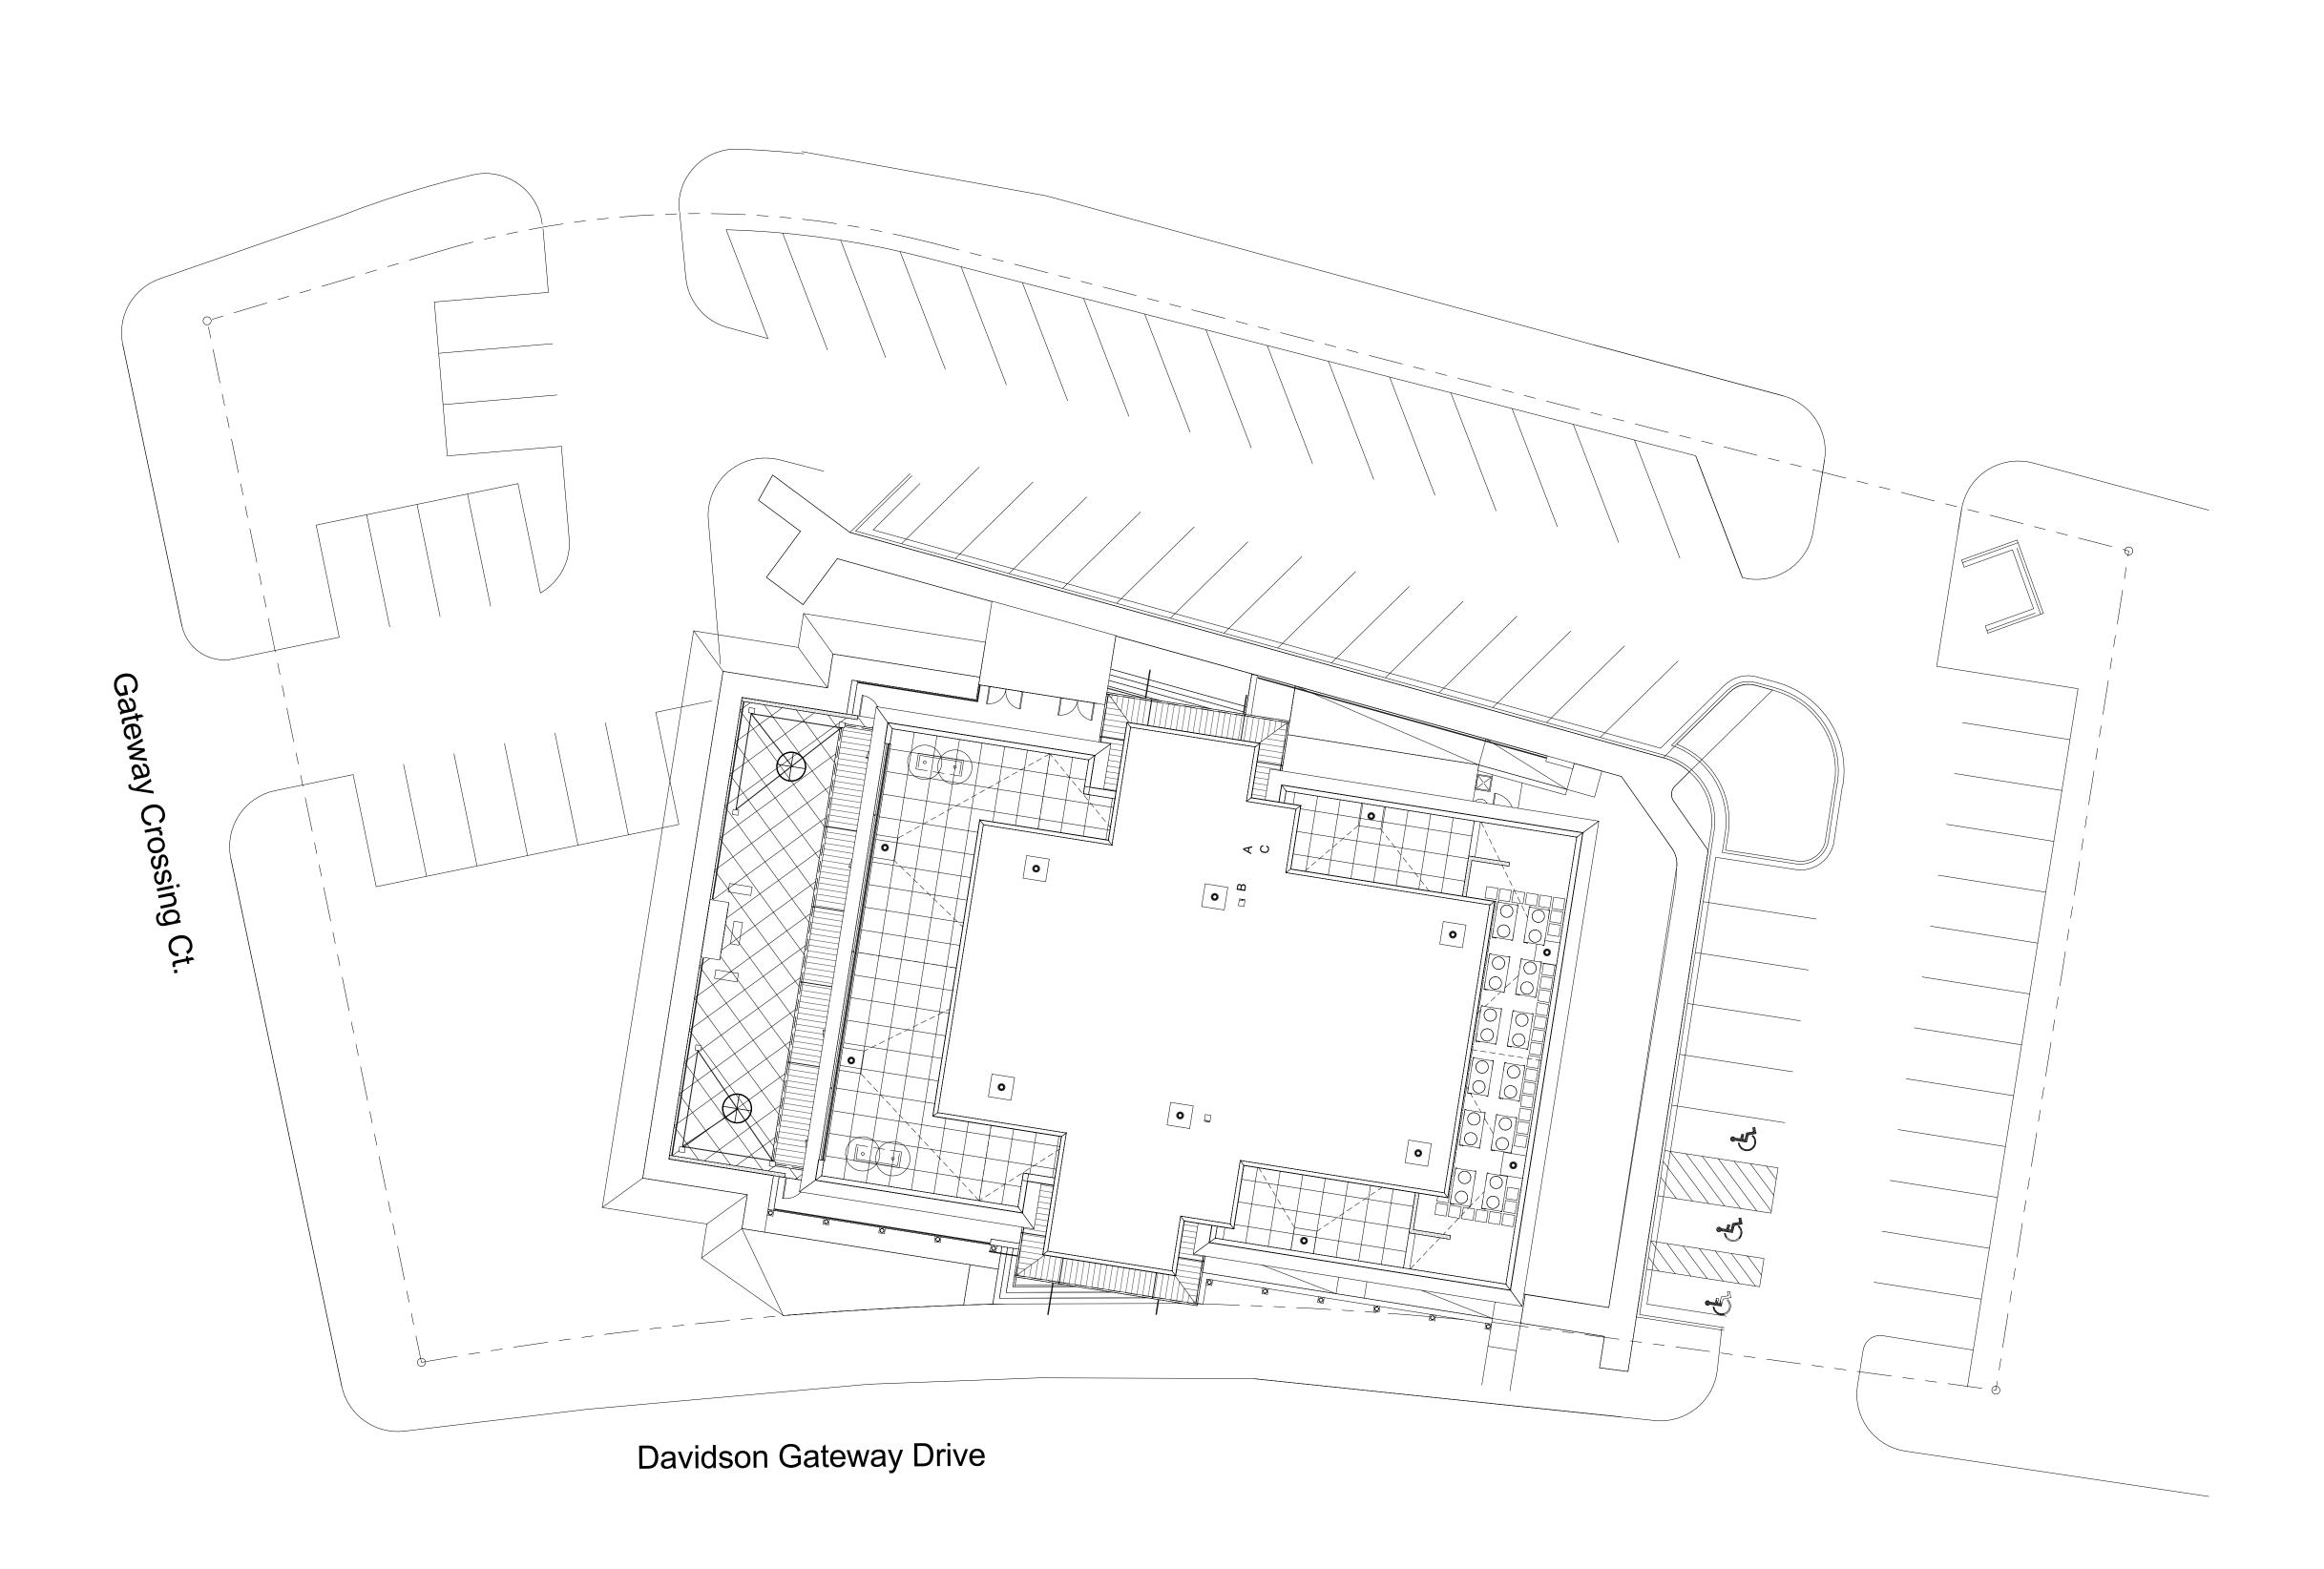



ARCHITECT

PROJECT TEAM:

ARCHITECT OF RECORD

David Martini - Plank, AIA

NC Registration : 5453

143 Village View Drive - Suite 203

Mooresville, NC 28117

704-777-4447

dmartiniplank@gmail.com

Architecture
Interiors

Master Planning
Development

GENERAL CONTRACTOR
Kearey Builders
Ryan Kearey
2915 Charlotte Highway
Mooresville, NC 28117
980-444-6510



PROJECT

DAVIDSON GATEWAY CENTER 635 DAVIDSON GATEWAY DRIVE DAVIDSON NC 28036

Sea

Issue Date:

07/31/19

ARCHITECTURAL SITE PLAN

C-102-00

SHEET:

2 ARCHITECTURAL SITE PLAN 1/16" = 1'-0"

2018 APPENDIX B

BUILDING CODE SUMMARY FOR ALL COMMERCIAL PROJECTS

(EXCEPT 1 AND 2-FAMILY DWELLINGS AND TOWNHOUSES) (Reproduce the following data on the building plans sheet 1 or 2)

	avidson Gateway Drive					
Owner/Authoriz	zed Agent: David Martini-Pla	ank Phone #	(704) 777 - 4447	E-Mail dmartiniplank@gmail.com		
Owned By: Priv	vate Nick Lyssikatos					
Code Enforcem	ent Jurisdiction: County	_Mecklenburg				
		37000				
CONTACT:						
DESIGNER	FIRM	NAME	LICENSE #	TELEPHONE # E-MAIL		
Architectural	David Martini-Plank, Arch	David Martini-Plank		(704) 777-4447 dmartiniplank@gmail.com		
Civil	Eastlake PLLC	Paul Carter	1317	(865) 816 4557 pcartern@yahoo.com		
Electrical	Todd Carey and Assoc.	Todd Carey	09079	(704) 664 9824 toddcarey@toddcarey.com		
Fire Alarm	Todd Carey and Assoc.	Todd Carey	09079	(704) 664 9824 toddcarey@toddcarey.com		
Plumbing	Todd Carey and Assoc.	Todd Carey	09079	(704) 664 9824 toddcarey@toddcarey.com		
Mechanical Todd Carey and Assoc.		Todd Carey	09079	(704) 664 9824 toddcarey@toddcarey.com		
	pipe Todd Carey and Assoc.		09079	(704) 664 9824 toddcarey@toddcarey.com		
Structural	Structures Inc	Jim Kunkle	14663	704 662 6844 jim@sturcturesinc.com		
				()		
	s > 5' High			(_)		
Other						
Other		Is such as truss, pr	recast, pre-enginee	()		
Other ("Other" should	l include firms and individua		recast, pre-enginee			
Other ("Other" should 2018 NC BUIL		g	recast, pre-enginee			
Other ("Other" should 2018 NC BUIL 2018 NC EXIS	DING CODE: New Building TING BUILDING CODE:	ng <u>N/A N/A</u>	N/A	ered, interior designers, etc.)		
Other ("Other" should 2018 NC BUIL 2018 NC EXIS CONSTRU	DING CODE: New Building TING BUILDING CODE:	g <u>N/A N/A</u> CURREN	<u>N/A</u> IT OCCUPANCY	ered, interior designers, etc.)		
Other ("Other" should 2018 NC BUIL 2018 NC EXIS CONSTRU RENOVA	DING CODE: New Building TING BUILDING CODE: UCTED: (date)	g <u>N/A N/A</u> CURREN PROPOS	<u>N/A</u> IT OCCUPANCY ED OCCUPANC	red, interior designers, etc.) (S) (Ch. 3): Y(S) (Ch. 3):		
Other ("Other" should 2018 NC BUIL 2018 NC EXIS CONSTRU	DING CODE: New Building TING BUILDING CODE:	g <u>N/A N/A</u> CURREN	<u>N/A</u> IT OCCUPANCY	ered, interior designers, etc.)		
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Other ("Other" should 2018 NC BUIL 2018 NC EXIS CONSTRU RENOVA OCCUPANCY	Linclude firms and individual DING CODE: New Building TING BUILDING CODE: UCTED: (date)TED: (date)TED: (date)TOTALLE TO THE TOTALLE TO	g <u>N/A N/A</u> CURREN PROPOS	<u>N/A</u> IT OCCUPANCY ED OCCUPANC	(S) (Ch. 3):		
Other ("Other" should 2018 NC BUIL 2018 NC EXIS CONSTRU RENOVA OCCUPANCY BASIC BUILD Construction T	DING CODE: New Building TING BUILDING CODE: UCTED: (date) TED: (date) CATEGORY (Table 1604) DING DATA Type: II-A	g <u>N/A N/A</u> CURREN PROPOS	<u>N/A</u> IT OCCUPANCY ED OCCUPANC	red, interior designers, etc.) (S) (Ch. 3): Y(S) (Ch. 3):		
Other ("Other" should 2018 NC BUIL 2018 NC EXIS CONSTRU RENOVA OCCUPANCY BASIC BUILD Construction T Sprinklers: Ye.	DING CODE: New Building TING BUILDING CODE: UCTED: (date) TED: (date) CATEGORY (Table 1604. DING DATA Type: II-A S NFPA 13	g <u>N/A N/A</u> CURREN PROPOS	<u>N/A</u> IT OCCUPANCY ED OCCUPANC	(S) (Ch. 3):		
Other ("Other" should 2018 NC BUIL 2018 NC EXIS CONSTRU RENOVA' OCCUPANCY BASIC BUILD	Linclude firms and individual DING CODE: New Building TING BUILDING CODE: UCTED: (date) TED: (date) CATEGORY (Table 1604. DING DATA Type: II-A s NFPA 13 ass II - Wet	g N/A N/A CURREN PROPOS 5): Current: N/A	<u>N/A</u> IT OCCUPANCY ED OCCUPANC	red, interior designers, etc.) (S) (Ch. 3): Y(S) (Ch. 3):		

110000000000000000000000000000000000000

Gross Building Area Table

NEW (SQ FT)

SUB-TOTAL

Primary Occupancy Classification(s): Busniess Assembly - A-2 N/A N/A N/A

ALLOWABLE AREA

2018 NC Administrative Code and Policies

EXISTING (SQ FT)

4th Floor 3rd Floor

Incidental Uses (Table 509): N/A	
Special Uses (Chapter 4 – List Code Section	ons): N/A
Special Provisions: (Chapter 5 – List Cod	le Sections): N/A
Mixed Occupancy: Yes Separation: 1 Hr	Exception:
Separated Use (508.4) - See below for	area calculations for each story, the area of the occupancy shall be such
that the su	m of the ratios of the actual floor area of each use divided by the
	g c 1 1 1 1 1 1 1 1 1 1 1 1 1 1 1 1 1 1
allowable	floor area for each use shall not exceed 1.
	+ Actual Area of Occupancy B $Allowed blo Area of Occupancy B$ ≤ 1

-		+		=	≤ 1.00
STORY NO.	DESCRIPTION AND USE	(A) BLDG AREA PER STORY (ACTUAL)	(B) TABLE 506.2 ⁴ AREA	(C) AREA FOR FRONTAGE INCREASE ^{1,5}	(D) ALLOWABLE AREA PER STORY OR UNLIMITED ^{2,3}
1	Restaurant A-2	10373 SF	46,500	N/A	11,625 SF
2	Business B (tenant)	9931 SF	46,500	N/A	11,625 SF
3	Business B (tenant)	9934 SF	46,500	N/A	11,625 SF
4	Event Space A-2	9933 SF	46.500	N/A	11.625 SF

¹ Frontage area increases from Section 506.2 are computed thus:

- a. Perimeter which fronts a public way or open space having 20 feet minimum width = _____ (F)
- b. Total Building Perimeter = _____(P)
 c. Ratio (F/P) = _____(F/P)
- d. W = Minimum width of public way = _____(W)
- e. Percent of frontage increase $I_f = 100 [F/P 0.25] \times W/30 =$ _____(%) ² Unlimited area applicable under conditions of Section 507.
- ³ Maximum Building Area = total number of stories in the building x D (maximum3 stories) (506.2).
- ⁴ The maximum area of open parking garages must comply with Table 406.5.4. The maximum area of air traffic control towers must comply with Table 412.3.1.

⁵ Frontage increase is based on the unsprinklered area value in Table 506.2.

ALLOWABLE HEIGHT

	ALLOWABLE	SHOWN ON PLANS	CODE REFERENCE
Building Height in Feet (Table 504.3)	85 Feet	57'-6"	
Building Height in Stories (Table 504.4)	4	4	

FIRE PROTECTION REQUIREMENTS

BUILDING ELEMENT	FIRE		RATING	DETAIL#	DESIGN#	SHEET # FOR	SHEET #
	SEPARATION DISTANCE (FEET)	REQ'D	PROVIDED (W/* REDUCTION)	AND SHEET#	FOR RATED ASSEMBLY	RATED PENETRATION	FOR RATED JOINTS
Structural Frame, including columns, girders, trusses		1	1				
Bearing Walls							
Exterior							
North							
East				é			
West							
South		Ĭ					
Interior		ě Ú		ő			

2018 NC Administrative Code and Policies

Nonbearing Walls and Partitions Exterior walls			3			
North	> 30'-0"	0	0			i
East	> 30'-0"	0	0			
West	> 30'-0"	0	0			
South	> 30'-0"	0	0		T i	
Interior walls and partitions		0				
Floor Construction Including supporting bear and joists	ms	1	1			
Floor Ceiling Assembly						
Columns Supporting Floors		1	1			
Roof Construction, including supporting beams and joists		1	1			
Roof Ceiling Assembly						
Columns Supporting Roof						
Shaft Enclosures - Exit		2	2	UL937		
Shaft Enclosures - Other		2	2	UL937		
Corridor Separation						
Occupancy/Fire Barrier Sep	Occupancy/Fire Barrier Separation		1			
Party/Fire Wall Separation	Party/Fire Wall Separation					_
Smoke Barrier Separation	_					
Smoke Partition			V			
Tenant/Dwelling Unit/ Sleeping Unit Separation						
Incidental Use Separation						

* Indicate section number permitting reduction

DEDCENTA CE OF WALL OBENING CALCULATIONS
PERCENTAGE OF WALL OPENING CALCULATIONS

FIRE SEPARATION DISTANCE (FEET) FROM PROPERTY LINES	DEGREE OF OPENINGS PROTECTION (TABLE 705.8)	ALLOWABLE AREA (%)	ACTUAL SHOWN ON PLANS (%)
	-		

LIFE SAFETY SYSTEM REQUIREMENTS

Emergency Lighting:	Yes
Exit Signs:	Yes
Fire Alarm:	Yes
Smoke Detection Systems:	Yes
Carbon Monoxide Detection:	Yes

LIFE SAFETY PLAN REQUIREMENTS

Life Safety Plan Sheet #:	LS-100.00
Fire and/or smoke ra	ted wall locations (Chapter 7)

Assumed and real property line locations (if not on the site plan)

2018 NC Administrative Code and Policies

- Exterior wall opening area with respect to distance to assumed property lines (705.8)
- Occupancy Use for each area as it relates to occupant load calculation (Table 1004.1.2) Occupant loads for each area
- Exit access travel distances (1017) Common path of travel distances (Tables 1006.2.1 & 1006.3.2(1))
- Dead end lengths (1020.4)
- Clear exit widths for each exit door
- Maximum calculated occupant load capacity each exit door can accommodate based on egress width (1005.3) Actual occupant load for each exit door
- A separate schematic plan indicating where fire rated floor/ceiling and/or roof structure is provided for
- purposes of occupancy separation Location of doors with panic hardware (1010.1.10)
- Location of doors with delayed egress locks and the amount of delay (1010.1.9.7)
- Location of doors with electromagnetic egress locks (1010.1.9.9)
- Location of doors equipped with hold-open devices
- Location of emergency escape windows (1030) ☐ The square footage of each fire area (202)
- ☐ The square footage of each smoke compartment for Occupancy Classification I-2 (407.5)
- Note any code exceptions or table notes that may have been utilized regarding the items above

ACCESSIBLE DWELLING UNITS

TOTAL UNITS	Accessible Units Required	ACCESSIBLE UNITS PROVIDED	TYPE A UNITS REQUIRED	TYPE A UNITS PROVIDED	TYPE B UNITS REQUIRED	TYPE B UNITS PROVIDED	TOTAL ACCESSIBLE UNITS PROVIDED
----------------	---------------------------------	---------------------------------	-----------------------------	-----------------------	-----------------------------	-----------------------------	---------------------------------------

ACCESSIBLE PARKING (SECTION 1106)

	TOTAL#
132 ACE33 0 ACE33	ACCESSIBLE
	PROVIDED
TOTAL	

PLUMBING FIXTURE REQUIREMENTS

USE	ν	VATERCLOSI	ETS	URINALS		LAVATORIE	S	SHOWERS	DRINKING	FOUNTAINS
	MALE	FEMALE	UNISEX		MALE	FEMALE	UNISEX	/TUBS	REGULAR	ACCESSIBLE
Bus.	4	6		2	4	4				
A-2	3	6		4	5	5				
REQ'D	9	9			3	3			1	

SPECIAL APPROVALS

Special approval: (Local Jurisdiction, Department of Insurance, OSC, DPI, DHHS, etc., describe below)

2018 NC Administrative Code and Policies

ENERGY SUMMARY

ENERGY REQUIREMENTS: The following data shall be considered minimum and any special attribute required to meet the energy code shall also be provided. Each Designer shall furnish the required portions of the project information for the plan data sheet. If performance method, state the annual energy cost for the standard reference design vs annual energy cost for the proposed design.

Existing building envelope complies with code: Select one

Exempt Building: Select one Provide code or statutory reference:

Climate Zone: Select one

Method of Compliance: Select one (If "Other" specify source here)_

THERMAL ENVELOPE (Prescriptive method only)

Roof/ceiling Assembly (each assembly) Description of assembly: U-Value of total assembly: R-Value of insulation:

total square footage of skylights in each assembly:

U-Value of skylight:

Skylights in each assembly:

Exterior Walls (each assembly) Description of assembly: U-Value of total assembly: R-Value of insulation: Openings (windows or doors with glazing) U-Value of assembly:

Solar heat gain coefficient:

Door R-Values: Walls below grade (each assembly)

projection factor:

Description of assembly: U-Value of total assembly: R-Value of insulation:

Floors over unconditioned space (each assembly)

Description of assembly: U-Value of total assembly: R-Value of insulation:

Floors slab on grade

Description of assembly: U-Value of total assembly: R-Value of insulation: Horizontal/vertical requirement: slab heated:

2018 NC Administrative Code and Policies

2018 APPENDIX B

BUILDING CODE SUMMARY FOR ALL COMMERCIAL PROJECTS

STRUCTURAL DESIGN (PROVIDE ON THE STRUCTURAL SHEETS IF APPLICABLE) DESIGN LOADS:

Importance Factors: Wind (I_w) <u>Select one</u> Snow (I_S) Select one Seismic (I_E) Select one

Live Loads: Mezzanine

Ground Snow Load:

_____ mph (ASCE-7) Wind Load: Basic Wind Speed Exposure Category Select one

SEISMIC DESIGN CATEGORY: Select one

Provide the following Seismic Design Parameters: Occupancy Category (Table 1604.5) Select one Spectral Response Acceleration S₈______%g

Site Classification (ASCE 7) Select one Data Source: Select one Basic structural system Select one

Analysis Procedure: Select one Architectural, Mechanical, Components anchored? Select one

LATERAL DESIGN CONTROL: Select one

2018 NC Administrative Code and Policies

SOIL BEARING CAPACITIES:

Select one _____ psf
Pile size, type, and capacity ____

2018 APPENDIX B BUILDING CODE SUMMARY FOR ALL COMMERCIAL PROJECTS

MECHANICAL DESIGN (PROVIDE ON THE MECHANICAL SHEETS IF APPLICABLE)

MECHANICAL SUMMARY

MECHANICAL SYSTEMS, SERVICE SYSTEMS AND EQUIPMENT

Thermal Zone winter dry bulb: summer dry bulb:_____ Interior design conditions winter dry bulb: __ summer dry bulb:_____ relative humidity: ___ Building heating load: Building cooling load:

Mechanical Spacing Conditioning System Unitary

description of unit: heating efficiency: cooling efficiency: size category of unit: Size category. If oversized, state reason.: Chiller

Size category. If oversized, state reason.:

List equipment efficiencies:

2018 APPENDIX B

BUILDING CODE SUMMARY FOR ALL COMMERCIAL PROJECTS ELECTRICAL DESIGN (PROVIDE ON THE ELECTRICAL SHEETS IF APPLICABLE)

ELECTRICAL SUMMARY

ELECTRICAL SYSTEM AND EQUIPMENT

Method of Compliance: Select one Lighting schedule (each fixture type) lamp type required in fixture

number of lamps in fixture ballast type used in the fixture

number of ballasts in fixture total wattage per fixture

total interior wattage specified vs. allowed (whole building or space by space) total exterior wattage specified vs. allowed

Additional Efficiency Package Options (When using the 2018 NCECC; not required for ASHRAE 90.1)

C406.3 Reduced Lighting Power Density

C406.4 Enhanced Digital Lighting Controls C406.5 On-Site Renewable Energy C406.6 Dedicated Outdoor Air System C406.7 Reduced Energy Use in Service Water Heating

C406.2 More Efficient HVAC Equipment Performance

2018 NC Administrative Code and Policies

Issue Date:

07/31/19

APPENDIX B

David Martini - Plank

ARCHITECT

PROJECT TEAM:

ARCHITECT OF RECORD

143 Village View Drive - Suite 203

David Martini - Plank, AIA

NC Registration: 5453

Mooresville, NC 28117

dmartiniplank@gmail.com

GENERAL CONTRACTOR

DAVIDSON GATEWAY CENTER

DAVIDSON NC 28036

635 DAVIDSON GATEWAY DRIVE

2915 Charlotte Highway

Mooresville, NC 28117

704-777-4447

Architecture

Master Planning

Kearey Builders

Ryan Kearey

980-444-6510

<u>PROJECT</u>


Development


Interiors

LS-100-00

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SHEET:



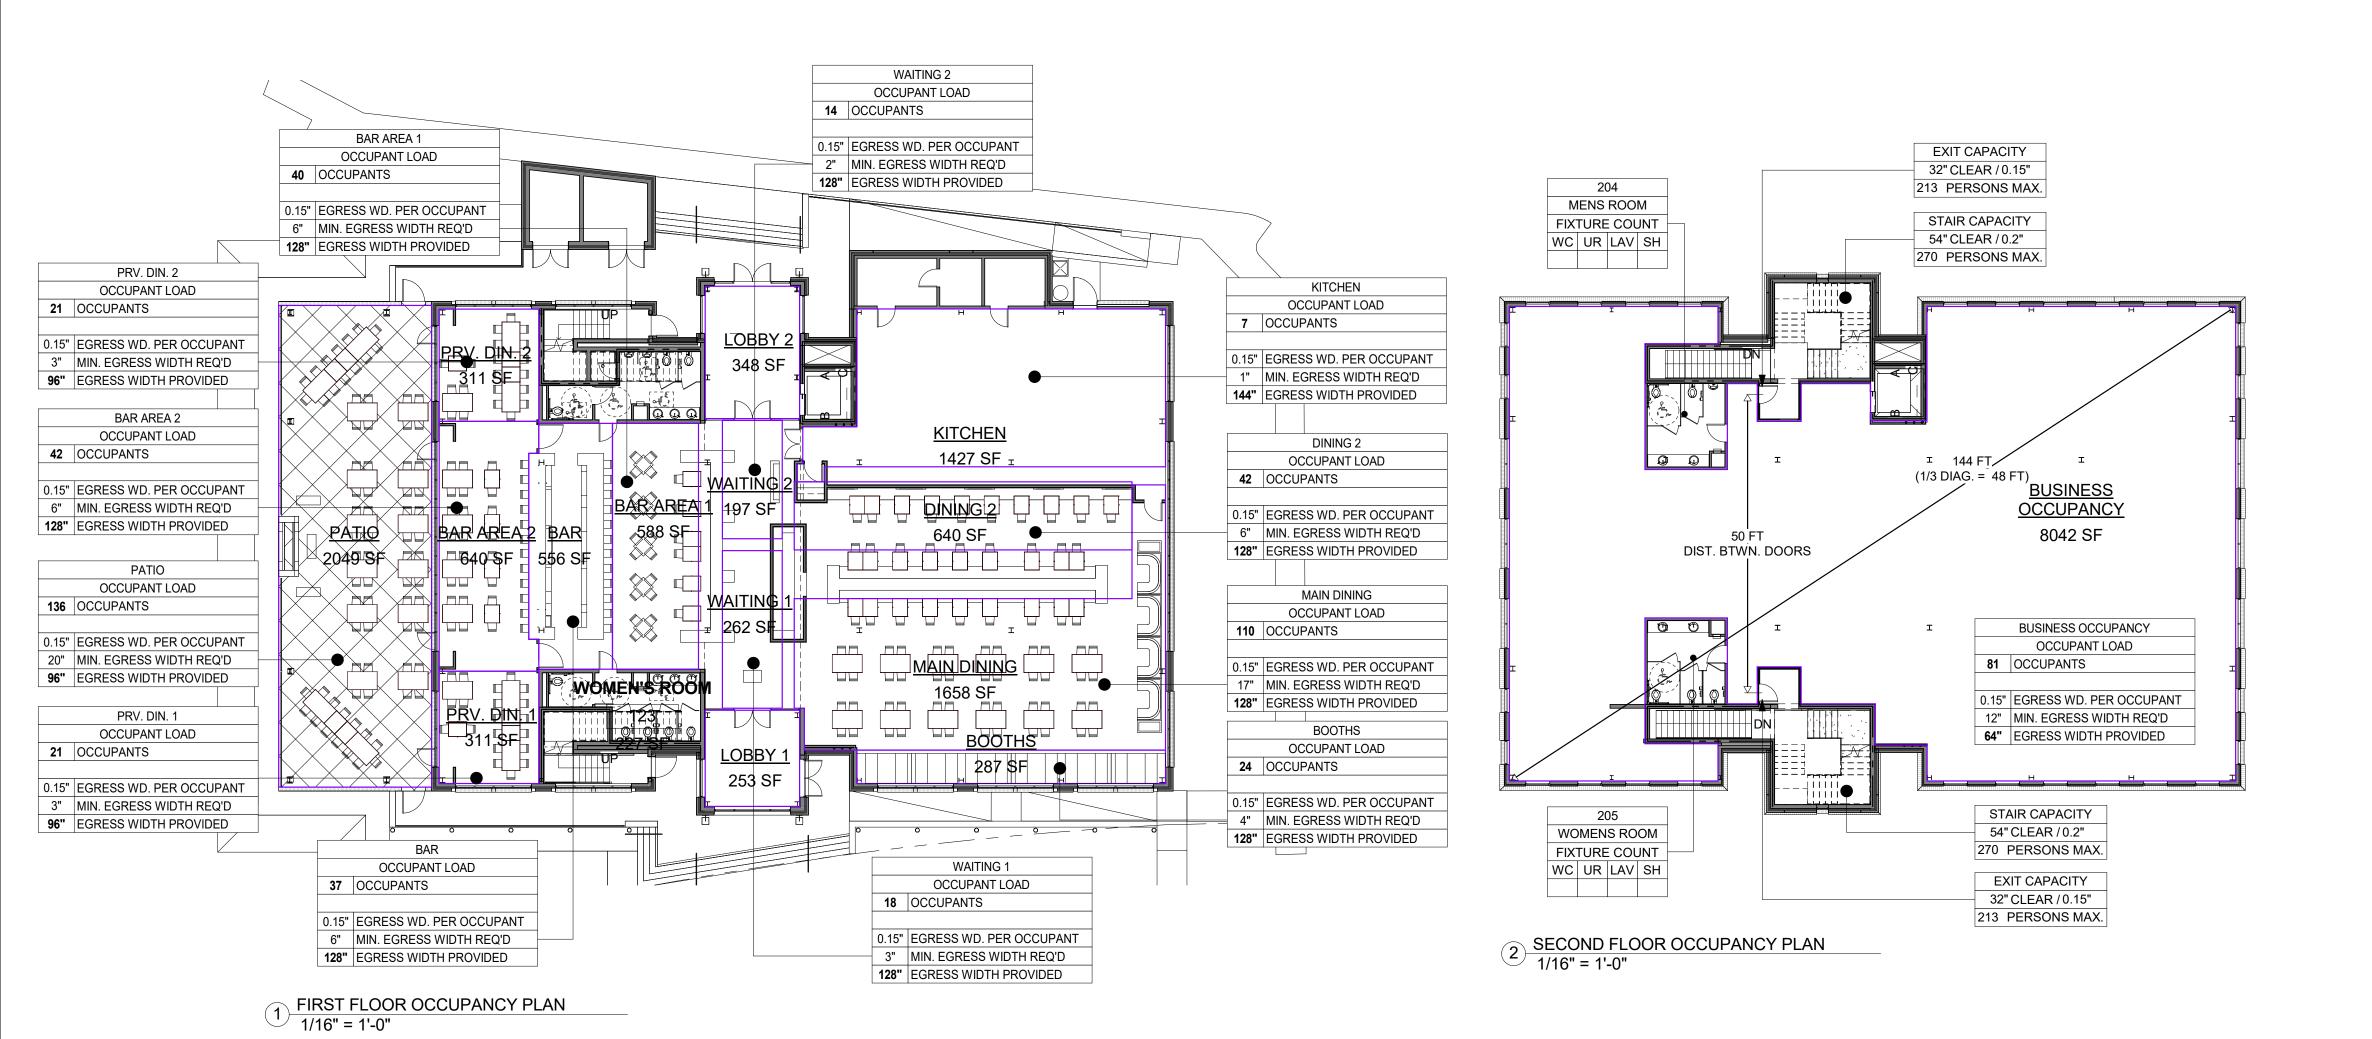

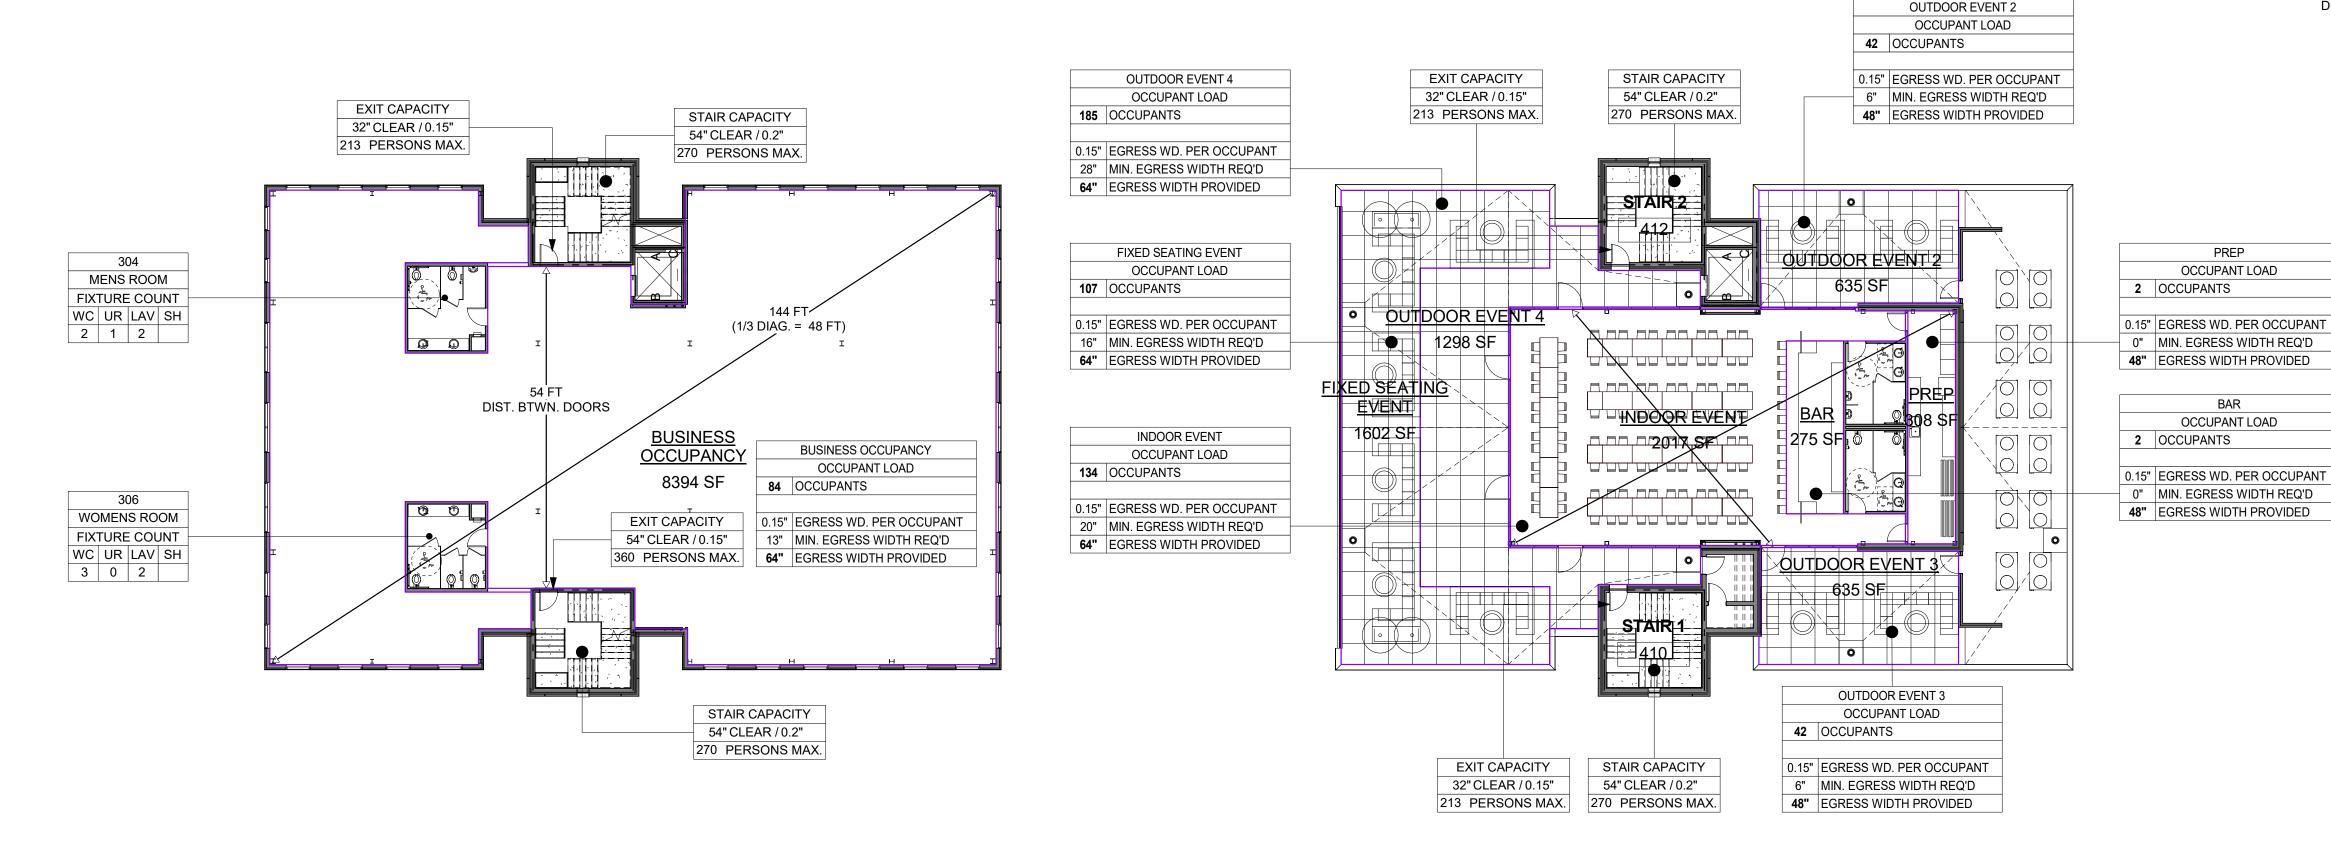THIRD FLOOR OCCUPANCY PLAN

1/16" = 1'-0"

FOURTH FLOOR OCCUPANCY PLAN

1/16" = 1'-0" [/] 1/16" = 1'-0"

OCCUPANCY CALCULATIONS

FIRST FLOOR

ASSEMBLY A-2 **WAITING 2** 197 S.F. / 15 = 14 PERSONS 588 S.F. / 15 = 40 PERSONS BAR AREA 1 311 S.F. / 15 = 21 PERSONS PRV. DIN 2 BAR AREA 2 640 S.F. / 15 = 42 PERSONS 2049 S.F. / 15 = 136 PERSONS PATIO 311 S.F. / 15 = 21 PERSONS PRV DIN 1 556 S.F. / 15 = 37 PERSONS WAITING 1 262 S.F. / 15 = 8 PERSONS BOOTHS FIXED SEATING 24 PERSONS MAIN DINING 1658 S.F. / 15 = 110 PERSONS 640 S.F. / 15 = 42 PERSONS DINING 2 1427 S.F. / 200 = 7 PERSONS KITCHEN

TOTAL FIRST FLOOR = 502 PERSONS

SECOND FLOOR

BUSINESS

WARM SHELL TENANT SPACE 8067 S.F / 100 = 81 PERSONS

THIRD FLOOR

WARM SHELL TANANT SPACE 8408 S.F / 100 = 84 PERSONS

FOURTH FLOOR

ASSEMBLY A-2 FIXED SEATING EVENT 1602 S.F. / 15 = 107 PERSONS 636 S.F. / 15 = 42 PERSONS OUTDOOR EVENT 2 637 S.F. / 15 = 42 PERSONS **OUTDOOR EVENT 3 OUTDOOR EVENT 4** 1298 S.F. / 7 = 185 PERSONS 2017 S.F. / 15 = 134 PERSONS INDOOR EVENT 275 S.F. / 200 = 2 PERSONS PREP 308 S.F. / 200 = 2 PERSONS

TOTAL FOURTH FLOOR = 514 PERSONS

TOTAL OCCUPANT LOAD = 1,181 PERSONS

TRAVELS DISTANCES

MAXIMUM TRAVEL DISTANCE BETWEEN EXITS


FIRST FLOOR = SECOND FLOOR = THIRD FLOOR = FOURTH FLOOR =

OCCUPANT LOAD

OCCUPANT LOAD

CLEAR EXIT PATH MINIMUM 42" ALL ISLES

- 1. ALL EXIT DOORS SHALL BE EQUIPPED WITH CODE APPROVED PUSH BAR TYPE QUICK RELEASE PANIC HARDWARE ADA COMPLIANT.
- 2. ALL INTERIOR DOORS SHALL BE EQUIPPED WITH CODE APPROVED ADA LEVER TYPE DOOR HANDLES AND PUSH PLATES.
- 3. DEAD END DISTANCE 20'-0" MAX.
- 4. 2 EXITS MUST BE VISIBLE FROM ANY POINT.
- 5. ALL RESTROOMS ENTRY DOORS SHALL HAVE AUTOMATIC DOOR CLOSERS.

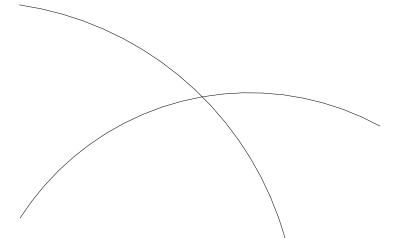

David Martini - Plank

ARCHITECT

PROJECT TEAM: **ARCHITECT OF RECORD** David Martini - Plank, AIA NC Registration: 5453 143 Village View Drive - Suite 203 Mooresville, NC 28117 704-777-4447 dmartiniplank@gmail.com Architecture Interiors Master Planning Development

GENERAL CONTRACTOR Kearey Builders Ryan Kearey 2915 Charlotte Highway Mooresville, NC 28117 980-444-6510



PROJECT

DAVIDSON GATEWAY CENTER 635 DAVIDSON GATEWAY DRIVE DAVIDSON NC 28036

Seal:


Issue Date:

07/31/19

OCCUPANCY PLANS

OC-100-00

SHEET:

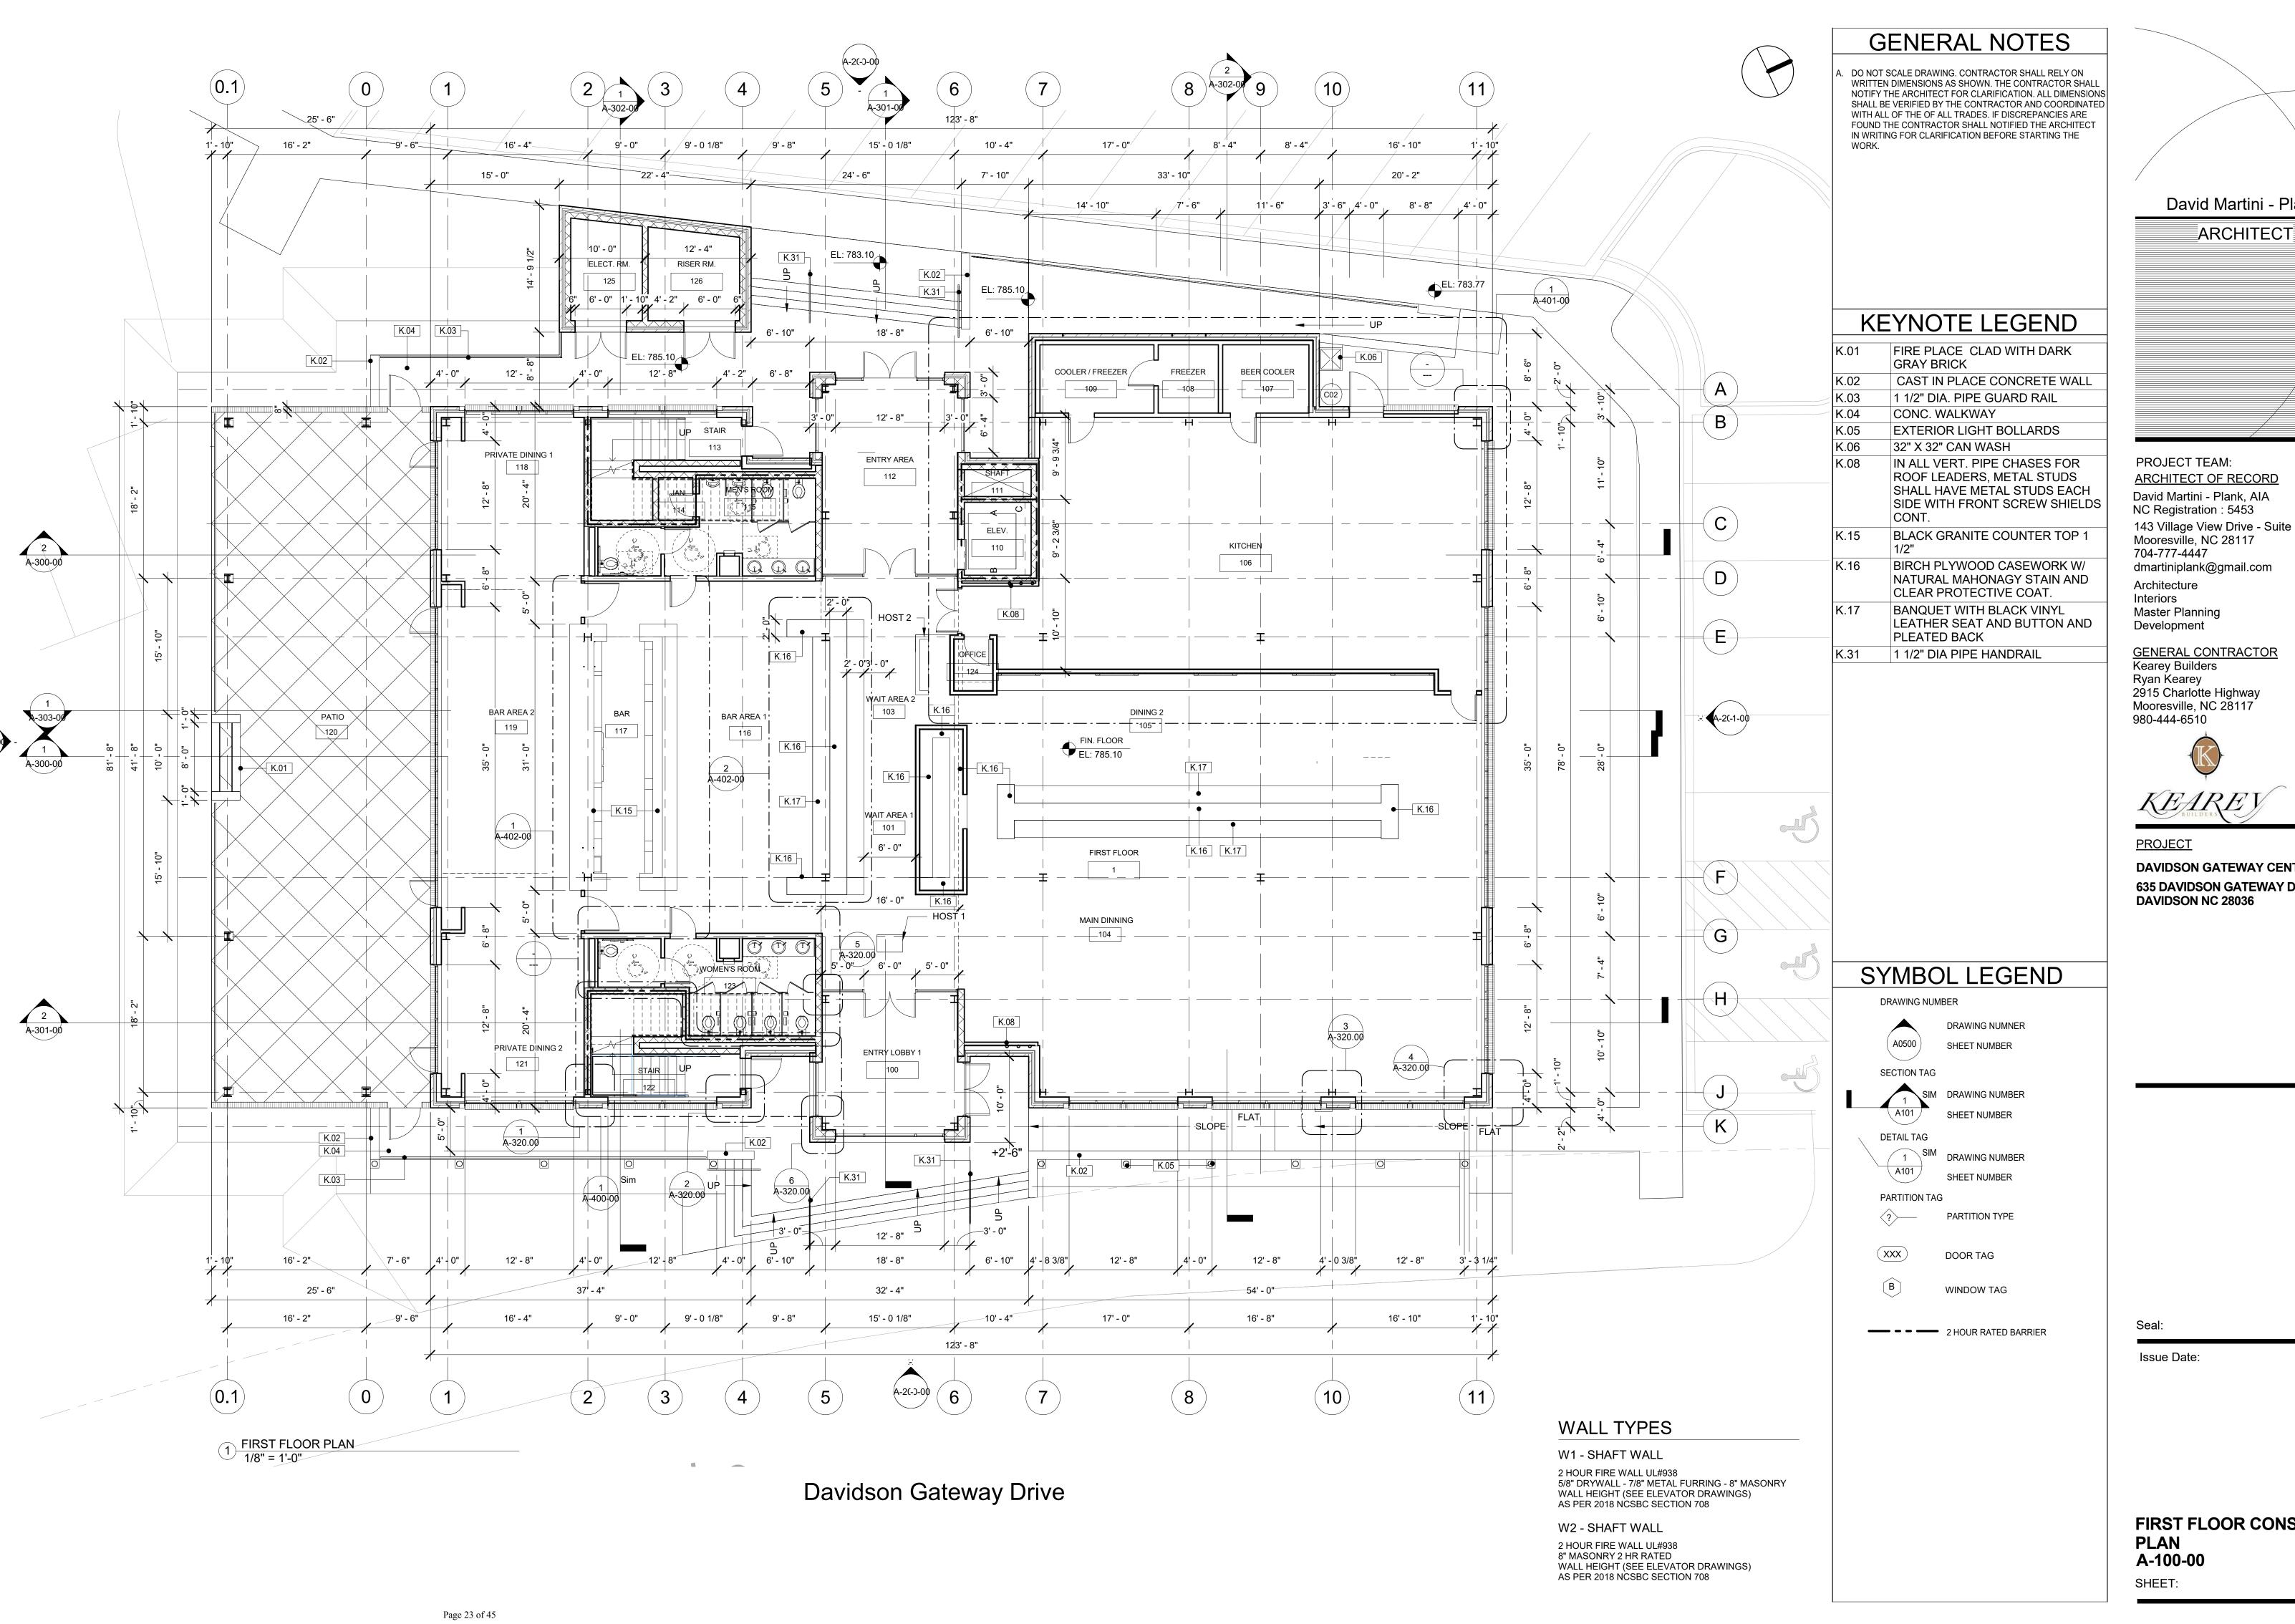

David Martini - Plank

PROJECT TEAM: **ARCHITECT OF RECORD** David Martini - Plank, AIA NC Registration: 5453 143 Village View Drive - Suite 203 Mooresville, NC 28117 704-777-4447 dmartiniplank@gmail.com Architecture

GENERAL CONTRACTOR Kearey Builders 2915 Charlotte Highway Mooresville, NC 28117



DAVIDSON GATEWAY CENTER 635 DAVIDSON GATEWAY DRIVE DAVIDSON NC 28036

Issue Date:

FIRST FLOOR CONSTRUCTION

07/31/19



A-301-0

15' - 0 1/8"

18' - 8"

8'-4" 2'-0" 8'-4"

STAIR

203

(6)

122' - 10"

10' - 4"

7' - 3"

SHAFT

17' - 0"

8' - 4"

8' - 4"

53' - 2"

3|-7",4'-0",4'-8",4'-0",4'-0",4'-0",4'-0",4'-0",4'-0",4'-0",4'-0",4'-0",4'-0",4'-0",4'-0",



(11)

K.13

16' - 10"



GENERAL NOTES

DO NOT SCALE DRAWING. CONTRACTOR SHALL RELY ON WRITTEN DIMENSIONS AS SHOWN. THE CONTRACTOR SHALL NOTIFY THE ARCHITECT FOR CLARIFICATION. ALL DIMENSIONS SHALL BE VERIFIED BY THE CONTRACTOR AND COORDINATED WITH ALL OF THE OF ALL TRADES. IF DISCREPANCIES ARE FOUND THE CONTRACTOR SHALL NOTIFIED THE ARCHITECT IN WRITING FOR CLARIFICATION BEFORE STARTING THE

KEYNOTE LEGEND IN ALL VERT. PIPE CHASES FOR

ROOF LEADERS, METAL STUDS SHALL HAVE METAL STUDS EACH SIDE WITH FRONT SCREW SHIELDS CONT. ANCHOR FLANGES AND SOLID


STEEL ROD PRE-FAB METAL CANOPY W/

FACTORY KYNAR ANTI-FADE PAINT COLOR WITH PROTECTIVE FINISH CANOPY STEEL CHANNEL W/ KYNAR ANTI-FADE PAINT COLOR WITH PROTECTIVE FINISH. SEE STRUCT. DWGS. SEE ARCHITECTURAL DWGS FOR VERT WEB FINS AND DETAIL

DIMENSIONS. SUBMIT SHOP DWGS

FOR ARCHITECTURAL AND STRUCTURAL APPROVAL. STEEL BEAM SEE STRUCT. DWGS. STEPPED BRICK CORBEL

OUTLINE OF FREEZER / COOLER **ROOF BELOW**

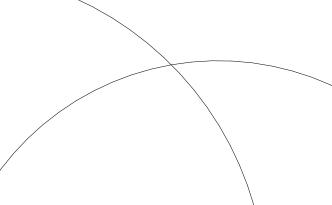

David Martini - Plank

ARCHITECT

PROJECT TEAM: ARCHITECT OF RECORD David Martini - Plank, AIA NC Registration: 5453 143 Village View Drive - Suite 203 Mooresville, NC 28117 704-777-4447 dmartiniplank@gmail.com Architecture

GENERAL CONTRACTOR Kearey Builders Ryan Kearey 2915 Charlotte Highway Mooresville, NC 28117 980-444-6510



<u>PROJECT</u>

Interiors

Master Planning

Development

DAVIDSON GATEWAY CENTER 635 DAVIDSON GATEWAY DRIVE **DAVIDSON NC 28036**

SYMBOL LEGEND

(A0500)

DRAWING NUMNER SHEET NUMBER

SECTION TAG 1 SIM DRAWING NUMBER SHEET NUMBER

DRAWING NUMBER

DETAIL TAG DRAWING NUMBER SHEET NUMBER

PARTITION TAG PARTITION TYPE

(xxx)DOOR TAG WINDOW TAG

2 HOUR RATED BARRIER


Issue Date:

SECOND FLOOR PLAN

07/31/19

A-101-00

SHEET:

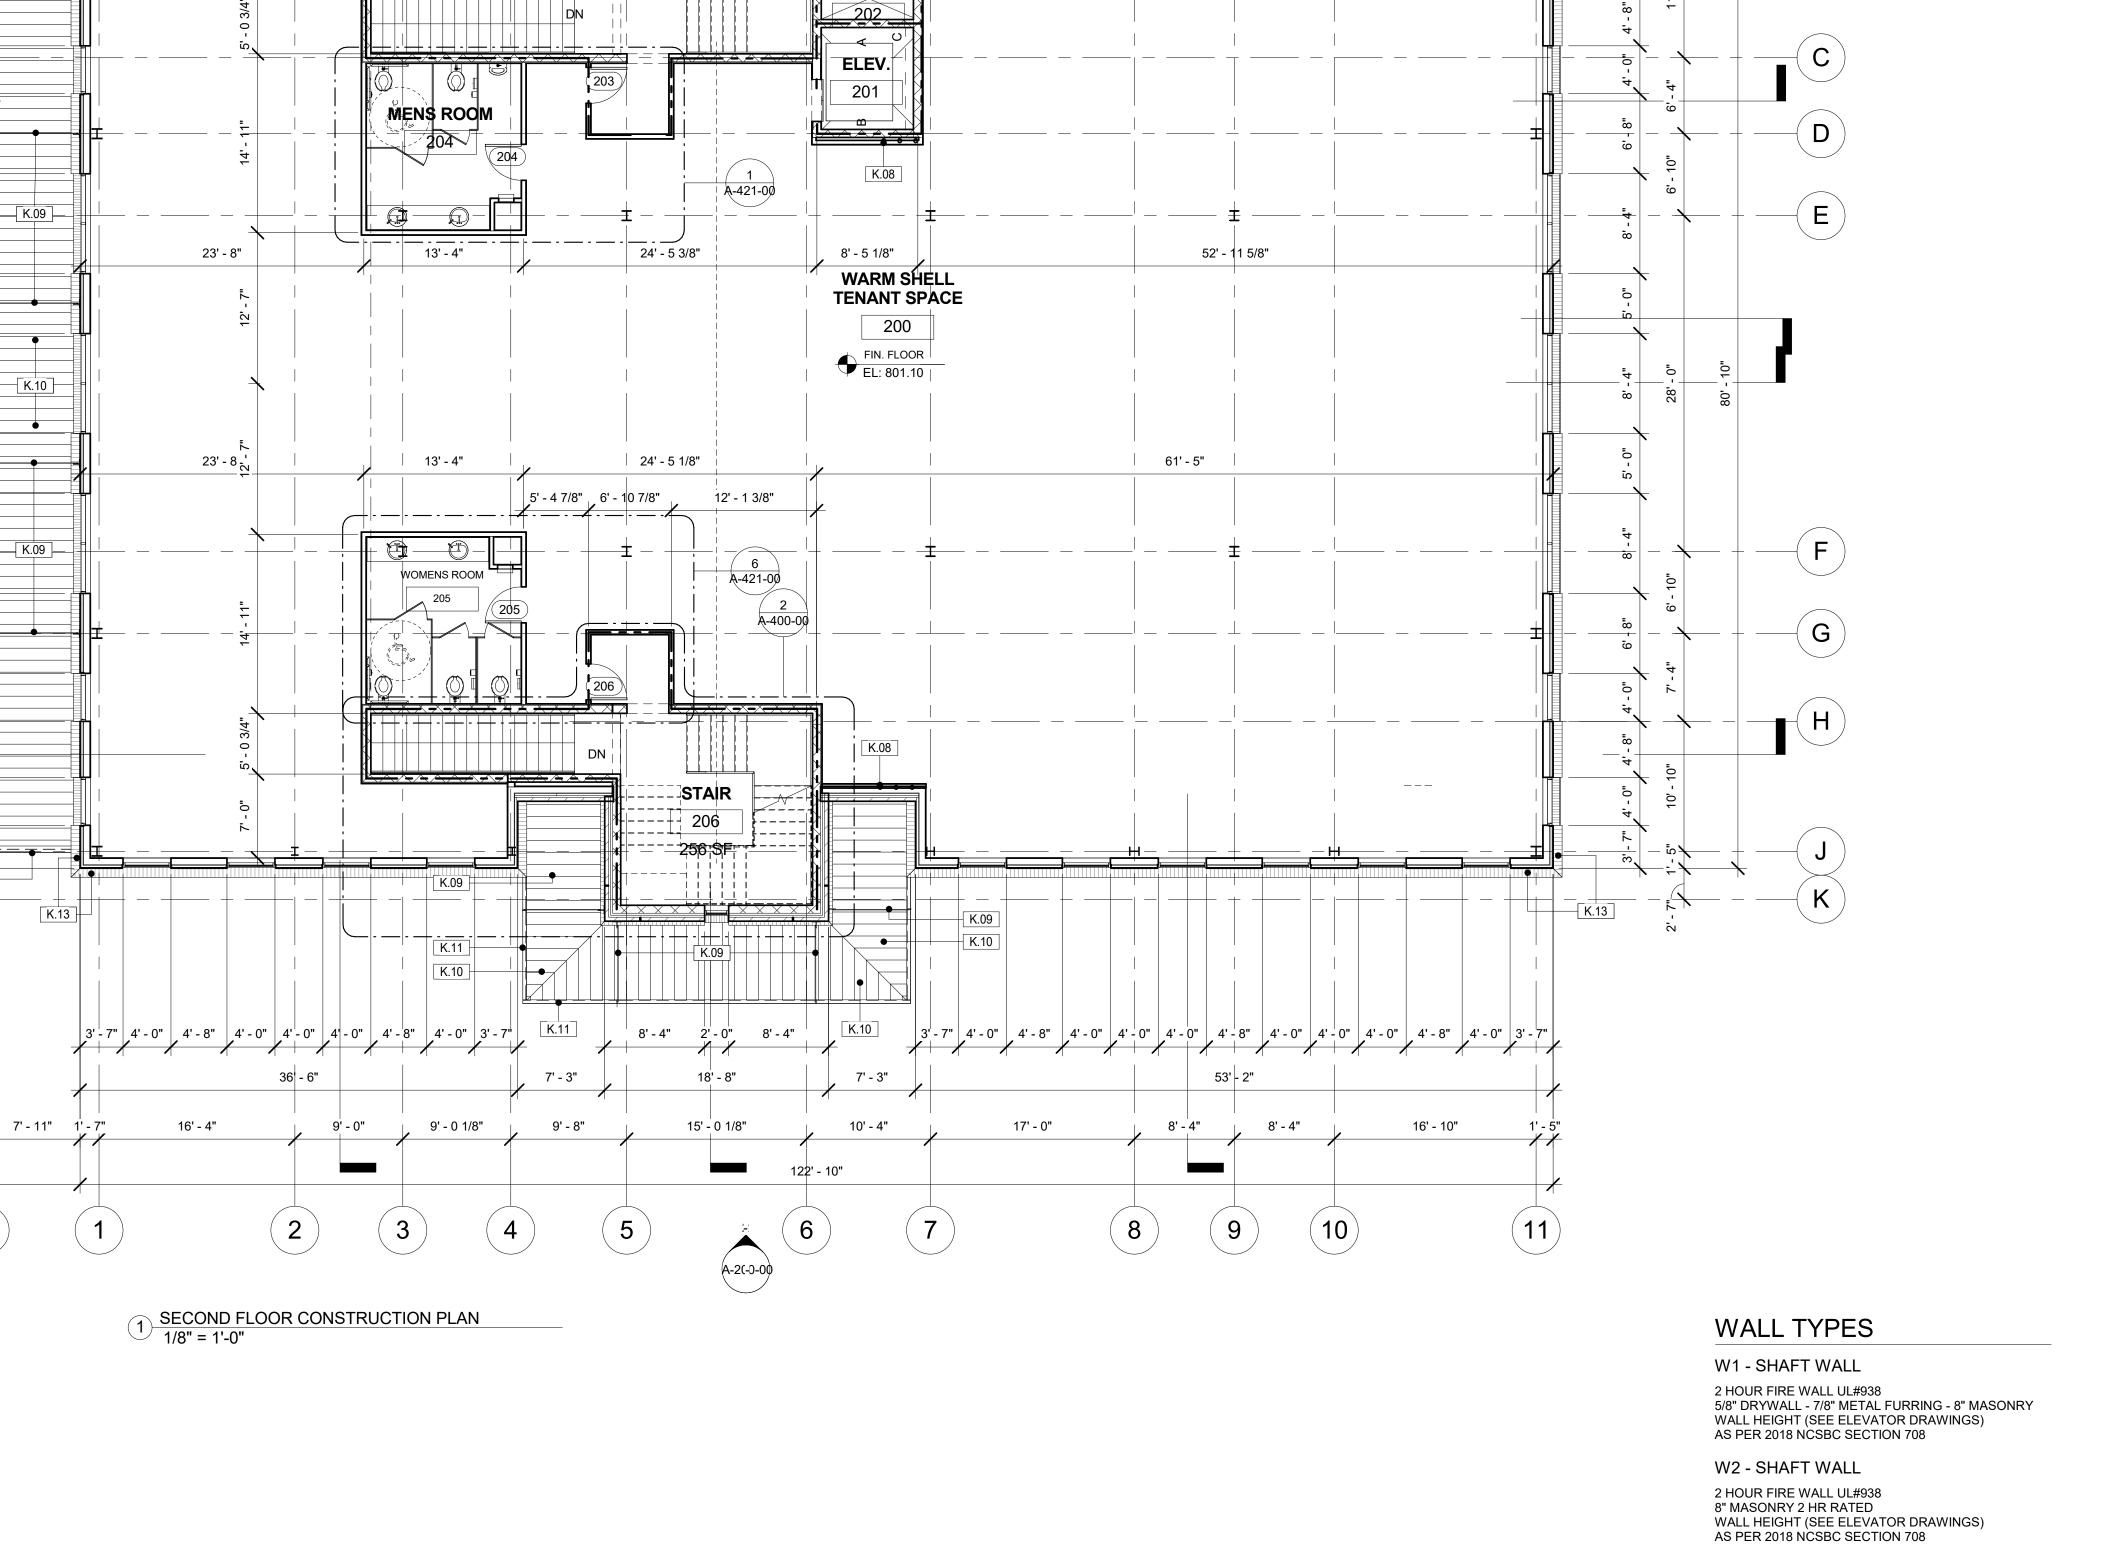

(0.1)

2 A-300-00

A-303-00

A-300-00

(G)

 $(\mathsf{K})_{4}$

(0.1)

K.12

16' - 2"

24' - 1"

0

A-301-00

24' - 1"

16' - 4"

9' - 0"

36 - 6"

3' | 7" | 4' - 0" | 4' - 8" | 4' - 0" | 4' | - 0" | 4' - 0" | 4' - 18" | 4' - 0" | 3' - 7" |

9' - 0 1/8"

9' - 8"

7' - 3"








GENERAL NOTES

DO NOT SCALE DRAWING. CONTRACTOR SHALL RELY ON WRITTEN DIMENSIONS AS SHOWN. THE CONTRACTOR SHALL NOTIFY THE ARCHITECT FOR CLARIFICATION. ALL DIMENSIONS SHALL BE VERIFIED BY THE CONTRACTOR AND COORDINATED WITH ALL OF THE OF ALL TRADES. IF DISCREPANCIES ARE FOUND THE CONTRACTOR SHALL NOTIFIED THE ARCHITECT IN WRITING FOR CLARIFICATION BEFORE STARTING THE

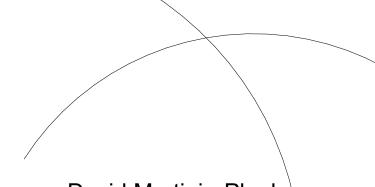

David Martini - Plank

ARCHITECT

KEYNOTE LEGEND

K.08 IN ALL VERT. PIPE CHASES FOR ROOF LEADERS, METAL STUDS SHALL HAVE METAL STUDS EACH SIDE WITH FRONT SCREW SHIELDS CONT.



Development GENERAL CONTRACTOR Kearey Builders Ryan Kearey 2915 Charlotte Highway Mooresville, NC 28117 980-444-6510




<u>PROJECT</u>

DAVIDSON GATEWAY CENTER 635 DAVIDSON GATEWAY DRIVE **DAVIDSON NC 28036**

SYMBOL LEGEND

DRAWING NUMBER (A0500)

DRAWING NUMNER SHEET NUMBER

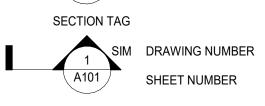

DETAIL TAG DRAWING NUMBER SHEET NUMBER

PARTITION TAG PARTITION TYPE

(xxx)DOOR TAG WINDOW TAG

2 HOUR RATED BARRIER


Issue Date:

THIRD FLOOR PLAN

07/31/19

A-102-00

SHEET:

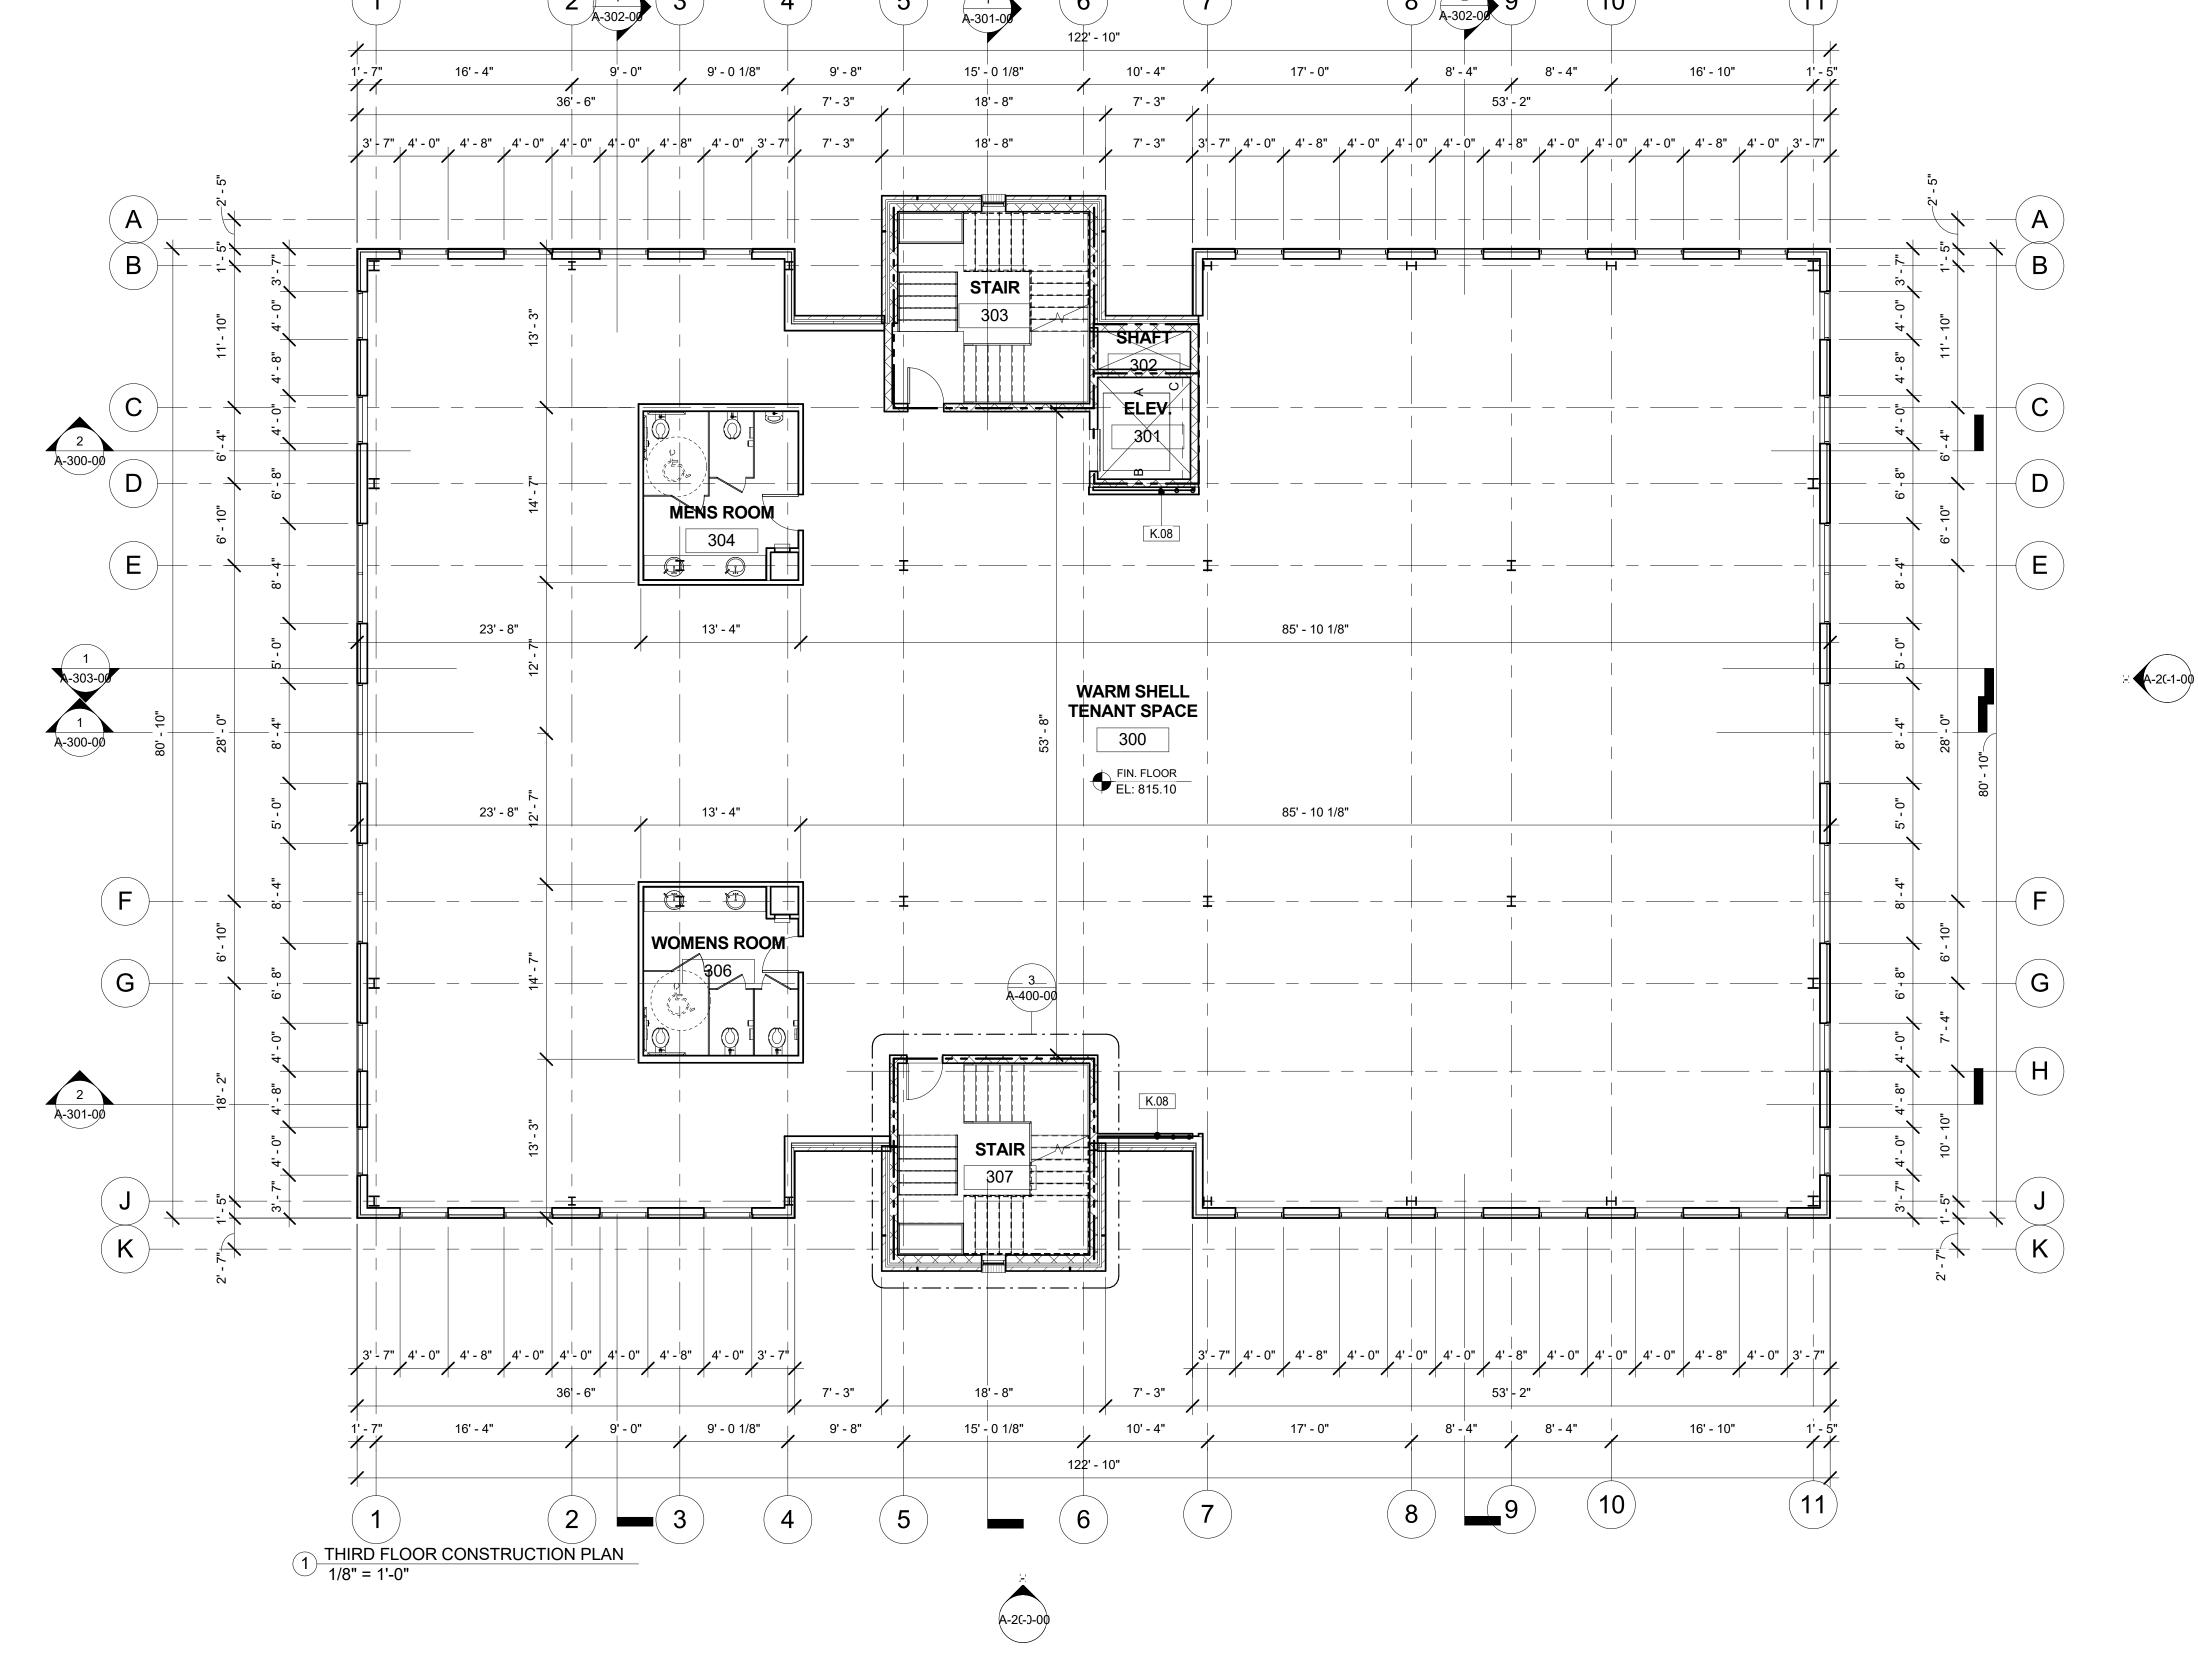

WALL TYPES


W1 - SHAFT WALL

2 HOUR FIRE WALL UL#938 5/8" DRYWALL - 7/8" METAL FURRING - 8" MASONRY WALL HEIGHT (SEE ELEVATOR DRAWINGS) AS PER 2018 NCSBC SECTION 708

W2 - SHAFT WALL 2 HOUR FIRE WALL UL#938 8" MASONRY 2 HR RATED WALL HEIGHT (SEE ELEVATOR DRAWINGS) AS PER 2018 NCSBC SECTION 708





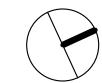

GENERAL NOTES

DO NOT SCALE DRAWING. CONTRACTOR SHALL RELY ON WRITTEN DIMENSIONS AS SHOWN. THE CONTRACTOR SHALL NOTIFY THE ARCHITECT FOR CLARIFICATION. ALL DIMENSIONS SHALL BE VERIFIED BY THE CONTRACTOR AND COORDINATED WITH ALL OF THE OF ALL TRADES. IF DISCREPANCIES ARE FOUND THE CONTRACTOR SHALL NOTIFIED THE ARCHITECT IN WRITING FOR CLARIFICATION BEFORE STARTING THE

KEYNOTE LEGEND IN ALL VERT. PIPE CHASES FOR

ROOF LEADERS, METAL STUDS

SHALL HAVE METAL STUDS EACH

RAISED FLOOR ON ADJUSTABLE

SIDE WITH FRONT SCREW SHIELDS CONT. ROOF DRAIN BELOW RAISED FLOOR **ROOF DRAIN** TEMPERED GLASS RAILING ROOF WALKWAY PADS MECHANICAL EQUIPMENT. SEE MECH. DWGS.

PEDESTAL SYSTEM

David Martini - Plank

ARCHITECT

PROJECT TEAM: ARCHITECT OF RECORD David Martini - Plank, AIA NC Registration : 5453 143 Village View Drive - Suite 203 Mooresville, NC 28117 704-777-4447 dmartiniplank@gmail.com Architecture Interiors Master Planning Development

GENERAL CONTRACTOR Kearey Builders Ryan Kearey 2915 Charlotte Highway Mooresville, NC 28117 980-444-6510



<u>PROJECT</u>

DAVIDSON GATEWAY CENTER 635 DAVIDSON GATEWAY DRIVE DAVIDSON NC 28036

SYMBOL LEGEND

DRAWING NUMBER (A0500)

DRAWING NUMNER SHEET NUMBER

SECTION TAG 1 SIM DRAWING NUMBER SHEET NUMBER

DETAIL TAG DRAWING NUMBER SHEET NUMBER

PARTITION TAG PARTITION TYPE

WINDOW TAG

(xxx)

2 HOUR RATED BARRIER


DOOR TAG

Issue Date:

FOURTH FLOOR CONSTRUCTION PLAN A-103-00

07/31/19

SHEET:

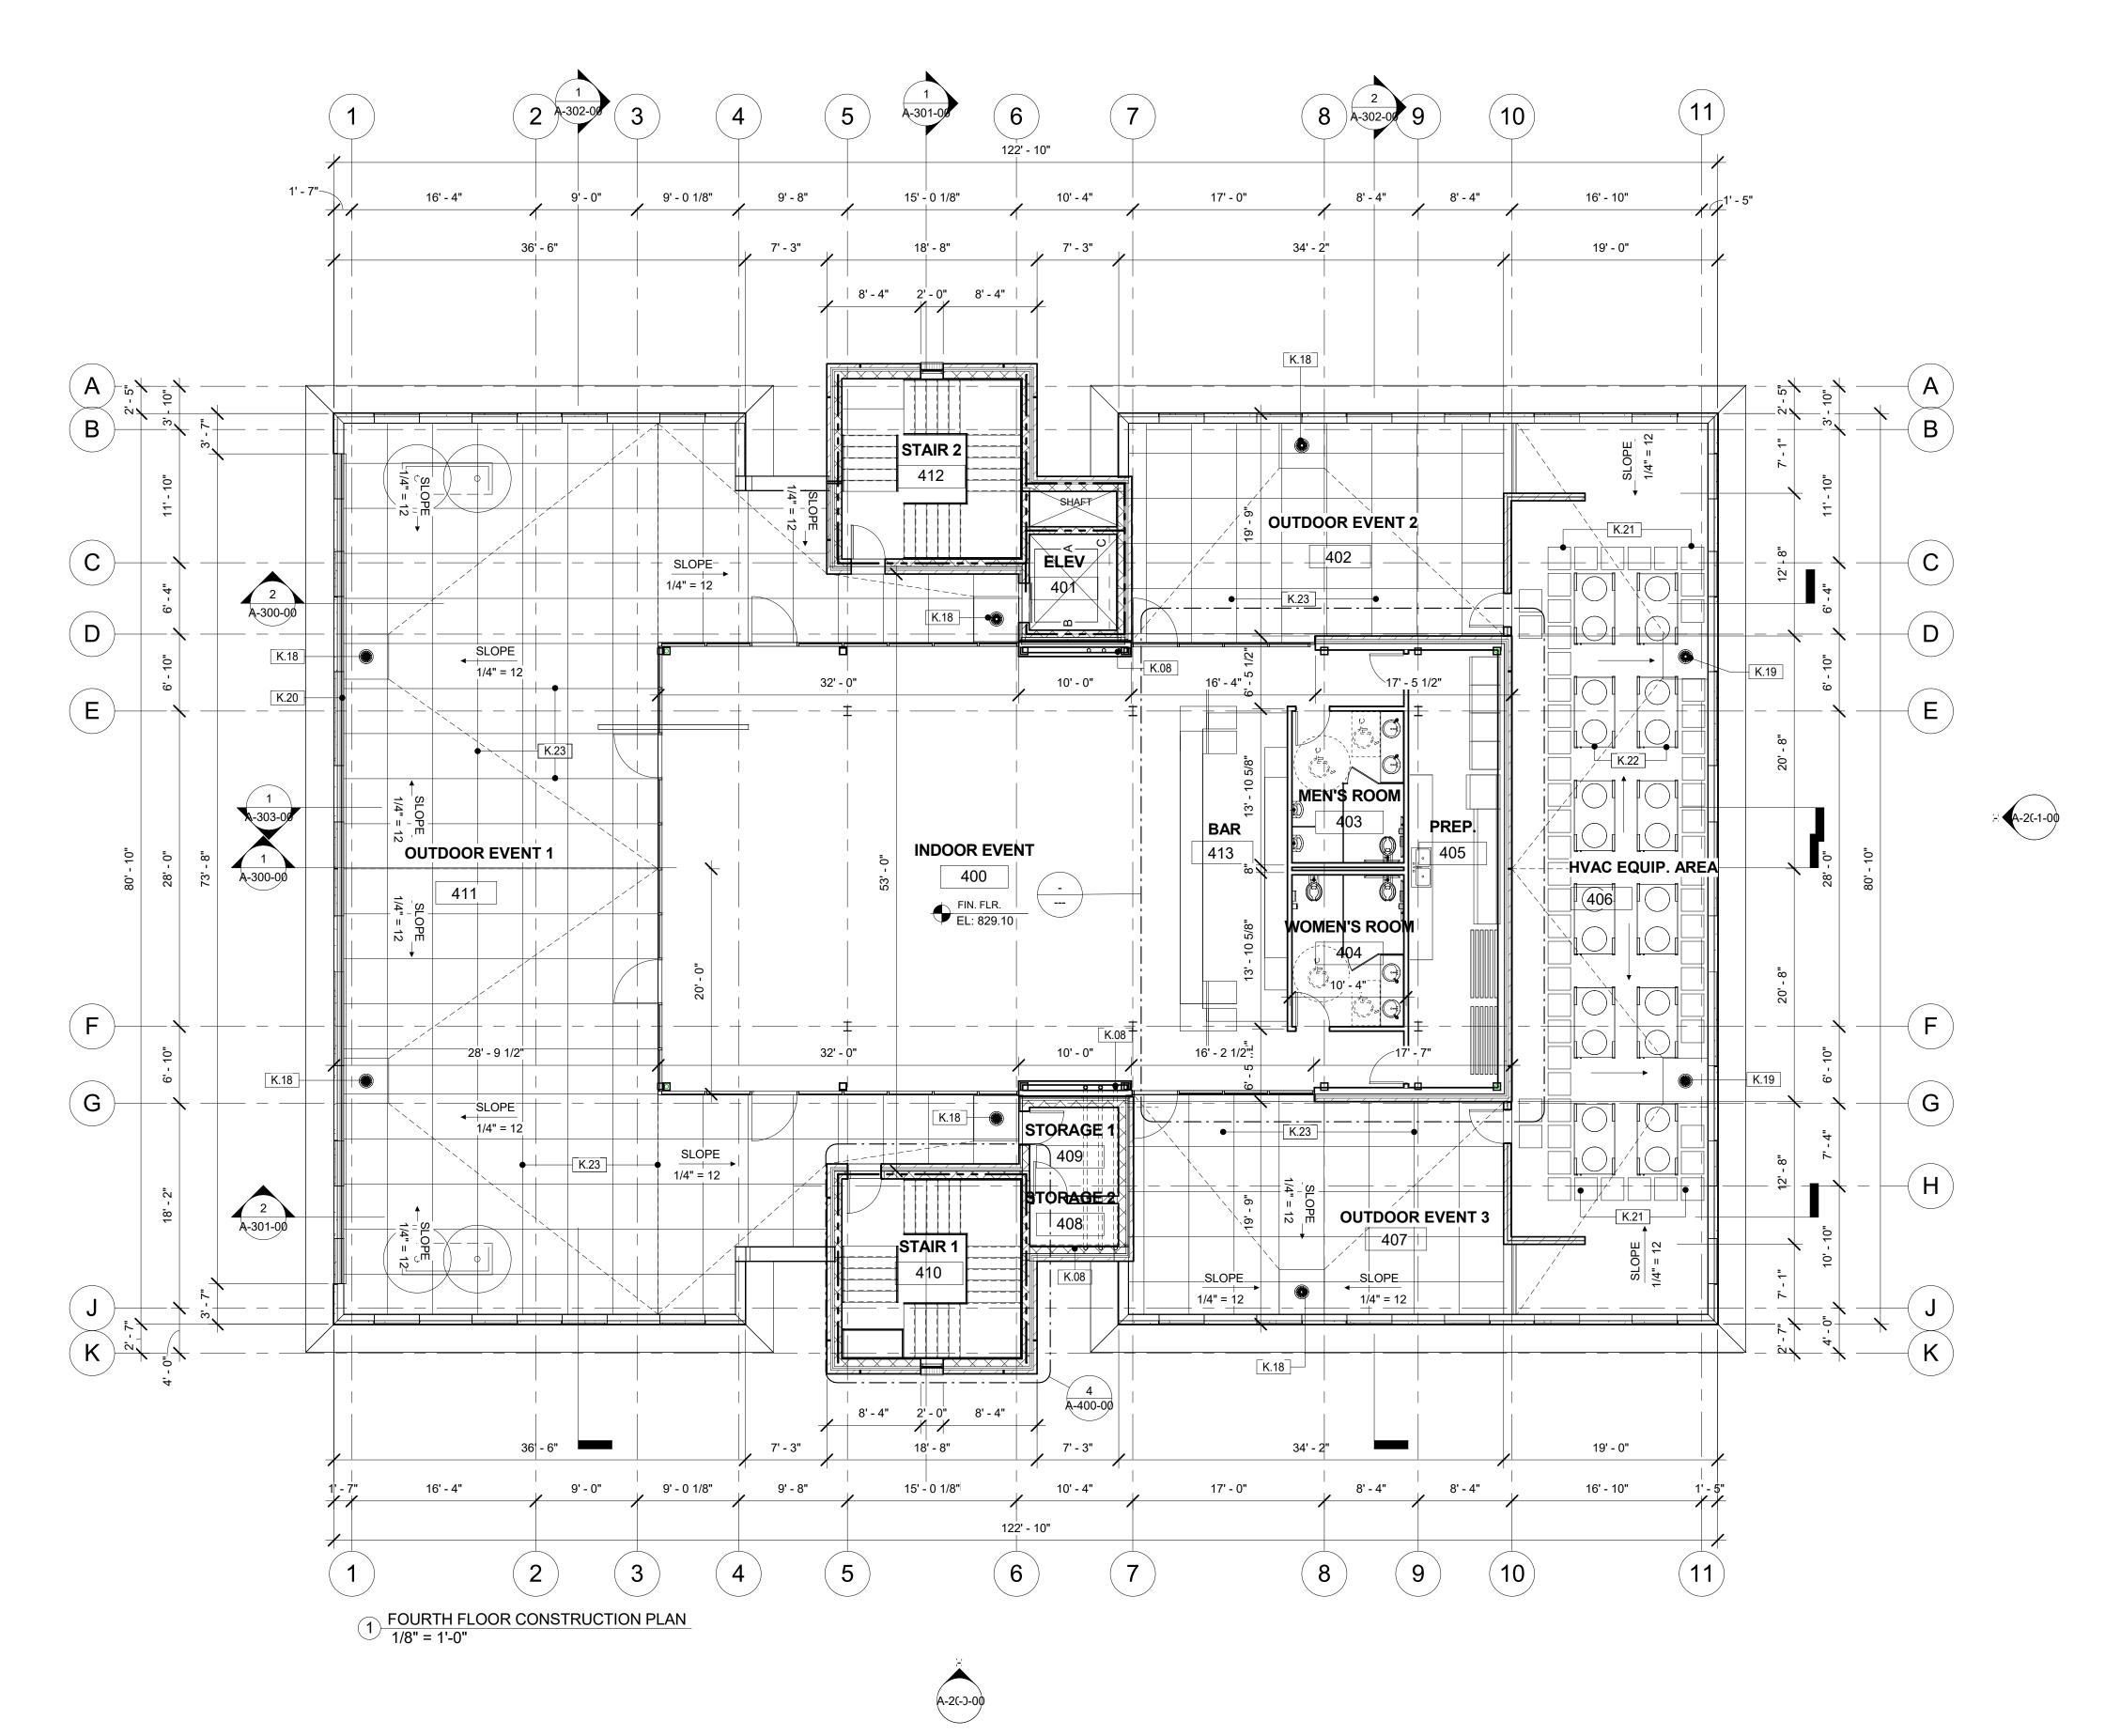

WALL TYPES

AS PER 2018 NCSBC SECTION 708


AS PER 2018 NCSBC SECTION 708


W1 - SHAFT WALL 2 HOUR FIRE WALL UL#938 5/8" DRYWALL - 7/8" METAL FURRING - 8" MASONRY

WALL HEIGHT (SEE ELEVATOR DRAWINGS)

W2 - SHAFT WALL 2 HOUR FIRE WALL UL#938 8" MASONRY 2 HR RATED WALL HEIGHT (SEE ELEVATOR DRAWINGS)



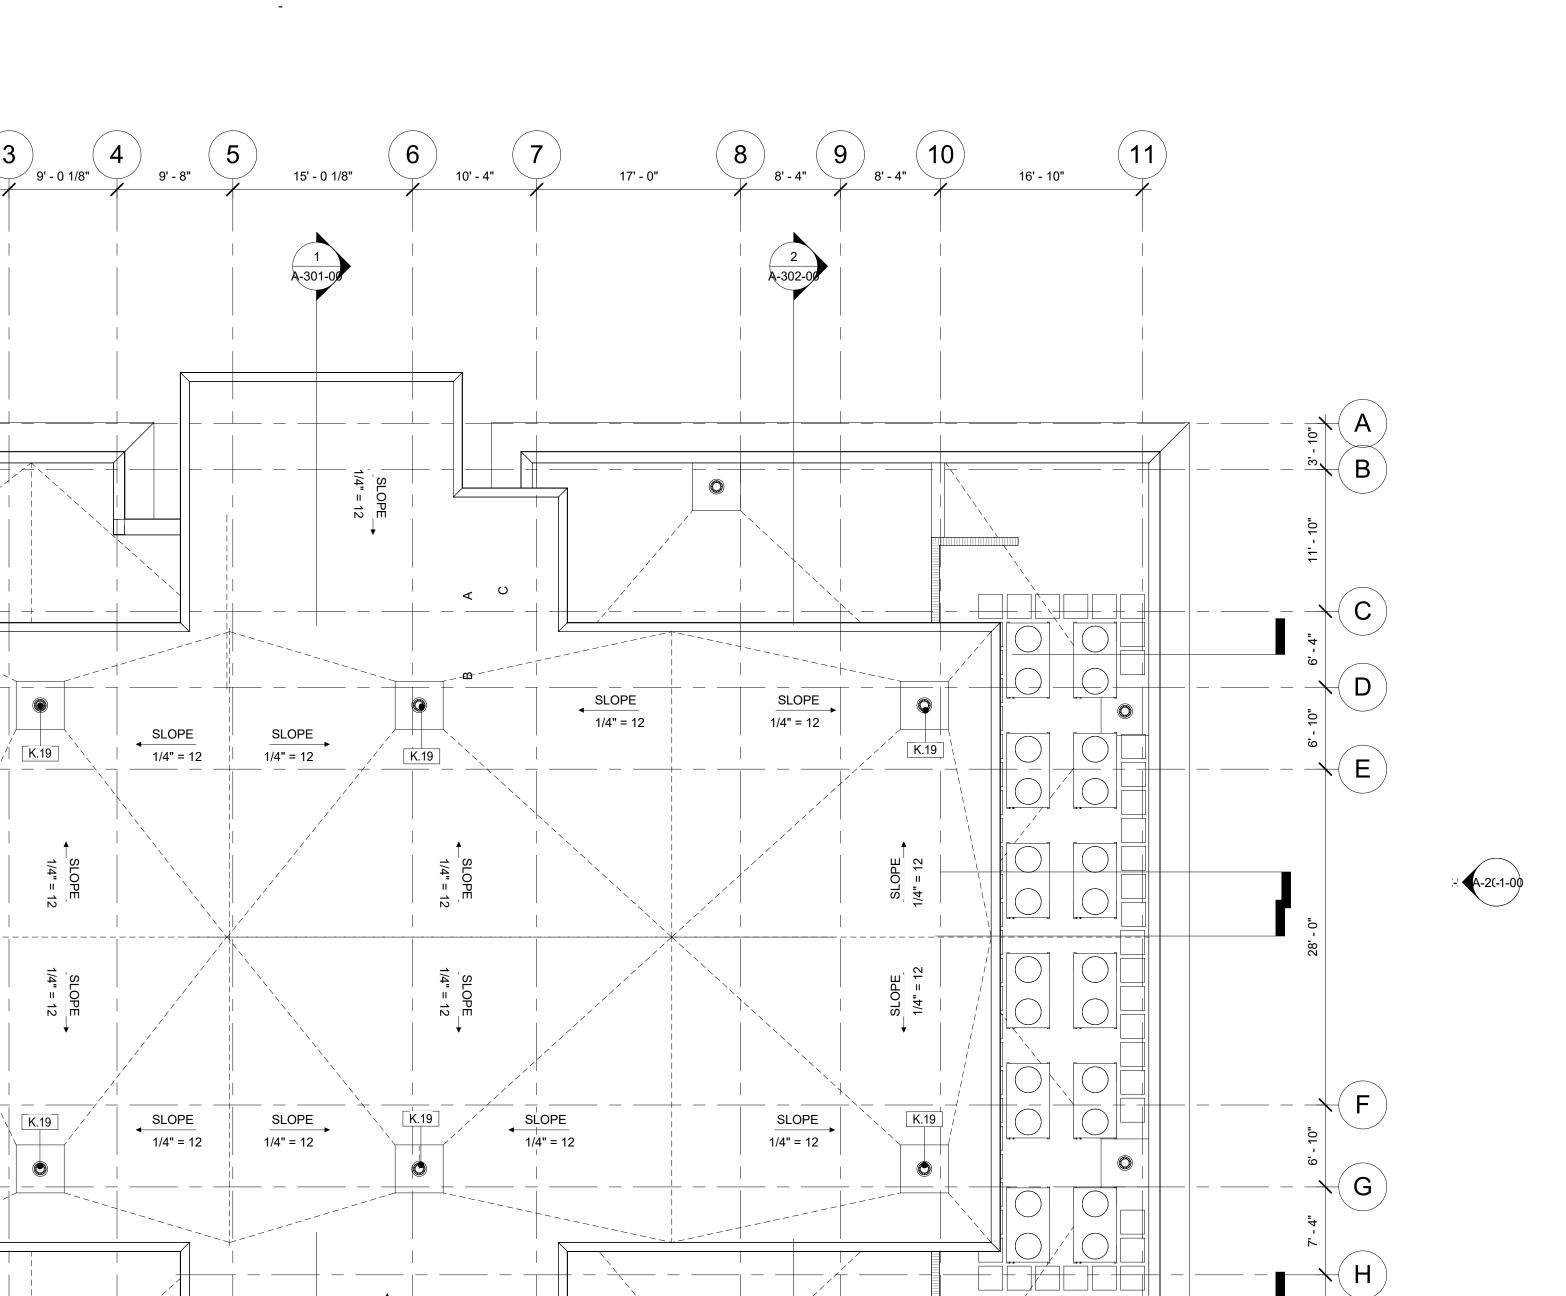

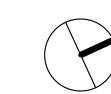

GENERAL NOTES

A. DO NOT SCALE DRAWING. CONTRACTOR SHALL RELY ON WRITTEN DIMENSIONS AS SHOWN. THE CONTRACTOR SHALL NOTIFY THE ARCHITECT FOR CLARIFICATION. ALL DIMENSIONS SHALL BE VERIFIED BY THE CONTRACTOR AND COORDINATED WITH ALL OF THE OF ALL TRADES. IF DISCREPANCIES ARE FOUND THE CONTRACTOR SHALL NOTIFIED THE ARCHITECT IN WRITING FOR CLARIFICATION BEFORE STARTING THE

KEYNOTE LEGEND

K.19 ROOF DRAIN

David Martini - Plank

ARCHITECT

PROJECT TEAM: ARCHITECT OF RECORD David Martini - Plank, AIA NC Registration : 5453 143 Village View Drive - Suite 203 Mooresville, NC 28117 704-777-4447 dmartiniplank@gmail.com Architecture Interiors Master Planning

GENERAL CONTRACTOR Kearey Builders Ryan Kearey 2915 Charlotte Highway Mooresville, NC 28117 980-444-6510

Development




<u>PROJECT</u>

DAVIDSON GATEWAY CENTER 635 DAVIDSON GATEWAY DRIVE DAVIDSON NC 28036

SYMBOL LEGEND

DRAWING NUMBER

DRAWING NUMNER SHEET NUMBER

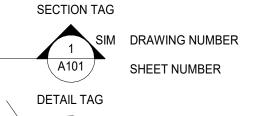

1 SIM DRAWING NUMBER SHEET NUMBER PARTITION TAG

PARTITION TYPE

(xxx)

WINDOW TAG

DOOR TAG

2 HOUR RATED BARRIER

Issue Date:

ROOF CONSTRUCTION PLAN

07/31/19

A-104-00

SHEET:

Page 27 of 45

16' - 4"

1 ROOF CONSTRUCTION PLAN 1/8" = 1'-0"

A B

(C)

D

E

G

2 A-300-00

A-303-00

A-300-00

A-301-00

2

SLOPE

SLOPE 1/4" = 12

9' - 8"

(5)

9' - 0 1/8"

15' - 0 1/8"

A-2(-)-00

10' - 4"

17' - 0"

8' - 4"


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ight)$


8

8' - 4"

16' - 10"

1/4" = 12

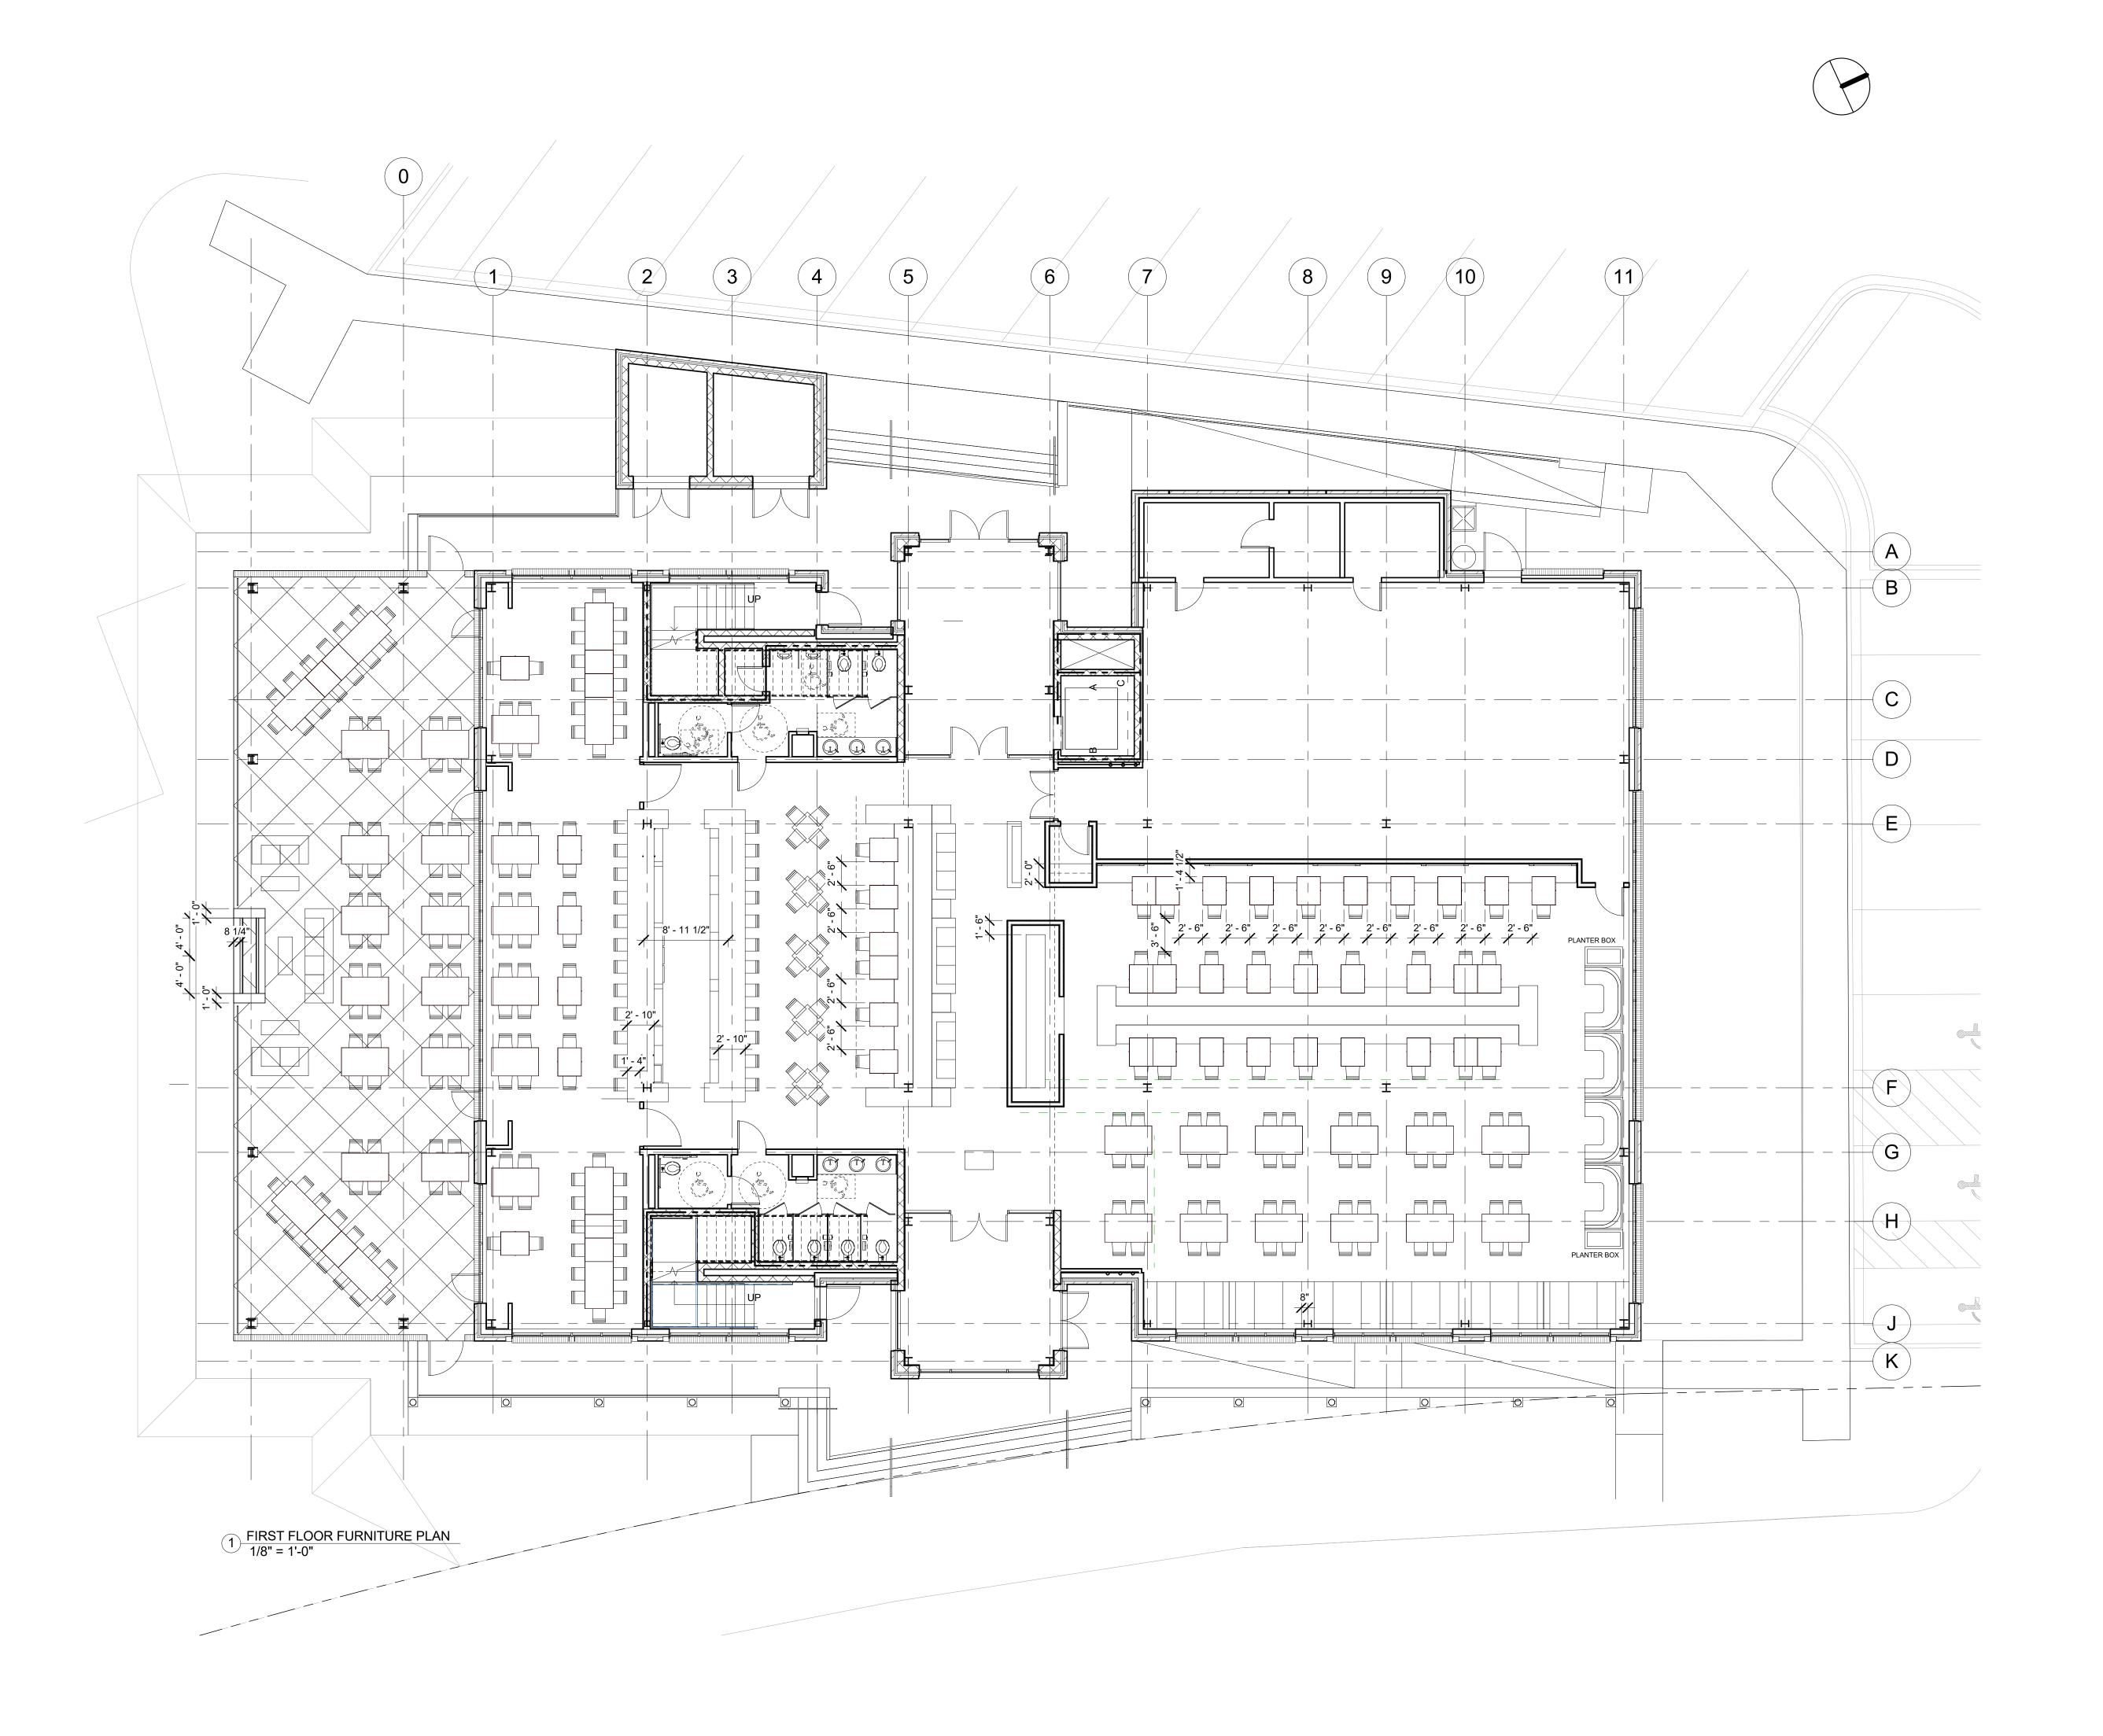

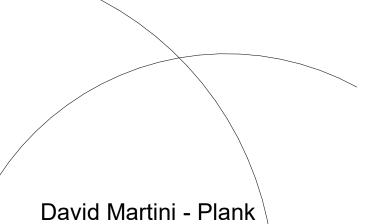

ARCHITECT

PROJECT TEAM: ARCHITECT OF RECORD David Martini - Plank, AIA NC Registration : 5453 143 Village View Drive - Suite 203 Mooresville, NC 28117 704-777-4447 dmartiniplank@gmail.com Architecture Interiors Master Planning Development

GENERAL CONTRACTOR
Kearey Builders
Ryan Kearey
2915 Charlotte Highway
Mooresville, NC 28117
980-444-6510



<u>PROJECT</u>


DAVIDSON GATEWAY CENTER 635 DAVIDSON GATEWAY DRIVE DAVIDSON NC 28036

Issue Date:


07/31/19

FIRST FLOOR FURNITURE PLAN

A-160-00 SHEET:

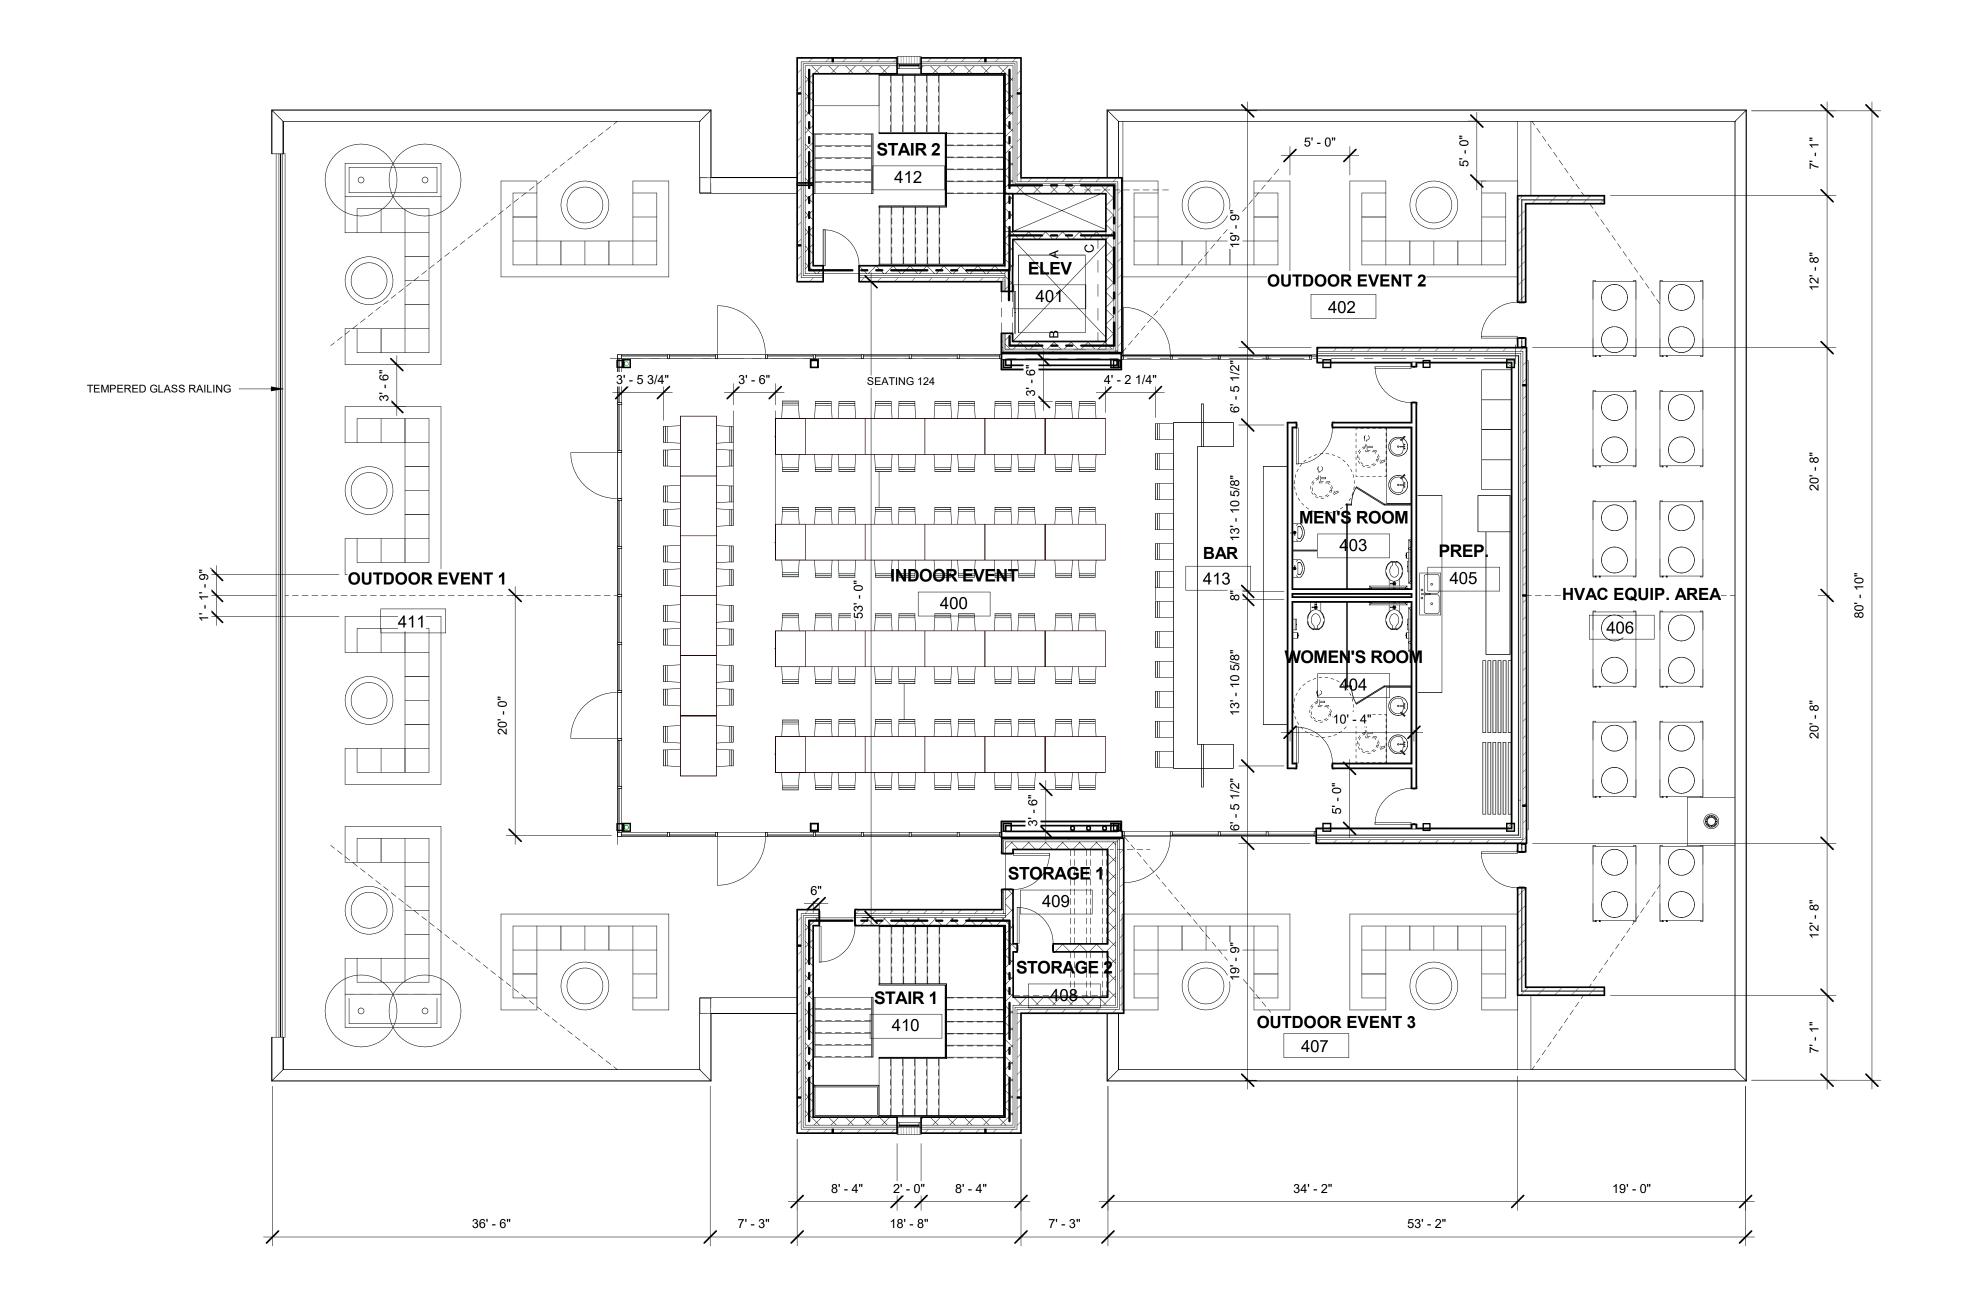

1) FOURTH FLOOR FURNITURE PLAN 1/8" = 1'-0"

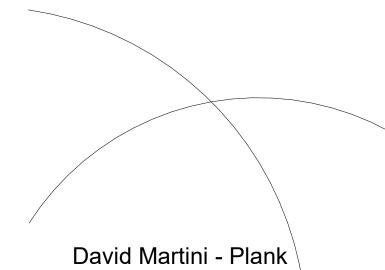

ARCHITECT

PROJECT TEAM:

ARCHITECT OF RECORD

David Martini - Plank, AIA

NC Registration: 5453

143 Village View Drive - Suite 203

Mooresville, NC 28117

704-777-4447

dmartiniplank@gmail.com

Architecture
Interiors

Master Planning
Development

GENERAL CONTRACTOR
Kearey Builders
Ryan Kearey
2915 Charlotte Highway
Mooresville, NC 28117
980-444-6510



PROJECT

DAVIDSON GATEWAY CENTER 635 DAVIDSON GATEWAY DRIVE DAVIDSON NC 28036

S

Issue Date:


07/31/19

FOURTH FLOOR FURNITURE PLAN A-161-00

SHEET:



Page 30 of 45

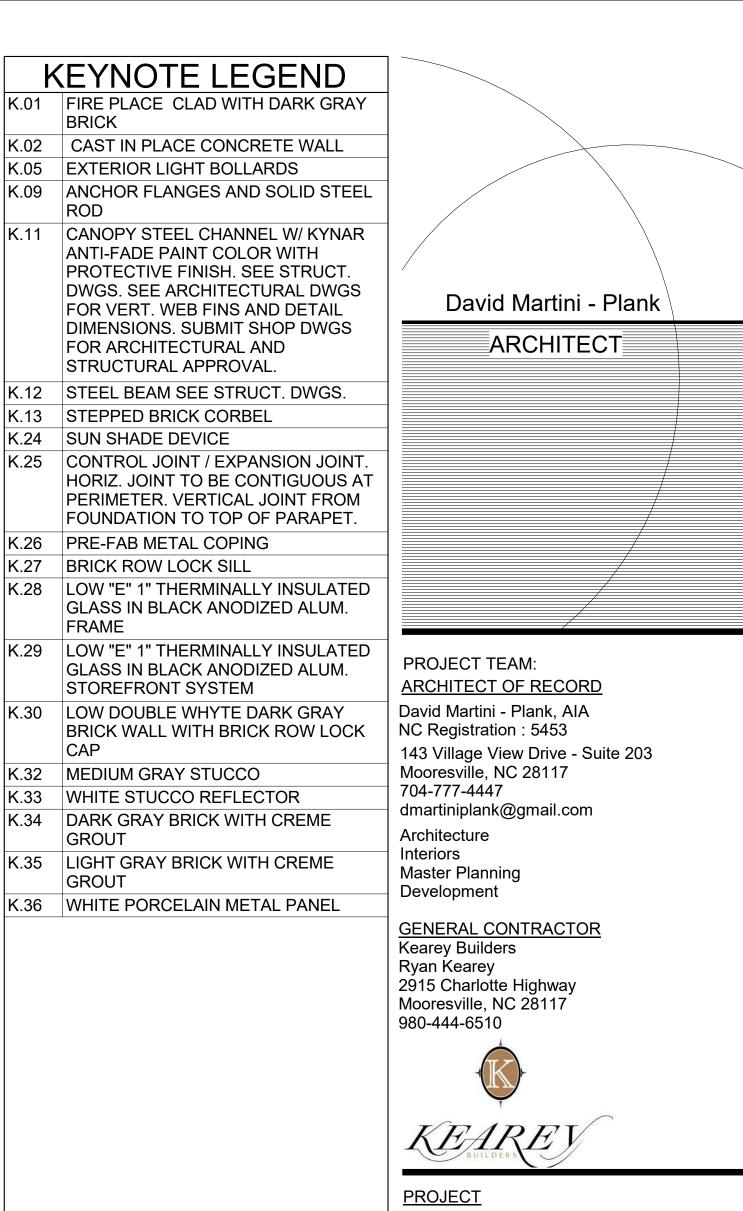

DAVIDSON GATEWAY CENTER 635 DAVIDSON GATEWAY DRIVE **DAVIDSON NC 28036**

07/31/19 Issue Date:

ELEVATIONS


A-200-00 SHEET:





Page 31 of 45

K	EYNOTE LEGEND
K.09	ANCHOR FLANGES AND SOLID STEEL ROD
K.11	CANOPY STEEL CHANNEL W/ KYNAR ANTI-FADE PAINT COLOR WITH PROTECTIVE FINISH. SEE STRUCT. DWGS. SEE ARCHITECTURAL DWGS FOR VERT. WEB FINS AND DETAIL DIMENSIONS. SUBMIT SHOP DWGS FOR ARCHITECTURAL AND STRUCTURAL APPROVAL.
K.13	STEPPED BRICK CORBEL
K.24	SUN SHADE DEVICE
K.25	CONTROL JOINT / EXPANSION JOINT. HORIZ. JOINT TO BE CONTIGUOUS AT PERIMETER. VERTICAL JOINT FROM FOUNDATION TO TOP OF PARAPET.
K.26	PRE-FAB METAL COPING
K.28	LOW "E" 1" THERMINALLY INSULATED GLASS IN BLACK ANODIZED ALUM. FRAME
K.29	LOW "E" 1" THERMINALLY INSULATED GLASS IN BLACK ANODIZED ALUM. STOREFRONT SYSTEM

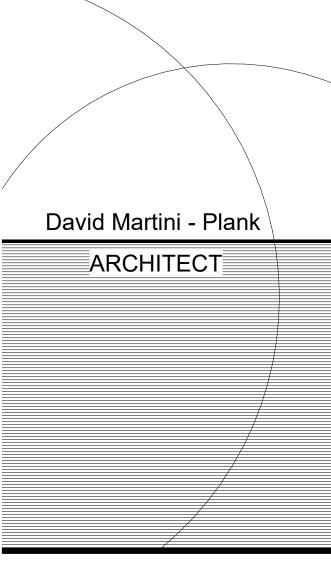

PROJECT TEAM:

ARCHITECT OF RECORD

David Martini - Plank, AIA

NC Registration : 5453

143 Village View Drive - Suite 203

Mooresville, NC 28117

704-777-4447

dmartiniplank@gmail.com

Architecture
Interiors
Master Planning
Development

GENERAL CONTRACTOR

GENERAL CONTRACTOR
Kearey Builders
Ryan Kearey
2915 Charlotte Highway
Mooresville, NC 28117
980-444-6510



PROJECT

DAVIDSON GATEWAY CENTER 635 DAVIDSON GATEWAY DRIVE DAVIDSON NC 28036


07/31/19

Issue Date:

ELEVATIONS

A-201-00 SHEET:



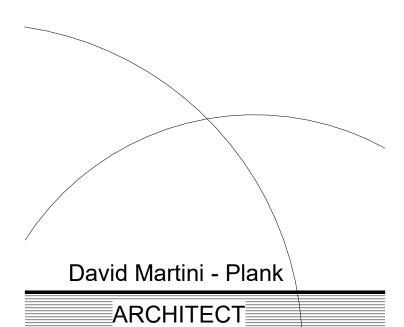

PROJECT TEAM:

ARCHITECT OF RECORD

David Martini - Plank, AIA

NC Registration: 5453

143 Village View Drive - Suite 203

Mooresville, NC 28117

704-777-4447

dmartiniplank@gmail.com

Architecture
Interiors

GENERAL CONTRACTOR
Kearey Builders
Ryan Kearey
2915 Charlotte Highway
Mooresville, NC 28117
980-444-6510

Master Planning Development



PROJECT

DAVIDSON GATEWAY CENTER 635 DAVIDSON GATEWAY DRIVE DAVIDSON NC 28036


366


Issue Date:

07/31/19

BUILDING SECTION

A-300-00 SHEET:

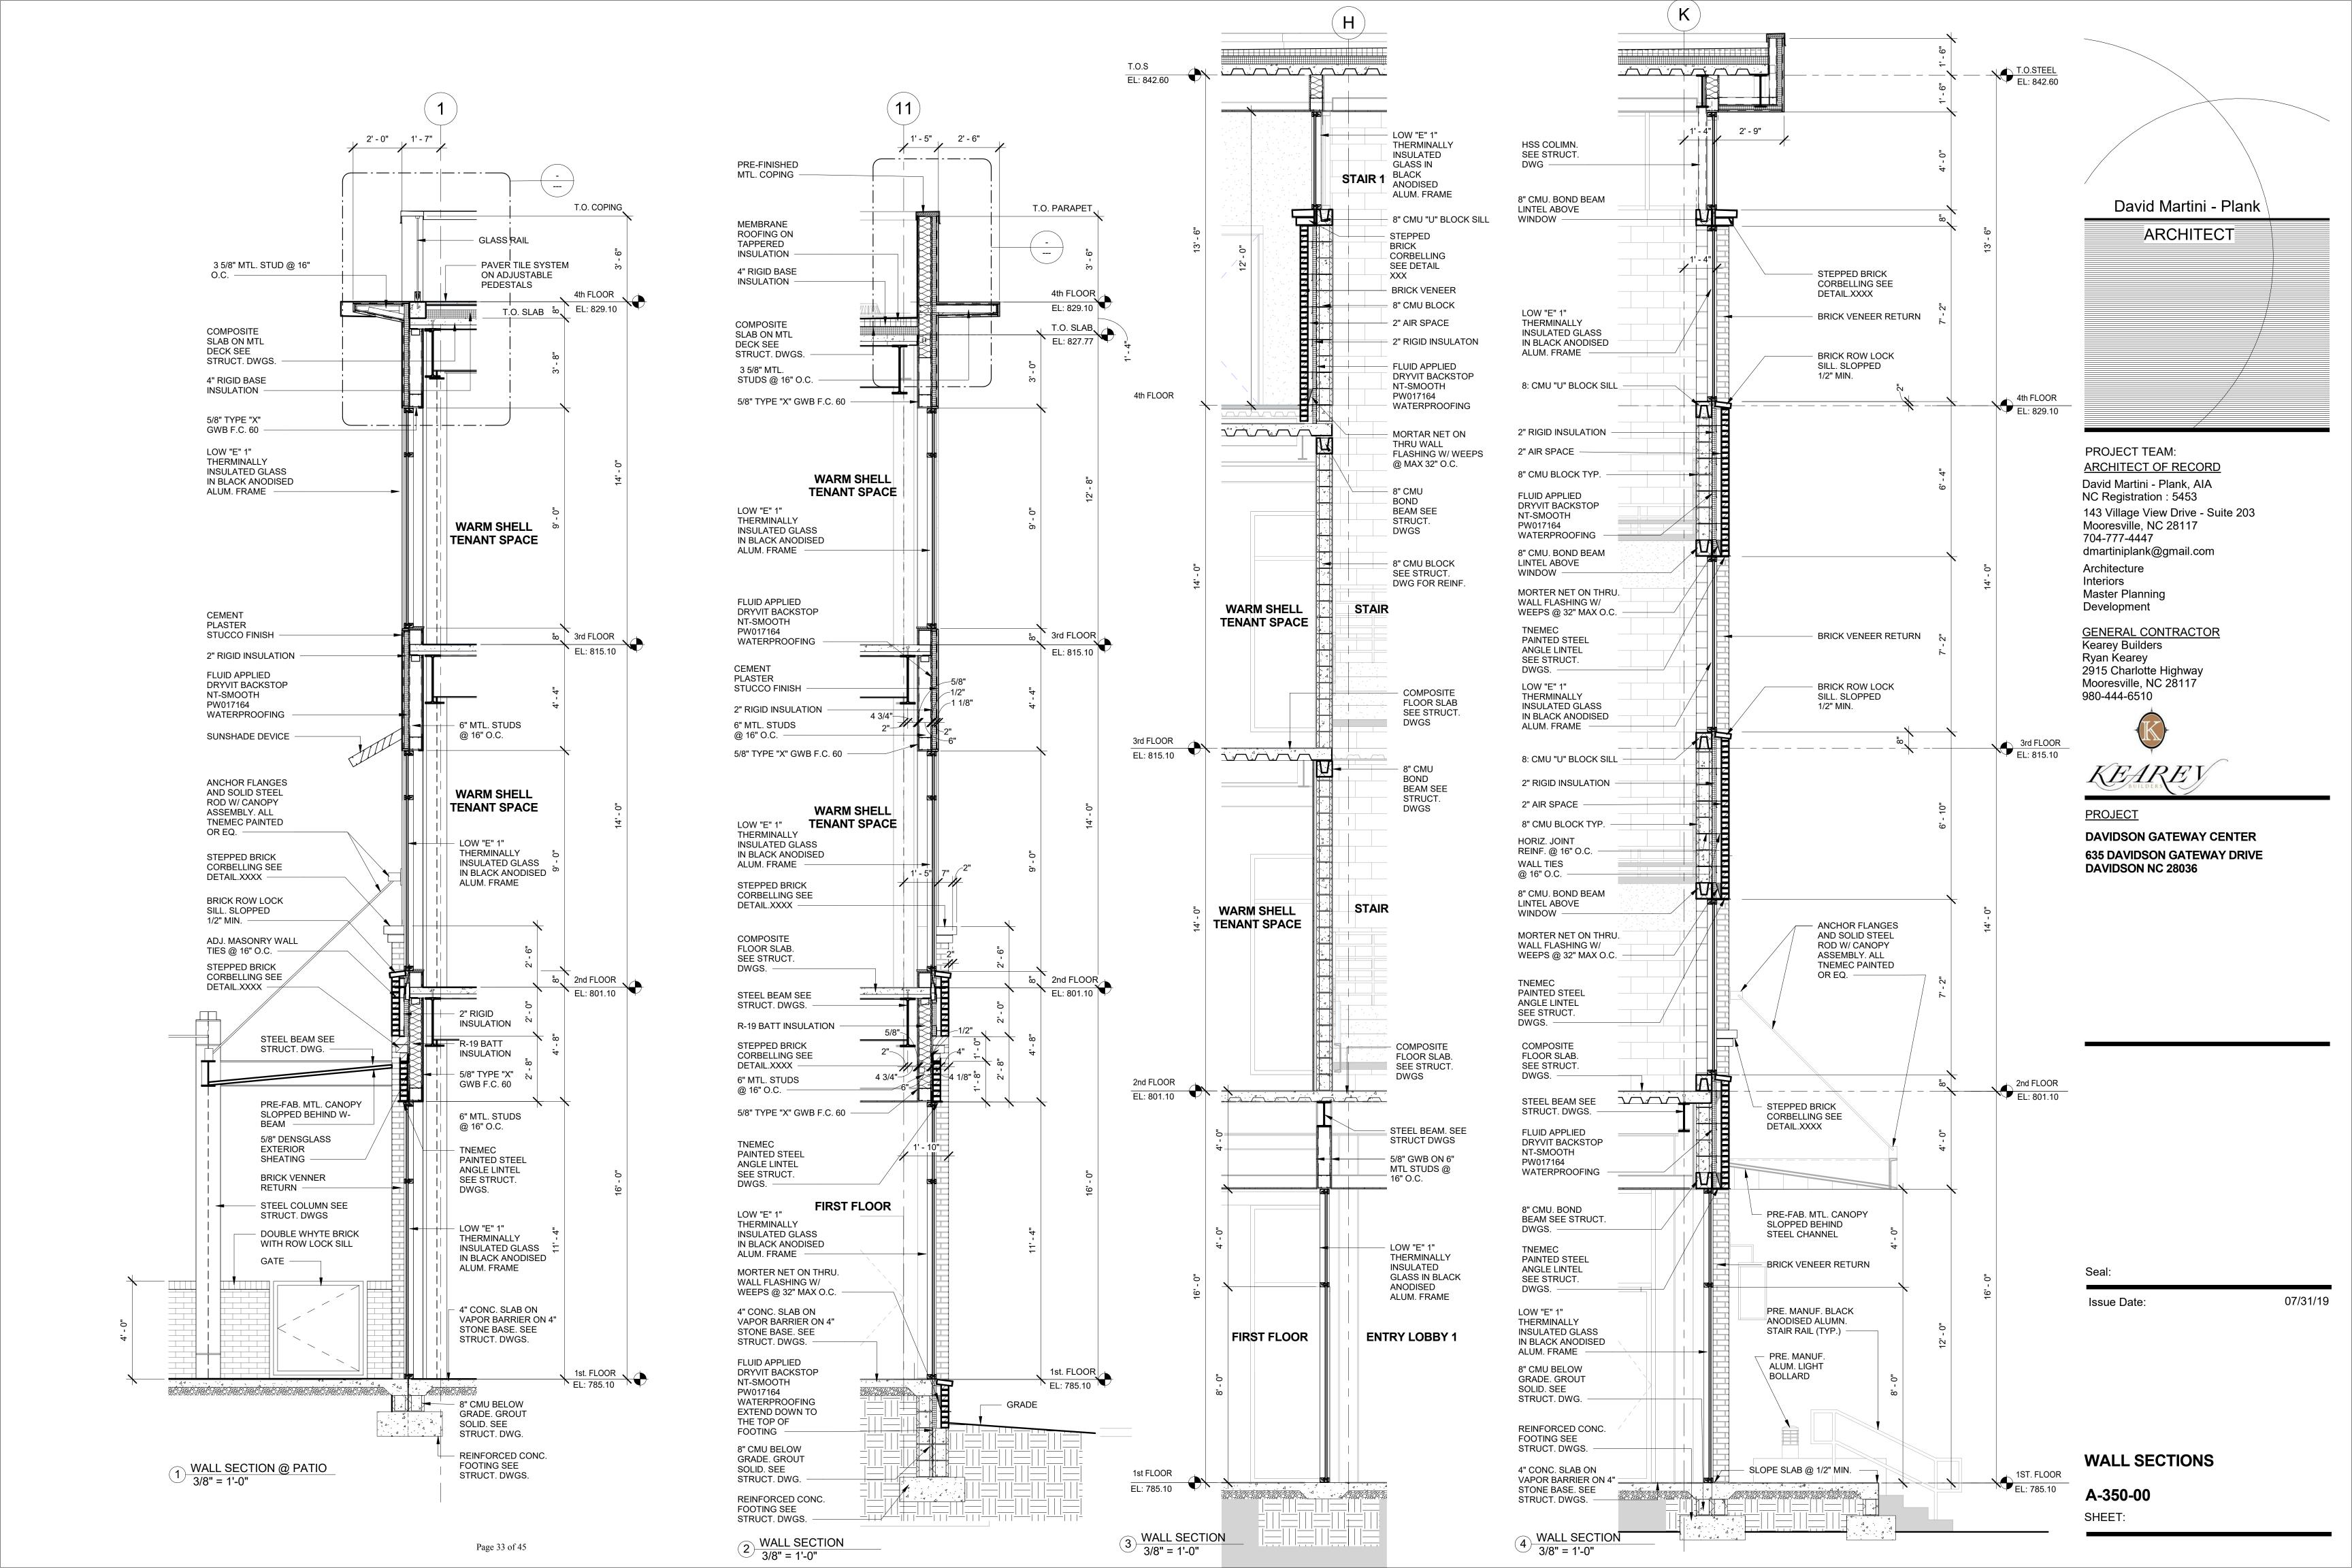

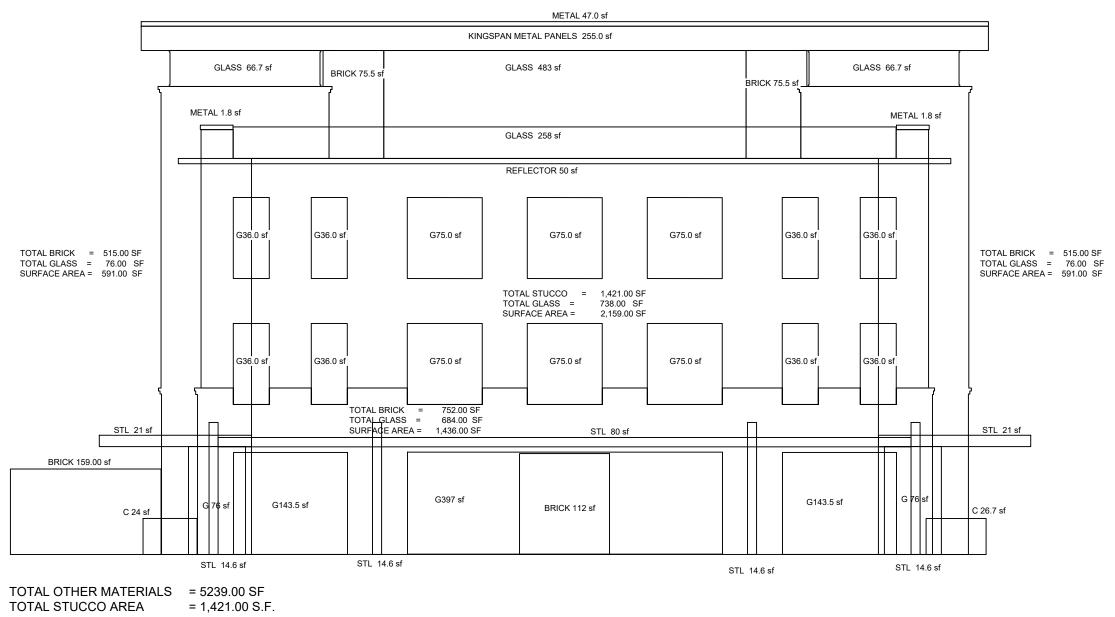

TOTAL SURFACE AREA

Max. STUCCO AREA (req)
PERCENTAGE STUCCO


1,421.00 6.1.

6,660.00 SF

6,660.00 x 0.25 = 1,665.00 SF

1,421.00 / 6,660.00 = 21.33%


PERCENTAGE OF STUCCO @ FACADE NOT GREATER THAN 25 %

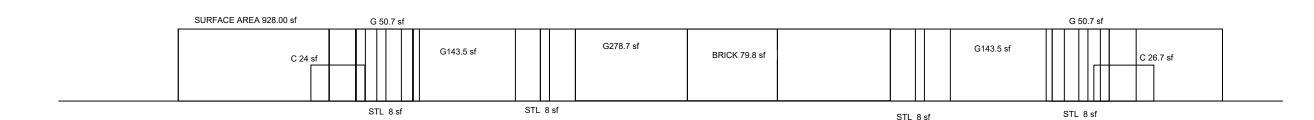


TOTAL AREA = 928.2 SF TOTAL GLASS = 616.4 S.F. PERCENTAGE TRANSPARENCY 616.4 / 928.2 = 66.4 %

PERCENTAGE OF TRANSPARENY @ FIRST FLOOR AT LEAST 65%



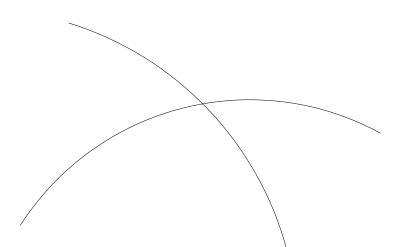

David Martini - Plank

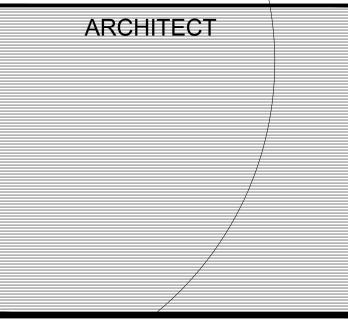

PROJECT TEAM:

GENERAL CONTRACTOR

Kearey Builders Ryan Kearey 2915 Charlotte Highway Mooresville, NC 28117 980-444-6510

ARCHITECT OF RECORD

David Martini - Plank, AIA NC Registration : 5453

143 Village View Drive - Suite 203 Mooresville, NC 28117 704-777-4447 dmartiniplank@gmail.com

Architecture Interiors Master Planning Development

PROJECT


DAVIDSON GATEWAY CENTER 635 DAVIDSON GATEWAY DRIVE DAVIDSON NC 28036

Issue Date:

07/31/19

SOUTH ELEVATION

MA-101-00 SHEET:

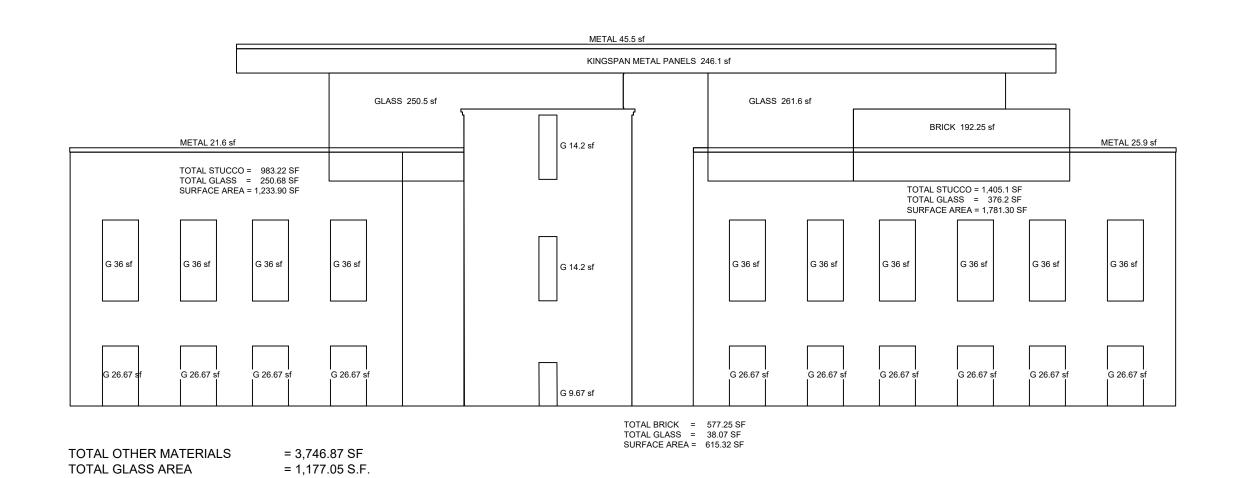


PERCENTAGE OF TRANSPARENY @ UPPER FLOORS AT LEAST 30%


= 4,923.92 SF

PERCENTAGE TRANSPARENCY 1,177.05 / 4,923.92 = 23.9%


TOTAL SURFACE AREA

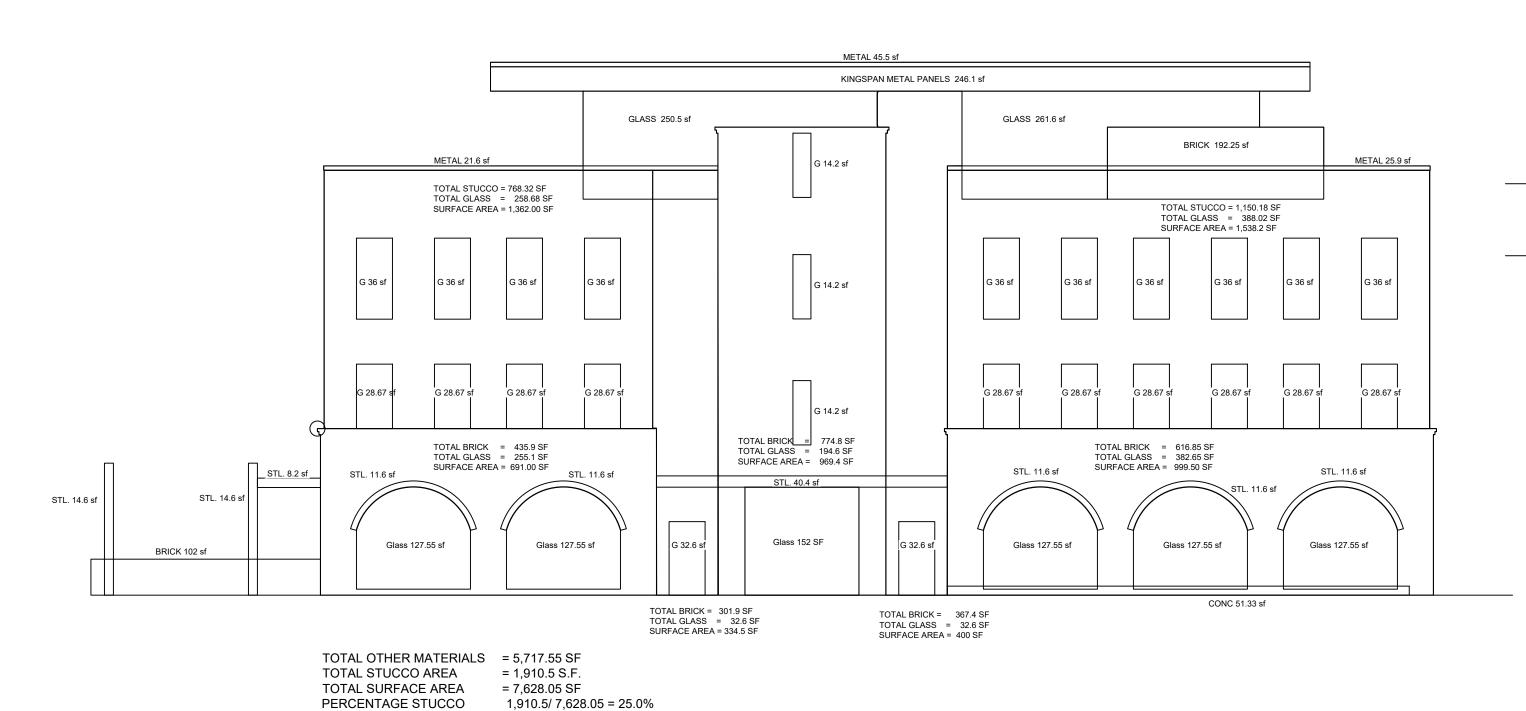

PERCENTAGE OF STUCCO @ FACADE NOT GREATER THAN 25%

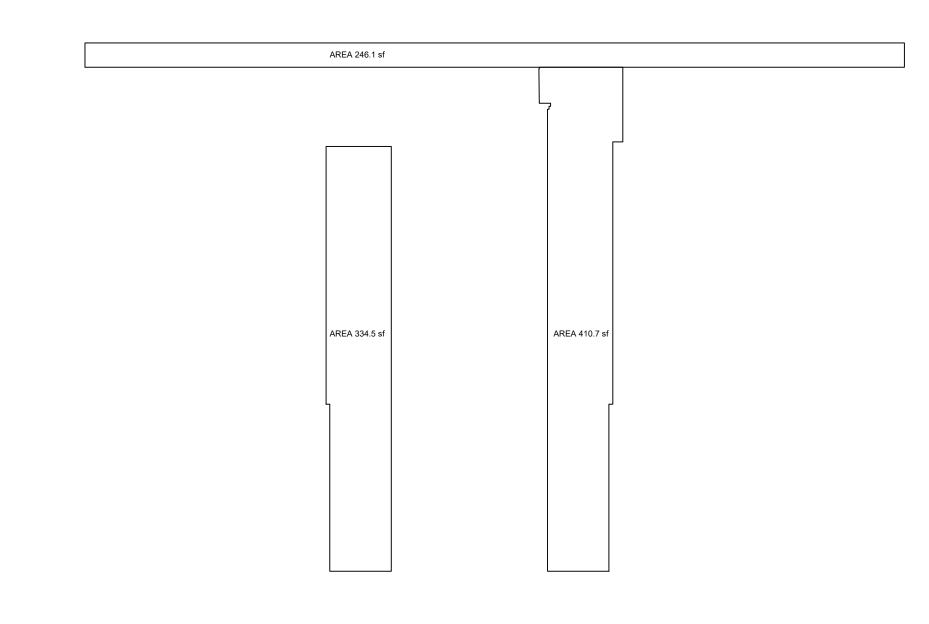




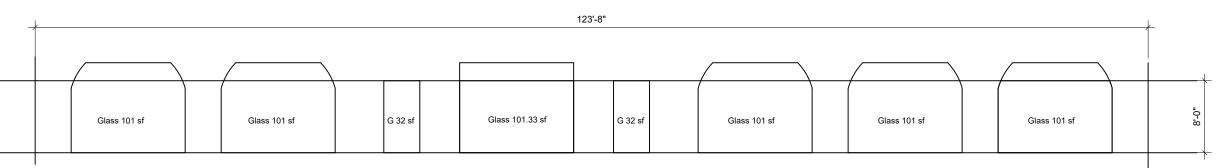

TOTAL AREA 989 SF TOTAL GLASS (WITH ROUND GLASS IN LAST BAY) = 637.74 S.F. PERCENTAGE TRANSPARENCY 637.74 / 989 = 64.48 %

TOTAL GLASS (WITH LAST BAY) = 670.33 S.F. PERCENTAGE TRANSPARENCY 670.33 / 989 = 67.7 % > 65 %


TOTAL GLASS FIRST FLOOR FACADE

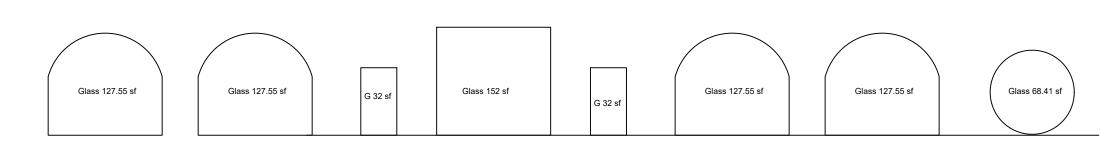

TOTAL AREA 989 SF TOTAL GLASS (WITHOUT LAST BAY) = 726.2 S.F. PERCENTAGE TRANSPARENCY 726.2 / 989 = 73.4 %

TOTAL GLASS (WITH LAST BAY) = 794.61 S.F. PERCENTAGE TRANSPARENCY 794.61 / 989 = 80.3 %

PERCENTAGE OF TRANSPARENY @ FIRST FLOOR AT LEAST 65%

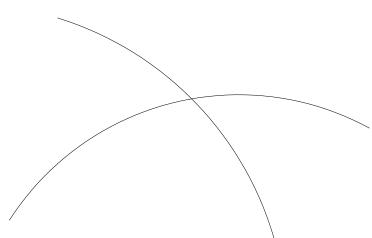

David Martini - Plank ARCHITECT

PROJECT TEAM:

GENERAL CONTRACTOR Kearey Builders Ryan Kearey 2915 Charlotte Highway Mooresville, NC 28117 980-444-6510

ARCHITECT OF RECORD David Martini - Plank, AIA NC Registration: 5453

143 Village View Drive - Suite 203 Mooresville, NC 28117 704-777-4447 dmartiniplank@gmail.com

Architecture Interiors Master Planning Development

PROJECT

DAVIDSON GATEWAY CENTER 635 DAVIDSON GATEWAY DRIVE DAVIDSON NC 28036


Issue Date:

EAST ELEVATION

07/31/19

MA-102-00 SHEET:


Page 35 of 45

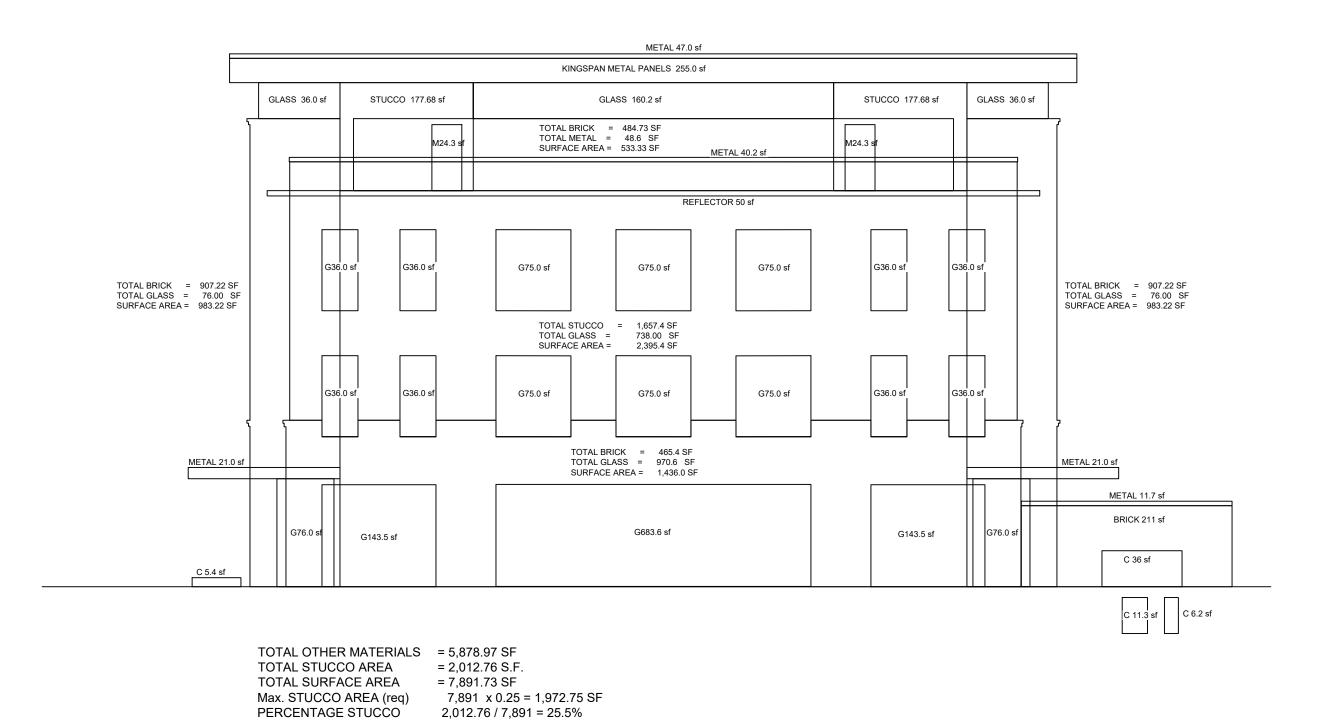


Page 36 of 45

PERCENTAGE OF STUCCO @ FACADE

GLASS GLASS

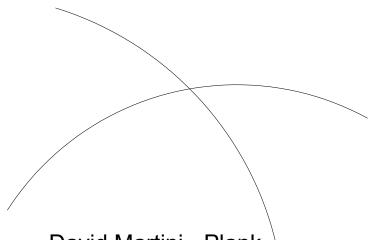

David Martini - Plank

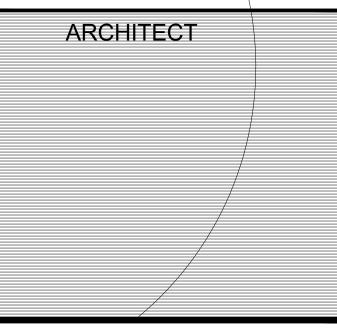

PROJECT TEAM:

GENERAL CONTRACTOR

Kearey Builders Ryan Kearey 2915 Charlotte Highway Mooresville, NC 28117 980-444-6510

ARCHITECT OF RECORD

David Martini - Plank, AIA NC Registration : 5453

143 Village View Drive - Suite 203 Mooresville, NC 28117 704-777-4447 dmartiniplank@gmail.com

Architecture Interiors Master Planning Development

PROJECT

DAVIDSON GATEWAY CENTER 635 DAVIDSON GATEWAY DRIVE DAVIDSON NC 28036


Sea

Issue Date:

07/31/19


NORTH ELEVATION

MA-103-00 SHEET:

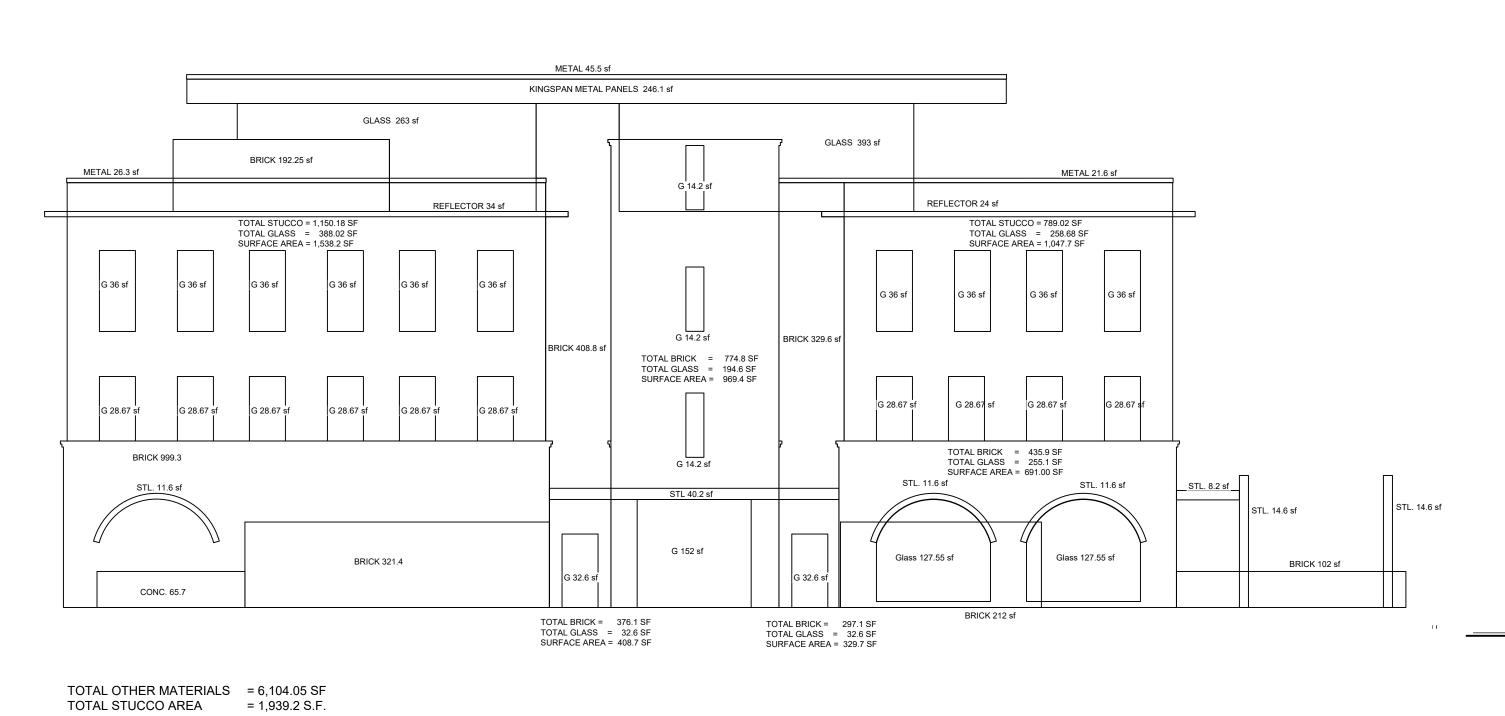



David Martini - Plank

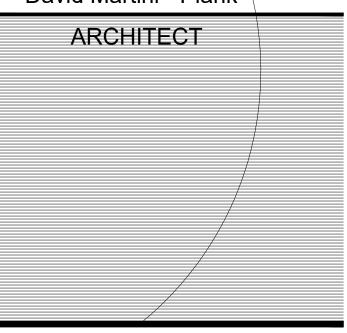

PROJECT TEAM:

GENERAL CONTRACTOR

Kearey Builders Ryan Kearey 2915 Charlotte Highway Mooresville, NC 28117 980-444-6510

ARCHITECT OF RECORD

David Martini - Plank, AIA

NC Registration : 5453

143 Village View Drive - Suite 203 Mooresville, NC 28117 704-777-4447 dmartiniplank@gmail.com

Architecture Interiors Master Planning Development

PROJECT

DAVIDSON GATEWAY CENTER 635 DAVIDSON GATEWAY DRIVE DAVIDSON NC 28036

Sea

Issue Date:

WEST ELEVATION

07/31/19

MA-104-00 SHEET:


TOTAL SURFACE AREA
Max. STUCCO AREA (req)
PERCENTAGE STUCCO

PERCENTAGE OF STUCCO @ FACADE NOT GREATER THAN 25 %

PERCENTAGE

PERCENTAGE

OF STUCCO @ FACADE NOT GREATER THAN 25 %

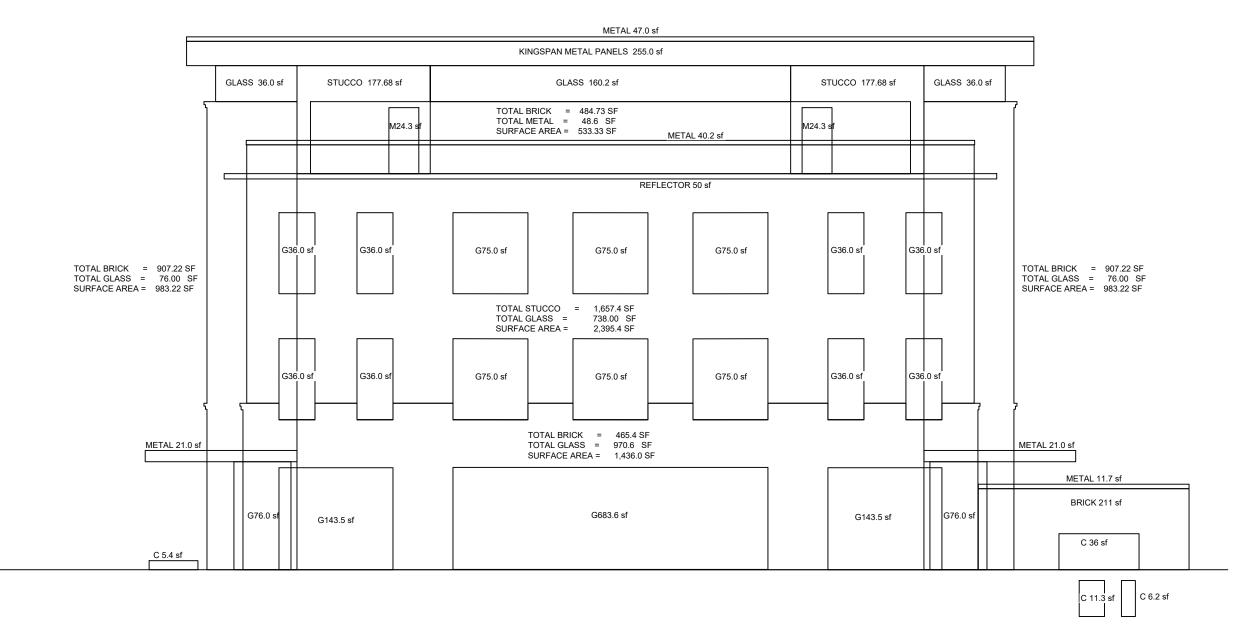


TOTAL OTHER MATERIALS = 5,878.97 SF TOTAL STUCCO AREA = 2,012.76 S.F. TOTAL STUCCO AREA = 2,012.76 S.F.


TOTAL SURFACE AREA = 7,891.73 SF

Max. STUCCO AREA (req) 7,891 x 0.25 = 1,972.75 SF


PERCENTAGE STUCCO 2,012.76 / 7,891 = 25.5%

PERCENTAGE OF STUCCO @ FACADE

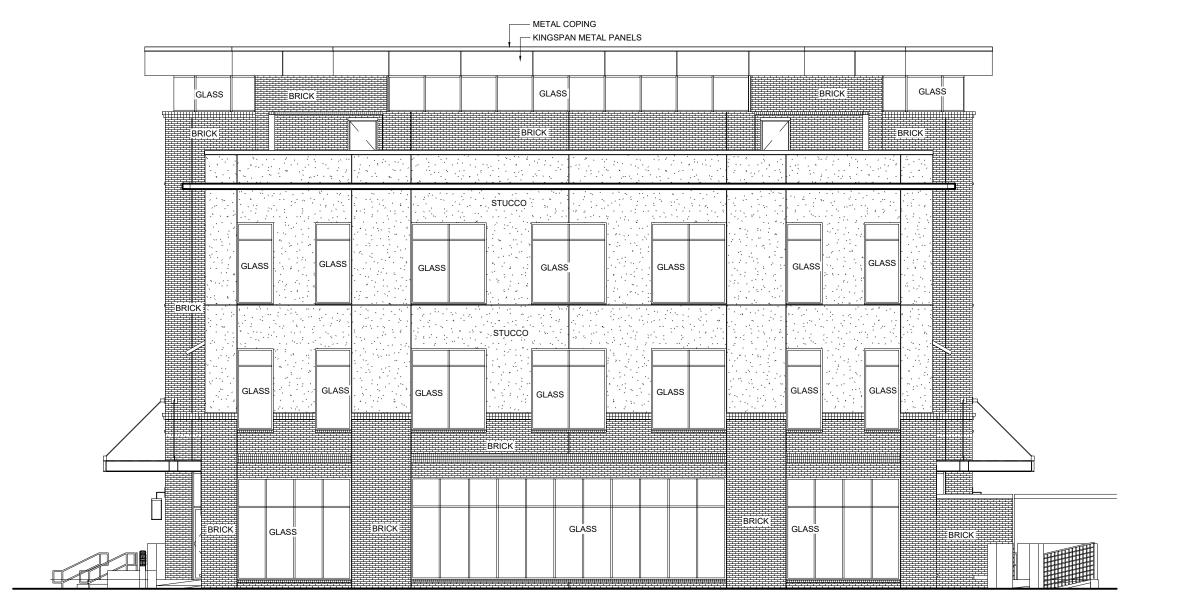

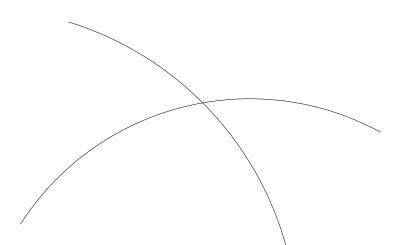

David Martini - Plank

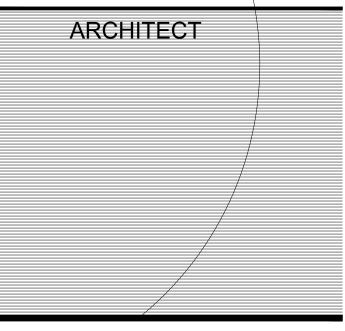

PROJECT TEAM:

GENERAL CONTRACTOR

Kearey Builders
Ryan Kearey
2915 Charlotte Highway
Mooresville, NC 28117 980-444-6510

ARCHITECT OF RECORD

David Martini - Plank, AIA NC Registration : 5453

143 Village View Drive - Suite 203 Mooresville, NC 28117 704-777-4447 dmartiniplank@gmail.com

Architecture Interiors Master Planning Development

PROJECT


DAVIDSON GATEWAY CENTER 635 DAVIDSON GATEWAY DRIVE DAVIDSON NC 28036

Issue Date:


07/31/19

NORTH ELEVATION

MA-103-00 SHEET:

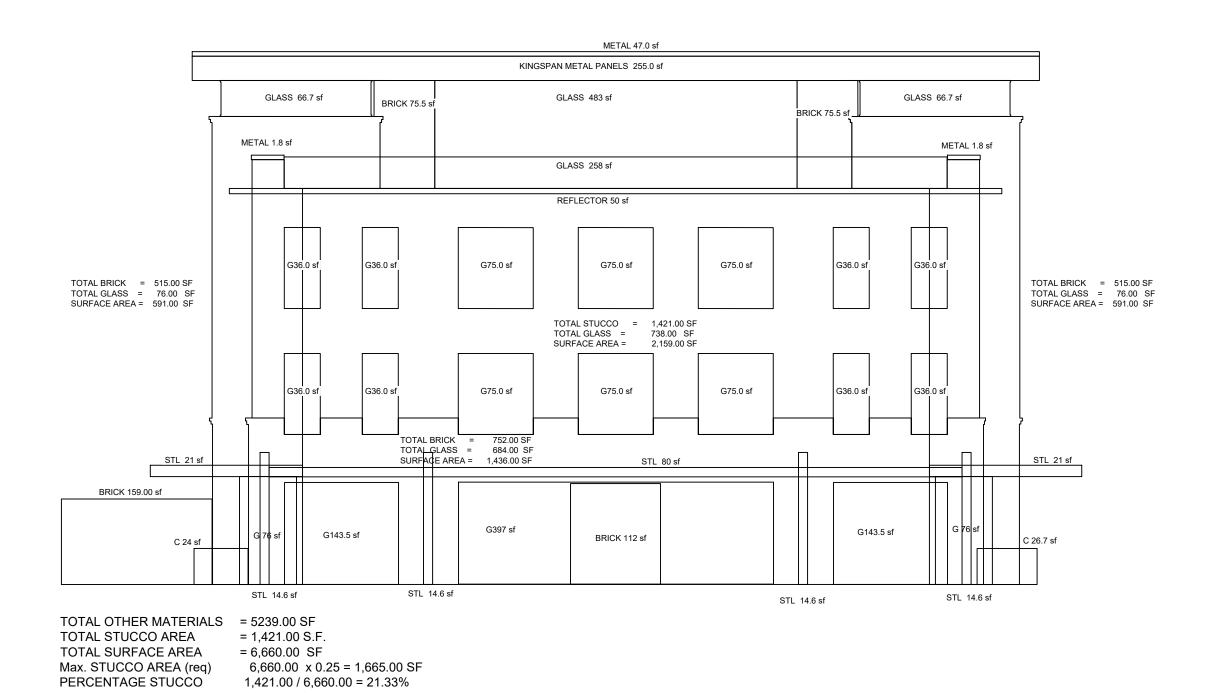


PERCENTAGE OF STUCCO @ FACADE NOT GREATER THAN 25 %

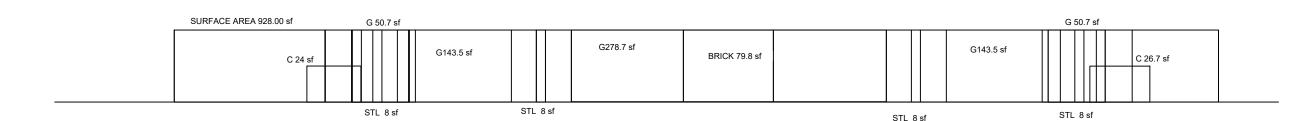


TOTAL AREA = 928.2 SF TOTAL GLASS = 616.4 S.F. PERCENTAGE TRANSPARENCY 616.4 / 928.2 = 66.4 %

PERCENTAGE OF TRANSPARENY @ FIRST FLOOR AT LEAST 65%



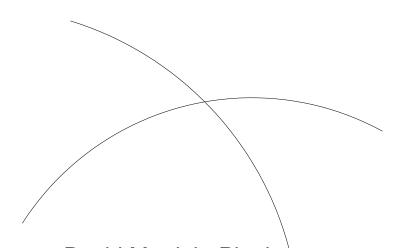

David Martini - Plank

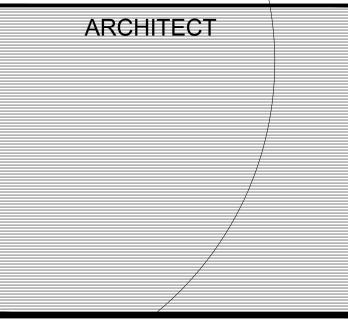

PROJECT TEAM:

GENERAL CONTRACTOR

Kearey Builders Ryan Kearey 2915 Charlotte Highway Mooresville, NC 28117 980-444-6510

ARCHITECT OF RECORD

David Martini - Plank, AIA NC Registration : 5453

143 Village View Drive - Suite 203 Mooresville, NC 28117 704-777-4447 dmartiniplank@gmail.com

Architecture Interiors Master Planning Development

PROJECT

DAVIDSON GATEWAY CENTER 635 DAVIDSON GATEWAY DRIVE DAVIDSON NC 28036


Sea

Issue Date:

07/31/19

SOUTH ELEVATION

MA-101-00 SHEET:

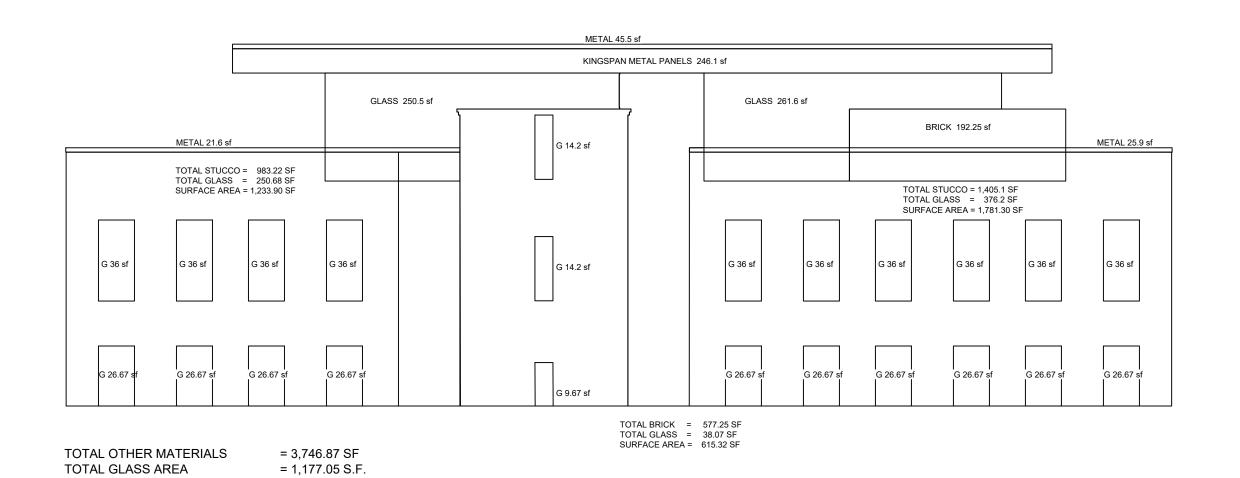


PERCENTAGE OF TRANSPARENY @ UPPER FLOORS AT LEAST 30%


= 4,923.92 SF

PERCENTAGE TRANSPARENCY 1,177.05 / 4,923.92 = 23.9%

TOTAL SURFACE AREA

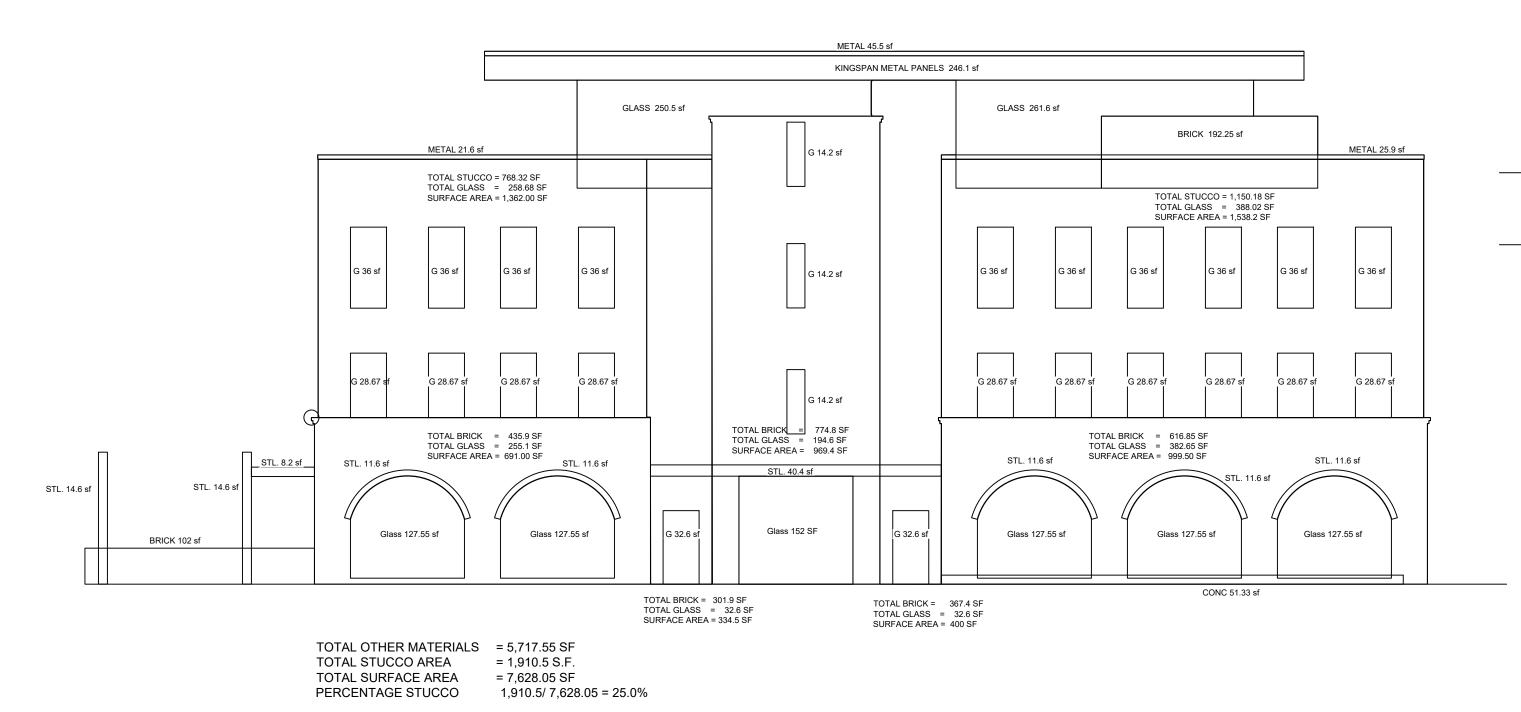


PERCENTAGE OF STUCCO @ FACADE NOT GREATER THAN 25%

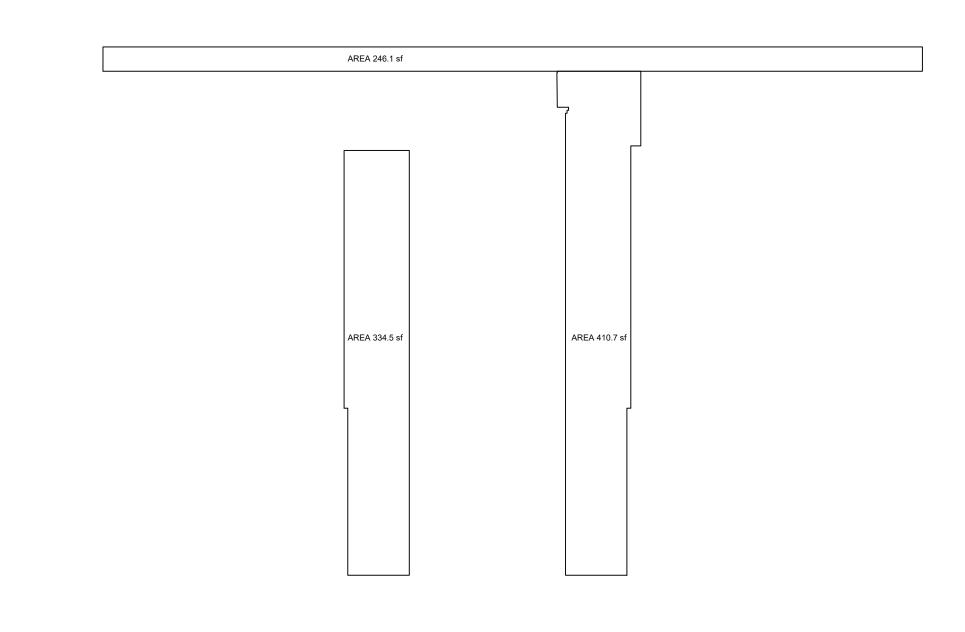

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PERCENTAGE TRANSPARENCY 637.74 / 989 = 64.48 %

TOTAL GLASS (WITH LAST BAY) = 670.33 S.F. PERCENTAGE TRANSPARENCY 670.33 / 989 = 67.7 % > 65 %

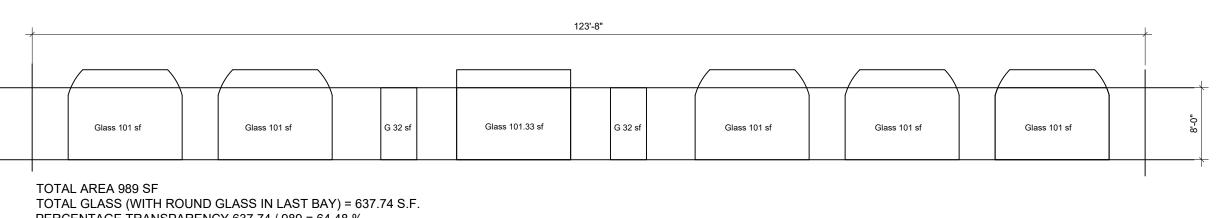
Glass 127.55 sf Glass 127.55 sf Glass 127.55 sf Glass 127.55 sf Glass 68.41 sf Glass 152 sf

TOTAL AREA 989 SF TOTAL GLASS (WITHOUT LAST BAY) = 726.2 S.F. PERCENTAGE TRANSPARENCY 726.2 / 989 = 73.4 %

TOTAL GLASS FIRST FLOOR FACADE

TOTAL GLASS (WITH LAST BAY) = 794.61 S.F. PERCENTAGE TRANSPARENCY 794.61 / 989 = 80.3 %

PERCENTAGE OF TRANSPARENY @ FIRST FLOOR AT LEAST 65%

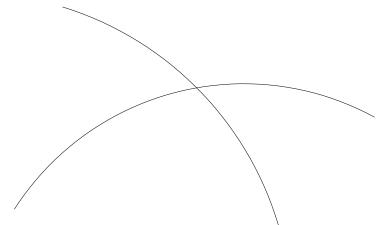

David Martini - Plank ARCHITECT

PROJECT TEAM:

GENERAL CONTRACTOR Kearey Builders Ryan Kearey 2915 Charlotte Highway Mooresville, NC 28117 980-444-6510

ARCHITECT OF RECORD David Martini - Plank, AIA NC Registration: 5453

143 Village View Drive - Suite 203 Mooresville, NC 28117 704-777-4447 dmartiniplank@gmail.com

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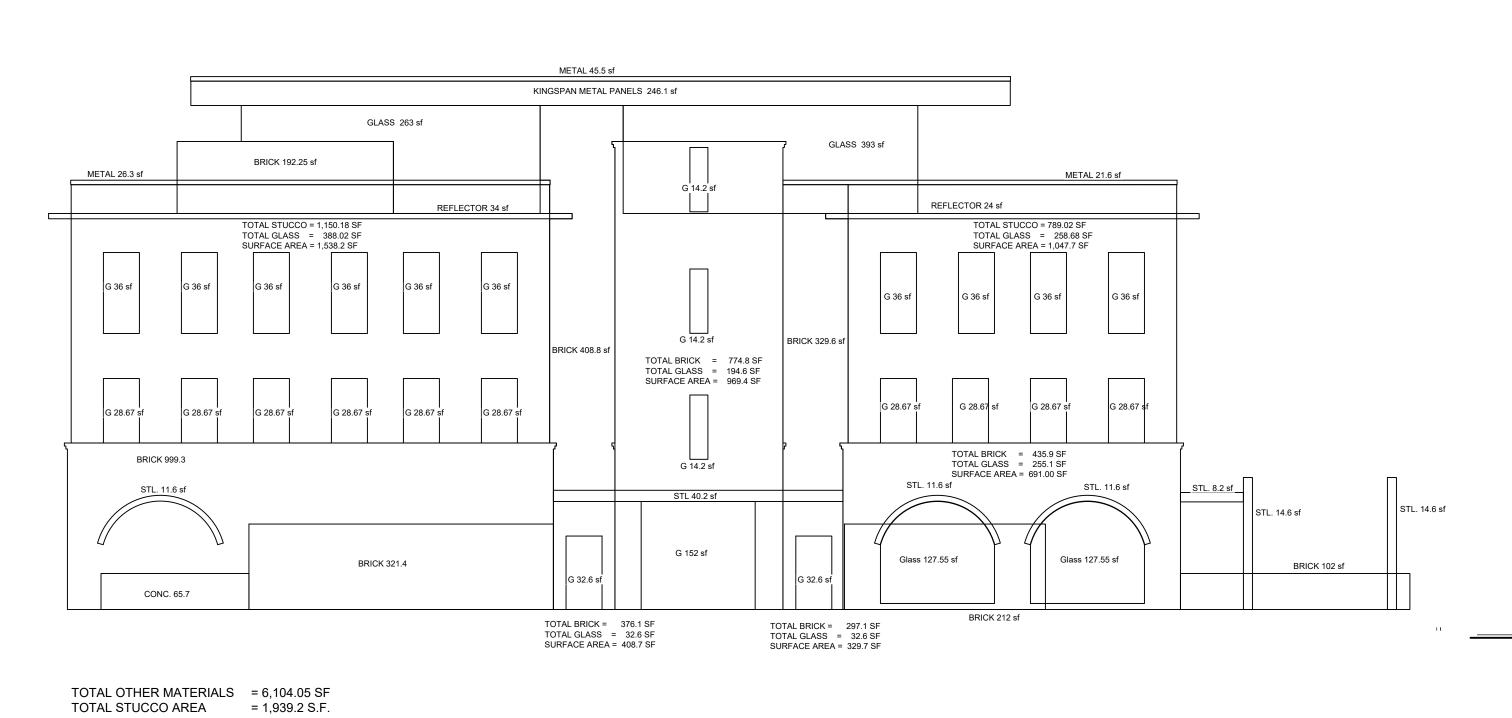
DAVIDSON GATEWAY CENTER 635 DAVIDSON GATEWAY DRIVE DAVIDSON NC 28036

Issue Date:

07/31/19


MA-102-00 SHEET:

EAST ELEVATION





David Martini - Plank

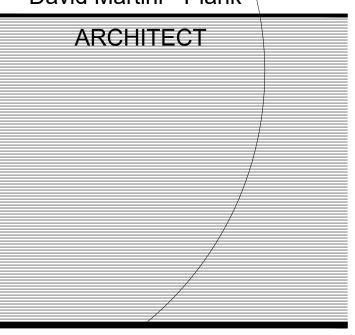

PROJECT TEAM:

GENERAL CONTRACTOR
Kearey Builders
Ryan Kearey

2915 Charlotte Highway Mooresville, NC 28117 980-444-6510

ARCHITECT OF RECORD

David Martini - Plank, AIA

NC Registration : 5453

143 Village View Drive - Suite 203 Mooresville, NC 28117 704-777-4447 dmartiniplank@gmail.com

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DAVIDSON GATEWAY CENTER 635 DAVIDSON GATEWAY DRIVE DAVIDSON NC 28036

Seal:

Issue Date:

07/31/19

WEST ELEVATION

MA-104-00 SHEET:

PERCENTAGE OF STUCCO @ FACADE NOT GREATER THAN 25 %

TOTAL SURFACE AREA

Max. STUCCO AREA (req)
PERCENTAGE STUCCO

1,000.2 S.1

8,043.25 SF

8,043.25 x 0.25 = 2,010.8 SF

1,939.2 / 8,043.25 = 24.1%



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ARCHITECT

PROJECT TEAM:

ARCHITECT OF RECORD

David Martini - Plank, AIA

NC Registration: 5453

143 Village View Drive - Suite 203

Mooresville, NC 28117

704-777-4447

dmartiniplank@gmail.com

Architecture
Interiors

Master Planning
Development

GENERAL CONTRACTOR
Kearey Builders
Ryan Kearey
2915 Charlotte Highway
Mooresville, NC 28117
980-444-6510



<u>PROJECT</u>

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Issue Date:

07/31/19

PERSPECTIVE VIEWS

A-459.00

SHEET:



David Martini - Plank

ARCHITECT

PROJECT TEAM:

ARCHITECT OF RECORD

David Martini - Plank, AIA

NC Registration : 5453

143 Village View Drive - Suite 203

Mooresville, NC 28117

704-777-4447

dmartiniplank@gmail.com

Architecture
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Development

GENERAL CONTRACTOR
Kearey Builders
Ryan Kearey
2915 Charlotte Highway
Mooresville, NC 28117
980-444-6510



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PERSPECTIVE VIEW

A-460.00 SHEET:

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Davidson Gateway Building – Proposed Renderings

1. Proposed Building (front view)



2. Proposed Building (front/angled view)



3. Proposed Building (roof top view)

