

TOWN OF DAVIDSON DESIGN REVIEW BOARD 7:00PM Board Room in Town Hall a 216 S Main St, Davidson, NC

September 18, 2019

- I. CALL TO ORDER
- II. SILENT ROLL CALL
- III. CHANGES TO THE AGENDA
- IV. REVIEW/APPROVAL OF THE MINUTES
 - (a) Minutes 2019 August 21
- V. OLD BUSINESS
 - (a) Davidson Gateway Individual Building
- VI. NEWBUSINESS
 - (a) Davidson Green School Addition FYI
- VII. ADJOURN



Agenda Title: Minutes 2019 August 21

Summary:

ATTACHMENTS:

Description Upload Date Type

□ Minutes 2019 August 21 9/6/2019 Cover Memo

Meeting Minutes Design Review Board

Town of Davidson, NC August 21, 2019

A meeting of the Town of Davidson *Design Review Board* was held in the Town Hall, Board Room, 216 S. Main St.

Room, 210 S. Main St.		
Call to Order: 7:00 p.m.		
Silent Roll Call and Determination	of Quorum:	
Members Present signified by⊠:		
☑ Bruce Barteldt, Chair☑ Tom Goodwin, ViceChair☑ Mike Kessler	☑ John Burgess☑ Brian Bumann☑ Bob Sipp☑ EB Dyer	☐ Lorraine Degree☐ Jeff Osman
Town Staff Present: Lindsay Laird (P	lanner)	
Changes to the Agenda: None.		
Review/Approval of the Minutes:		
A motion was made (Tom Goodwin) submitted. It was seconded (Bob Sipp		•
Consent Item: None.		
Old Business: None.		
New Business:		

1. Davidson Gateway Individual Building FYI

Located at 635 Davidson Gateway Drive (Parcel ID 00321117) Central Business District Planning Area Proposed Four-story Commercial Building

Lindsay Laird gave an overview of the project, noting that the subject site is part of the Southeast Quadrant Master Plan (approved 1998). The applicant proposes a new four-story commercial/office building. The proposed building will be approximately 34,264 square feet total, with restaurant space on the first floor, office space on the second and third floors, and roof top event space on the fourth floor. A large +/-2,049 square foot patio is also shown off the southern building elevation. Exterior building materials will primarily be brick (two different colors), glass, and stucco (less than 25 percent per façade).

The applicant provided additional detail on the project, noting that each façade will meet transparency requirements. The applicant also noted that the proposed building will incorporate exposed steel accents (painted black) above window arches on the eastern (street-facing) building elevation. The building will not have soffit light fixtures as shown in the proposed rendering, but will have a soft under lit eyebrow. Mechanical equipment will be located on the rooftop and will be screened from all sides by a parapet.

The board asked for clarification on the stairwell on the eastern street-facing building elevation. The board did not want to see stair stringers across windows. Instead, stair stringers should cross above or below windows.

The board also requested clarification on the primary entrance to the building, facing Davidson Gateway Drive. The applicant explained that the proposed doors are not facing the street and instead face north towards the proposed parking area. The board requested that door(s) face the street as required in DPO Section 4.5.6.H (design requirements for storefront buildings): The principal entrance to a building, and any ground-level tenant space entrance, both functionally and architecturally, shall front the primary public street or a public open space such as a square, plaza, courtyard, or sidewalk.

The DRB asked for additional clarification on front setback requirements for storefront buildings in the Central Business District Planning Area. Staff explained that the DPO requires a 0' minimum and 0' maximum front setback for storefront buildings located in the Central Business District. The project team explained that if the building were to be shifted toward the property line along Davidson Gateway Drive, then there would have to be a retaining wall at the back of sidewalk due to the topography of the site. The DRB suggested that the project team pursue options to bring a portion of the building toward the property line along Davidson Gateway Drive. This could be done by shifting the building itself toward the property line or by incorporating additional hardscape/pedestrian features up to the property line, similar to the Jetton Street frontage at The Linden apartment building.

After further discussion, the board also requested that the applicant address the following additional items prior to a decision on the proposed project:

- Provide detail on the patio fireplace;
- Provide cut sheets for all exterior light fixtures;
- Provide material sample boards including colors, glazing, tinting, etc.;
- Clarify perpendicular versus slanted window shades on second floor (Perpendicular window shades are preferred);
- Consider incorporating larger windows on stairwell fronting Davidson Gateway Drive;
- Make sure that all elevations and renderings match.

No further action was taken on this FYI item.

Other Items: None.

Adjourn: A motion was made to adjourn (John Burgess), seconded (EB Dyer), and approved unanimously. The meeting was adjourned at 9:02 pm.

Approval of Minutes:	
Date:	By:
Please note: This is a summary of t	the meeting and not to be considered a complete transcript.



Agenda Title: Davidson Gateway Individual Building

Summary:

ATTACHMENTS:

	Description	Upload Date	Type
D	Davidson Gateway Individual Building - Staff Analysis	9/6/2019	Exhibit
D	Davidson Gateway Individual Building - Plans	9/6/2019	Exhibit
ם	Davidson Gateway Individual Building - Materials and Renderings	9/6/2019	Exhibit

Town of Davidson, NC Design Review Board: Staff Analysis September 18, 2019

Project: Davidson Gateway Individual Building

Location: 635 Davidson Gateway Drive (Parcel ID 00321117)

Applicant: David Martini-Plank

Designer: David Martini-Plank, Architect

Planning Area: Central Business District

This project was presented to the DRB for FYI review at the August 21 regular meeting.

The applicant proposes a new four-story commercial/office building at 635 Davidson Gateway Drive, which is part of the 1998 Southeast Quadrant Master Plan. The proposed building will be +/- 34,264 square feet total, with restaurant space on the first floor, office space on the second and third floors, and roof top event space on the fourth floor. A large +/-2,049 square foot patio is also shown off the southern building elevation.

At the August FYI review, the DRB raised a question as to whether or not the proposed building complies with the 0' minimum and 0' maximum front setback requirement for storefront buildings located in the Central Business District Planning Area. The project team addressed this concern by incorporating additional hardscape in the area between the 12' wide sidewalk and building, south of the primary entrance along Davidson Gateway Drive. Per notes under setback table 2-18, pedestrian features such as plazas, stoops, walks, and sidewalk cafes, etc., are included as part of the front and side setback areas.

Exterior building materials will primarily be brick (dark grey and cream), glass (light grey glazing), and stucco (light grey; less than 25 percent per façade). All brick at the first floor and stair towers will be dark grey with light grey mortar. The vertical infill brick between stair towers, from the first floor to the fourth floor will be a cream color. Stucco at second, third, and fourth floors will be light grey. Steel accent arches (painted black) are shown above windows on the eastern building elevation (facing Davidson Gateway Drive). Handrails will be painted black to match steel accents. All doors and window systems will have black anodized aluminum frames.

Lighting details have been provided by the applicant and include LED bollard lights, aluminum wall mounted lights, diecast LED brick lights, flood lights, and decorative pendant lighting above the outdoor patio (see lighting detail sheet).

Mechanical equipment will be located on the rooftop and will be screened from all sides by the building parapet. Solid waste containers will also be screened from public view with materials similar to the building. Solid waste container screening will also be gated with black metal gates to match the steel accents on the building.

DAVIDSON PLANNING ORDINANCE:

2.2.5 CENTRAL BUSINESS DISTRICT PLANNING AREA REQUIREMENTS

C. Permitted Building Types

The following table establishes the permitted building types for the Central Business District Planning Area. Building types not listed in the Building Type table are presumed to be prohibited. Additional requirements are set out in Section 4, Site & Building Design Standards.

TABLE 2-17: CENTRAL BUSINESS DISTRICT BUILDING TYPE TABLE						
Building Types	Allowance	Design Review	Hei	ght		
			Minimum	Maximum		
Workplace	Р	R	3 stories	6 stories		
Storefront	Р	R	3 stories	6 stories		

D. Site Design Standards

1. Setback Requirements: The following table establishes the required setbacks for the Central Business District Planning Area.

	TABLE 2-1	8: CENTRAL B	USINESS DIST	RICT SETBAG	CKTABLE	
Building Types	Front S	etback	Side Se	tback	Rear Setback	
	Minimum	Maximum	Minimum	Maximum	Minimum	Maximum
Workplace ¹	0	0	0	NA	NA	NA
Storefront ¹	0	0	0	NA	NA	NA

Setbacks are measured in feet.

Any encroachment into the public right-of-way is not permitted without an encroachment agreement.

¹Pedestrian features such as plazas, stoops, walks, and sidewalk cafes, etc., are included as part of the front and side setback areas.

4.4 GENERAL BUILDING DESIGN REQUIREMENTS

Section 4.4.1 Standards

B. Form and Massing

2. For large scale buildings, the front façade shall create repetitive bays, or the façade shall be divided into an asymmetrical, yet balance composition.

C. Facade Articulation

All building facades visible from a public street or park/open space shall have:

- 1. A recognizable base, distinguished from the body of the building by features such as, but not limited to:
 - a. Thicker walls, ledges or sills;
 - b. Visually heavier materials (such as brick, stone, tile or other masonry) than those used on the body of the building; and/or
 - c. Lighter or darker colored materials, mullions, panels or planters.

- 2. A recognizable top, occupying the highest portion of the building and distinguished from the body of the building by features such as, but not limited to:
 - a. A dimensional cornice capping the top of a building wall;
 - b. Different materials or differently colored materials;
 - c. A roof overhang with brackets; and/or
 - d. Stepped parapets.
- 3. Large building facades shall be modulated through the use of repetitive bays separated by piers or columns, the use of reveals or recesses in the surface of the wall itself, the placement of window and door openings, or the placement of balconies, awnings, canopies, and sunshades.

E. Materials

- 1. Materials shall be selected for suitability to the type of building and design for which they are used.
- 2. Piecemeal embellishment and frequent changes in material should be avoided.
- 3. All sides of the building should use materials consistent with those on the front if visible from public streets or neighboring properties, and should be carefully designed with similar detailing, comparable quality, and compatible materials.
- 4. Building materials and colors shall be:
 - a. Complementary to the materials already being used in the neighborhood, or
 - b. If dissimilar materials are being proposed, other characteristics such as scale, proportion, form, architectural detailing, color, and texture shall be used to ensure that the building relates to the rest of the neighborhood.
- 5. All facades visible from a public street or park/open space shall utilize high-quality finish materials including, but not limited to:
 - a. Brick, masonry, or stone
 - b. Integrally tinted, textured masonry block
 - c. Stucco
 - d. Wood or cementitious siding
 - e. Glass

Stucco or EIFC system finished may be used as secondary materials and should not be greater than 25 percent of a façade.

F. Architectural Details

- 1. Windows and door openings shall be arranged and proportioned so that vertical dimensions dominate horizontal dimensions. To the extent possible, upper story windows shall be vertically aligned with the location of windows and doors on the ground level, including storefront or display windows.
- 2. Architectural treatments which create the appearance of false entrances facing the street are prohibited. Faux windows and doors are prohibited. Visible false fronts are prohibited.
- 3. Architectural elements like openings, sills, bulkheads, columns, and other architectural features shall be used to establish human scale at the street level.
- 4. Fenestration shall be architecturally related to the style, materials, colors, and details of the building.
- 6. The main entry to a building should be emphasized at the street level. Appropriate methods include, but are not limited to:
 - a. Recessing the door within a larger cased opening.
 - b. Flanking the door with columns, decorative fixtures or other details.

c. An awning or canopy, providing a sheltered transition to the interior.

4.5 SPECIFIC BUILDING TYPE REQUIREMENTS Section 4.5.6 Storefront Building Type

Storefront buildings may accommodate either single or multiple uses or tenants in a single building. A group of storefront buildings may be combined to form a mixed-use neighborhood center. Individual storefront buildings shall be designed to accommodate commercial/retail uses on the first floor, though office or residential uses are permitted. Upper Floors are appropriate for office or residential use. They are a minimum of two stories, typically are aligned adjacent to the public sidewalk and include a high percentage of transparency in the ground level façade to encourage pedestrian activity. All storefront buildings are subject to the Individual Building process and Design Review Board approval.

- A. The first floor facing the primary streets shall be designed to accommodate retail uses.
- B. At least 65% of the first floor façade between 2'-0" and 10'-0" above grade facing the primary streets must be transparent. At least 30% of the upper floors facades between 3'-0" and 120'-0" above finished floor must be transparent.
- C. The first floor shall be taller than upper floors and lower floors should be differentiated architecturally to create a sense of human scale.
- D. Building elements shall have a dominant vertical proportion.
- E. All buildings shall provide street level, pedestrian-oriented, active uses on principal street fronts.
- F. Large buildings fronting multiple streets should provide entrances from each street.
- G. Major building entrances that provide access to the primary use of the building or a central lobby shall be distinguished from the entrances used for secondary uses.
- H. The principal entrance to a building, and any ground-floor tenant space entrance, both functionally and architecturally, shall front the primary public street or a public open space such as a square, plaza, courtyard, or sidewalk.

T:\Planning_Shared_(Common)\04.BOARDS COMMISSIONS\Design Review\Agenda Packets\2019 DRB Agendas\20190918 DRB HPC Agendas\DRB\Davidson Gateway Building

Davidson Gateway Building – Existing Conditions


1. Existing Site (view from Davidson Gateway Drive towards the existing medical office building)



2. Existing Medical Office Building, (adjacent to subject site)



3. Existing Buildings (across Davidson Gateway Drive from subject site)

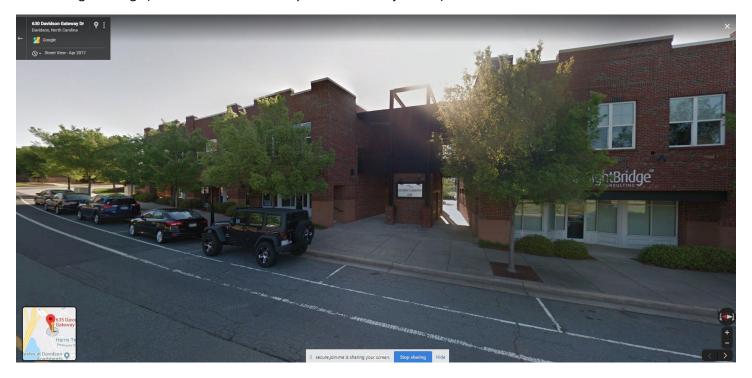

4. Existing Site (view from intersection of Davidson Gateway Drive and Gateway Crossing Drive)



DAVIDSON GATEWAY CENTER

635 DAVIDSON GATEWAY DRIVE DAVIDSON NC 28036



OWNED

PROJECT CONTACTS

OWNER:

NICK LYSSIKATOS

ARCHITECT:

DAVID MARTINI-PLANK 143 VILLAGE VIEW DRIVE SUITE 203 MOORESVILLE, NC 28117 704-777-4447 DMARTINIPLANK@GMAIL.COM

STRUCTURAL ENGINNER

JIM KUNKLE STRUCTURES INC 344 ROLLING HILL RD. MOORESVILLE, NC 28117 704-664-9824 JIM@STRUCTURESINC.COM

MECHANICAL, ELECTRICAL, PLUMBING ENGINNER:

TODD CAREY AND ASSOC. 429 CANVASBACK RD. MOORESVILLE, NC 28117 704-664-9824 TODDCAREY@TODDCAREY.COM

CIVIL ENGINNER:

PAUL CARTER
EASTLAKE ENGINEERING, PLLC
470 N BROAD STREET SUITE A
MOORESVILLE, NC 28115
865-816-4557
PCARTERTN@GMAIL.COM



ARCHITECT

PROJECT TEAM:

ARCHITECT OF RECORD

David Martini - Plank, AIA
NC Registration : 5453

143 Village View Drive - Suite 203
Mooresville, NC 28117
704-777-4447
dmartiniplank@gmail.com

Architecture
Interiors
Master Planning

GENERAL CONTRACTO
Kearey Builders
Ryan Kearey
2915 Charlotte Highway
Mooresville, NC 28117
980-444-6510

Development



<u>PROJE</u>

DAVIDSON GATEWAY CENTER 635 DAVIDSON GATEWAY DRIVE DAVIDSON NC 28036

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Issue Date:

08/12/19

TITLE SHEET

CS-100-00

VICINITY MAP 635 DAVIDSON GATEWAY DRIVE DAVIDSON NC 28036

19. THE CONTRACTOR SHALL NOT BE ENTITLED TO ADDITIONAL FEES FOR PROVIDING OPENINGS IN PARTITIONS FOR TELEPHONE, DATA, SECURITY CABLEING OR OTHER EQUIPMENT

- 20. CONTRACTOR SHALL SECURE & PROTECT THE AREA RESTRICTING UNAUTHORIZED ACCESS AND SHALL SUFFICIENTLY ENCLOSE IT TO CONTAIN DIRT, DUST, DEBRIS AND NOISE.
- 21. ALL STUDS, CEILING FURRING AND FRAMING MEMBERS SHALL BE PLACED AS TO AVOID INTERFERENCE WITH LOCATIONS OF CASEWORK, RECESSED LIGHTING FIXTURES, PIPING, DUCT WORK AND THE LIKE.
- 22. ALL PENETRATIONS THROUGH FLOOR SLAB S SUCH AS PIPING, CONDUITS, DUCTS, PNEUMATIC TUBES, ETC. SHALL BE PACKED AND SEALED WITH APPROPRIATE FIRE-RATED MATERIAL IN COMPLIANCE WITH APPLICABLE BUILDING CODES. PENETRATIONS SHALL BE SEALED TIGHT.
- 23. THE CONTRACTOR SHALL BE RESPONSIBLE FOR THE DESIGN AND INSTALLATION OF ADEQUATE SHORING AND BRACING REQUIRED FOR THE PROPER EXECUTING OF ALL WORK.
- 24. THE CONTRACTOR SHALL PERFORM A STRUCTURAL SURVEY, INCLUDING X-RAYS OR GROUND PENETRATING RADAR (GPR) OF ALL FLOOR SLABS ON GRADE AND SUPPORTING WALLS TO LOCATE EXISTING STRUCTURAL BARS, CABLES, IN-SLAB CONDUITS, UTILITIES AND OTHER INTERFERENCE THAT MAY BE IN CONFLICT WITH PROPOSED SLEEVE/PENETRATION LOCATIONS. THE X-RAY OR GPR SHALL BE PERFORMED PRIOR TO ANY CUTTING OR CHIPPING. IN THE EVENT OF CONFLICT, THE CONTRACTOR SHALL NOTIFY THE ARCHITECT AND OWNER FOR FURTHER DIRECTION.
- 25. NOISE PRODUCING WORK SHALL BE SCHEDULED WITH MANAGEMENT BEFORE 8 AM OR AFTER 6 PM. OIL, PAINT, CARPET GLUE AND OTHER ODOR PRODUCING WORK MUST BE SCHEDULED WITH MANAGEMENT FOR AFTER HOURS. BUILDING ENGINEERING MUST BE ON SITE FOR ALL AFTER HOURS WORK AT THE EXPENSE OF THE CLIENT
- 26. SYSTEMS BEING DEMOLISHED SHALL BE REMOVED BACK TO THE SOURCE. IE ELECTRICAL, TELEPHONE, DATA, PLUMBING AND HVAC. NO ABANDONED EQUIPMENT SHALL BE LEFT IN PLACE.
- 27. NEW WORK EXTENDING EXISTING CONDITIONS SHALL ALIGN WITH AND MATCH WORK EXCEPT WHERE OTHERWISE DIMENSIONED OR DETAILED.
- 28. PUBLIC AREA CORRIDORS AND CARPET MUST BE PROTECTED BY PLASTIC OR WALK OFF MASONITE MATS FROM THE ELEVATORS TO CONSTRUCTION SPACE (IF APPLICABLE).
- 29. MASONITE MUST BE USED AT ALL LOCATIONS WHERE ROLLING TRAFFIC WILL BE ROUTED.
- 30. DIMENSIONS ARE FROM THE FACE OF EXISTING FINISHED SURFACE OR NEW PARTITION SURFACE UNLESS OTHERWISE
- 31. MANAGEMENT SHALL RECEIVE A MINIMUM OF 3 DAYS NOTICE OF BUILDING SYSTEMS SHUT DOWN AND WILL BE DEPENDENT ON OWNER/AGENT APPROVAL.
- 32. ALIGNMENT INDICATION SHALL BE FINISHED SURFACE TO FINISHED SURFACE.
- 33. CENTERLINE DIMENSIONS SHALL BE MEASURED FROM CENTERLINE OF ASSEMBLY, FIXTURE OR DEVICE.
- 34. PARTITION ANGLES ARE PARALLEL, PERPENDICULAR OR 45 DEGREE ANGLES TO BUILDING PERIMETER UNLESS NOTED OTHERWISE.
- 35. ALL DIMENSIONS MARKED "CLEAR" OR "CLR" SHALL BE MAINTAINED.
- 36. CENTERLINE INDICATION AT PARTITIONS ABUTTING BUILDING ELEMENTS (MULLIONS, COLUMNS OR PIASTERS), SHALL ALIGN CENTER OF PARTITION ASSEMBLY WITH CENTER OF THE ELEMENT.
- 37. CONTRACTOR SHALL COORDINATE AND PROVIDE FIRE RETARDANT TREATED WOOD BLOCKING IN WALLS FOR MOUNTING ALL CABINETS, ALL TOILET ACCESSORIES AND ALL OTHER WALL MOUNTED ITEMS.
- FOR PARTITION TYPE. FIRE STOP ALONG PERIMETER OF RATED PARTITIONS WHERE VOIDS OCCUR, SUCH AS FLOOR OR ROOF DECKING.


38. FIRE STOP ALL PENETRATIONS IN UL RATED PARTITIONS TO MAINTAIN/ACHIEVE LEVEL OF FIRE PROTECTION REQUIRED

- 39. WHERE FACE OF A NEW PARTITION ALIGNS WITH THE FACE OF EXISTING FURRED COLUMNS OR PARTITIONS, REMOVE EXISTING CORNER BEAD, TAPE AND MUD NEW PARTITION TO EXISTING GYPSUM BOARD FOR A SMOOTH TRANSITION.
- 40. CONTRACTOR SHALL FURNISH AND INSTALL BUILDING STANDARD FIRE EXTINGUISHER CABINETS AND DEVICES PER
- 41. ALL ASPECTS OF THIS UPFIT AND SCOPE OF WORK TO MEET CURRENT ACCESSIBILITY CODES.

FIRE & EMERGENCY NOTES:

- 1. ALL DOORS IN EXIT PATH AND ALL EXTERIOR DOORS SHALL BE EQUIPPED WITH AUTOMATIC DOOR CLOSERS.
- ALL INTERIOR DOORS SHALL BE EQUIPPED WITH ADA APPROVED LEVER HANDLE HARDWARE.
- 3. ALL EXIT DOORS SHALL HAVE FREE EXITING HARDWARE OR BREAKER BARS.
- 4. RESTROOMS SHALL HAVE AUTOMATIC DOOR CLOSERS.
- 5. RESTROOMS TO BE EQUIPPED WITH STROBE AND ENUNCIATOR TIED DIRECTLY TO FIRE ALARM PULL STATIONS LOCATED AT EACH DOOR (IF APPLICABLE).
- 6. EACH EXIT DOOR SHALL HAVE IT'S OWN STROBE AND HORN MOUNTED ABOVE THE PULL STATION (PER CODE)

INDEX OF DRAWINGS CIVIL STRUCTURAL **ARCHITECTURAL** TITLE SHEET CS-100-00 C-101.00 PROJECT DATE AND SHEET INDEX C-102-00 ARCHITECTURAL SITE PLAN LS-100-00 APPENDIX B OCCUPANCY PLANS A-100-00 FIRST FLOOR CONSTRUCTION PLAN SECOND FLOOR PLAN A-101-00 A-102-00 THIRD FLOOR PLAN **MECHANICAL** A-103-00 FOURTH FLOOR CONSTRUCTION PLAN A-104-00 **ROOF CONSTRUCTION PLAN** A-160-00 FIRST FLOOR FURNITURE PLAN A-161-00 FOURTH FLOOR FURNITURE PLAN A-200-00 **ELEVATIONS** A-201-00 **ELEVATIONS** A-300-00 **BUILDING SECTION** A-350-00 WALL SECTIONS A-459-00 PERSPECTIVE VIEW A-460-00 PERSPECTIVE VIEW **ELECTRICAL PLUMBING**

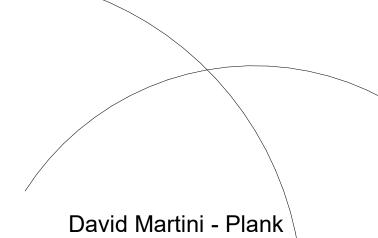

ARCHITECT

PROJECT TEAM: ARCHITECT OF RECORD David Martini - Plank, AIA NC Registration: 5453 143 Village View Drive - Suite 203 Mooresville, NC 28117 704-777-4447 dmartiniplank@gmail.com Architecture Interiors Master Planning Development

GENERAL CONTRACTOR Kearey Builders Ryan Kearey 2915 Charlotte Highway Mooresville, NC 28117 980-444-6510



PROJECT

DAVIDSON GATEWAY CENTER **635 DAVIDSON GATEWAY DRIVE DAVIDSON NC 28036**

Issue Date:

08/12/19

PROJECT DATE AND SHEET C-101.00

DAVIDSON GATEWAY CENTER PROJECT DATA:

GENERAL CONSTRUCTION REQUIREMENTS

PRIOR TO PROJECT COMMENCEMENT, PROVIDE TO OWNERS SATISFACTION

OWNERS APPROVED PROPERTY STANDARDS SPECIFICATIONS.

ARCHITECT. WORK SHALL PROCEED ONLY WITH THE ARCHITECTS APPROVAL

ARCHITECT IN A TIMELY MANOR SO AS NOT TO IMPEDE THE PROJECT SCHEDULE.

CONTRACTOR, AS REQUIRED AT THE SOLE EXPENSE OF THE GENERAL CONTRACTOR.

CONDITIONS (LATEST EDITION)

THOROUGHLY CLEANED.

DOCUMENTS

ARCHITECT

EXECUTING THE WORK.

APPLICABLE BUILDING CODES.

AT NO ADDITIONAL COST TO THE OWNERS.

1. ALL WORK SHALL BE IN ACCORDANCE WITH 2012 NORTH CAROLINA STATE BUILDING CODE & AIA A201 GENERAL

REUSE IN THE NEW CONSTRUCTION AND MATERIALS TO BE RETURNED TO BUILDING STOCK. D. A VERIFIED LIST OF EXISTING MATERIAL QUALIFIED FOR REUSE IN NEW CONSTRUCTION OR RETURN

E. LIST OF REQUIRED SIGNAGE, COMPLIANT WITH MUNICIPAL CODES, ACCESSIBILITY GUIDELINES AND

RESPONSIBLE FOR VERIFYING EXISTING CONDITIONS AND THEIR IMPACT ON THE SCOPE OF THE WORK. ANY

PROPER EXECUTION OF THE WORK, A WRITTEN REQUEST FOR INFORMATION SHALL BE SUBMITTED TO THE

PROPER EXECUTION AND COMPLETION OF THE WORK UNLESS OTHERWISE INSTRUCTED BY THE ARCHITECT.

THE CONTRACTOR SHALL BE AFFORDED ACCESS TO THE BUILDING IN ACCORDANCE WITH THE RULES AND

WORK CAUSED AS A RESULT OF THE EXECUTION OF THIS PROJECT SHALL BE REPAIRED BY THE GENERAL

10. THE MECHANICAL, PLUMBING, FIRE PROTECTION, ELECTRICAL AND FIRE ALARM WORK PRESENTED IN THESE

12. ALL WORK SHALL BE GUARANTEED BY THE CONTRACTOR FOR A PERIOD OF ONE YEAR AFTER SUBSTANTIAL

COMPLETION OF THE WORK. THIS GUARANTEE SHALL COVER ALL WORK BY THE GENERAL CONTRACTOR AND

ACCESSIBILITY GUIDELINES. THE OWNERs AND IT'S RETAINED CONSULTANTS DO NOT ASSUME ANY LIABILITY

RESULT IN DEVIATION FROM THE EXISTING ACCESSIBILITY GUIDELINES AS THEY APPLY TO THESE CONTRACT

14. ALL TRADE SHALL REVIEW ALL SHEETS IN THE CONSTRUCTION DOCUMENT SET FOR COORDINATION PURPOSES.

15. THE GENERAL CONTRACTOR SHALL PROVIDE WRITTEN NOTICE FOR CLAIMS OF ADDITIONAL OWNER COST DUE TO REVISIONS TO THE CONSTRUCTION DOCUMENTS IN A TIMELY MANNER TO THE ARCHITECT FOR REVIEW PRIOR TO

16. CONTRACTOR ASSUMES RESPONSIBILITY FOR ANY EXPENSE INCURRED (INCLUDING CONSTRUCTION SCHEDULE DELAYS). DUE TO NON DISCLOSURE OF DISCOVERED DISCREPANCIES OR CONFLICTS WITHIN CONSTRUCTION

17. A QUALIFIED SUPERINTENDENT SHALL SUPERVISE THE PROJECT SITE, COORDINATE AND ATTEND GOVERNMENT

INSPECTIONS, COORDINATE WORK AMONG TRADES AND MAINTAIN QUALITY OF MATERIAL AND CRAFTSMANSHIP.

18. CONTRACTOR ASSUMES RESPONSIBILITY FOR ANY EXPENSE INCURRED (INCLUDING CONSTRUCTION SCHEDULE

DELAYS) DUE TO CONSTRUCTION PERSONNEL SCALING DRAWINGS FOR DIMENSIONAL INFORMATION AS IT PERTAINS

TO THEIR WORK. DO NOT SCALE DRAWINGS. IF DIMENSIONS ARE IN QUESTION, OBTAIN CLARIFICATION FROM THE

DOCUMENTS OR RELATED TO EXISTING CONDITIONS IN A TIMELY MANOR.

6. THE CONTRACTOR SHALL CARRY ALL INSURANCE IN ARTICLE II OF AIA A201, MOST RECENT EDITION, THE

DISCREPANCIES BETWEEN EXISTING AND INDICATED CONDITIONS SHALL BE REPORTED IMMEDIATELY TO THE

A. APPROVED ACCESS FOR CONSTRUCTION PERSONNEL. EQUIPMENT AND MATERIALS PRIOR TO CONSTRUCTION.

B. APPROVED MEANS AND PATH FOR REMOVAL AND DISPOSAL OF DEBRIS OR MATERIAL FROM PROJECT SITE.

C. APPROVED SECURE LOCATION(S) FOR NEW MATERIALS, MATERIALS REMOVED DURING DEMOLITION FOR

THE DOCUMENTS REFLECT CONDITIONS REASONABLY INTERPRETED FROM THE EXISTING VISIBLE CONDITIONS, OR

FROM DRAWINGS OR INFORMATION FURNISHED BY THE OWNER. THE CONTRACTOR SHALL VISIT THE SITE AND BE

SHOULD THE CONTRACTOR REQUIRE ANY ADDITIONAL DETAILS OR VERBAL CLARIFICATION NECESSARY FOR THE

5. THE CONTRACTOR SHALL PAY FOR AND SECURE PERMITS, FEES, LICENSES AND INSPECTIONS NECESSARY FOR THE

CONTRACTOR SHALL FILE CERTIFICATE OF INSURANCE ACCEPTABLE TO THE OWNER PRIOR TO THE COMMENCEMENT

REGULATIONS OF THE BUILDING MANAGEMENT. THE REASONABLE USE OF THE BUILDING WATER, ELECTRICITY AND

HVAC AS REQUIRED FOR THE EXECUTION OF THE WORK IS AVAILABLE TO THE CONTRACTOR AT NO CHARGE TO THE CONTRACTOR. THE CONTRACTOR MAY USE THE TOILET ROOMS AS DIRECTED BY THE BUILDING MANAGEMENT.

UNLESS INSTRUCTED OTHERWISE BY THE OWNERs AGENT, THE REMOVAL AND DISPOSAL OF DEMOLITION AND/OR

DOCUMENTS IS INTENDED TO SHOW THE GENERAL ARRANGEMENT AND LOCATION OF EXISTSING AND PROPOSED FIXTURES AND ACCESSORIES. THE CONTRACTOR SHALL MODIFY EXISTING ELECTRICAL, PLUMBING, MECHANICAL AND

FIRE PROTECTION SYSTEMS AS REQUIRED TO ACCOMMODATE THE NEW LAYOUT AND AS REQUIRED TO MEET ALL

11. THE GENERAL CONTRACTOR SHALL BE RESPONSIBLE FOR COORDINATING THE WORK OF ALL ENGINEERS PROVIDING

DESIGN AND SPECIFICATION INFORMATION FOR THE MECHANICAL, PLUMBING, FIRE PROTECTION AND ELECTRICAL

SUB -CONTRACTORS. ANY DEFECTS IDENTIFIED DURING THE GUARANTEE PERIOD SHALL BE REPAIRED, AS REQUIRED,

13. CONSTRUCTION DOCUMENTS HAVE BEEN DEVELOPED TO ACHIEVE GENERAL COMPLIANCE WITH CURRENTLY APPLIED


REGARDING DECISIONS, AGREEMENTS, WARRANTIES, GUARANTEES AND INTERPRETATIONS MADE IN THE FIELD, THAT


CONSTRUCTION MATERIAL SHALL BE THE RESPONSIBILITY OF THE GENERAL CONTRACTOR. THE CONTRACTOR SHALL

KEEP THE CONSTRUCTION SITE FREE AND CLEAR OF ALL DEBRIS THROUGHOUT THE COURSE OF THE PROJECT. UPON COMPLETION OF THE WORK, THE ENTIRE CONSTRUCTION AREA, INCLUDING THE INTERIOR FACE OF GLAZING IS TO BE

THE CONTRACTOR SHALL BE RESPONSIBLE FOR THE PROTECTION OF ALL EXISTING WORK. ANY DAMAGE TO EXISTING

Page 14 of 69

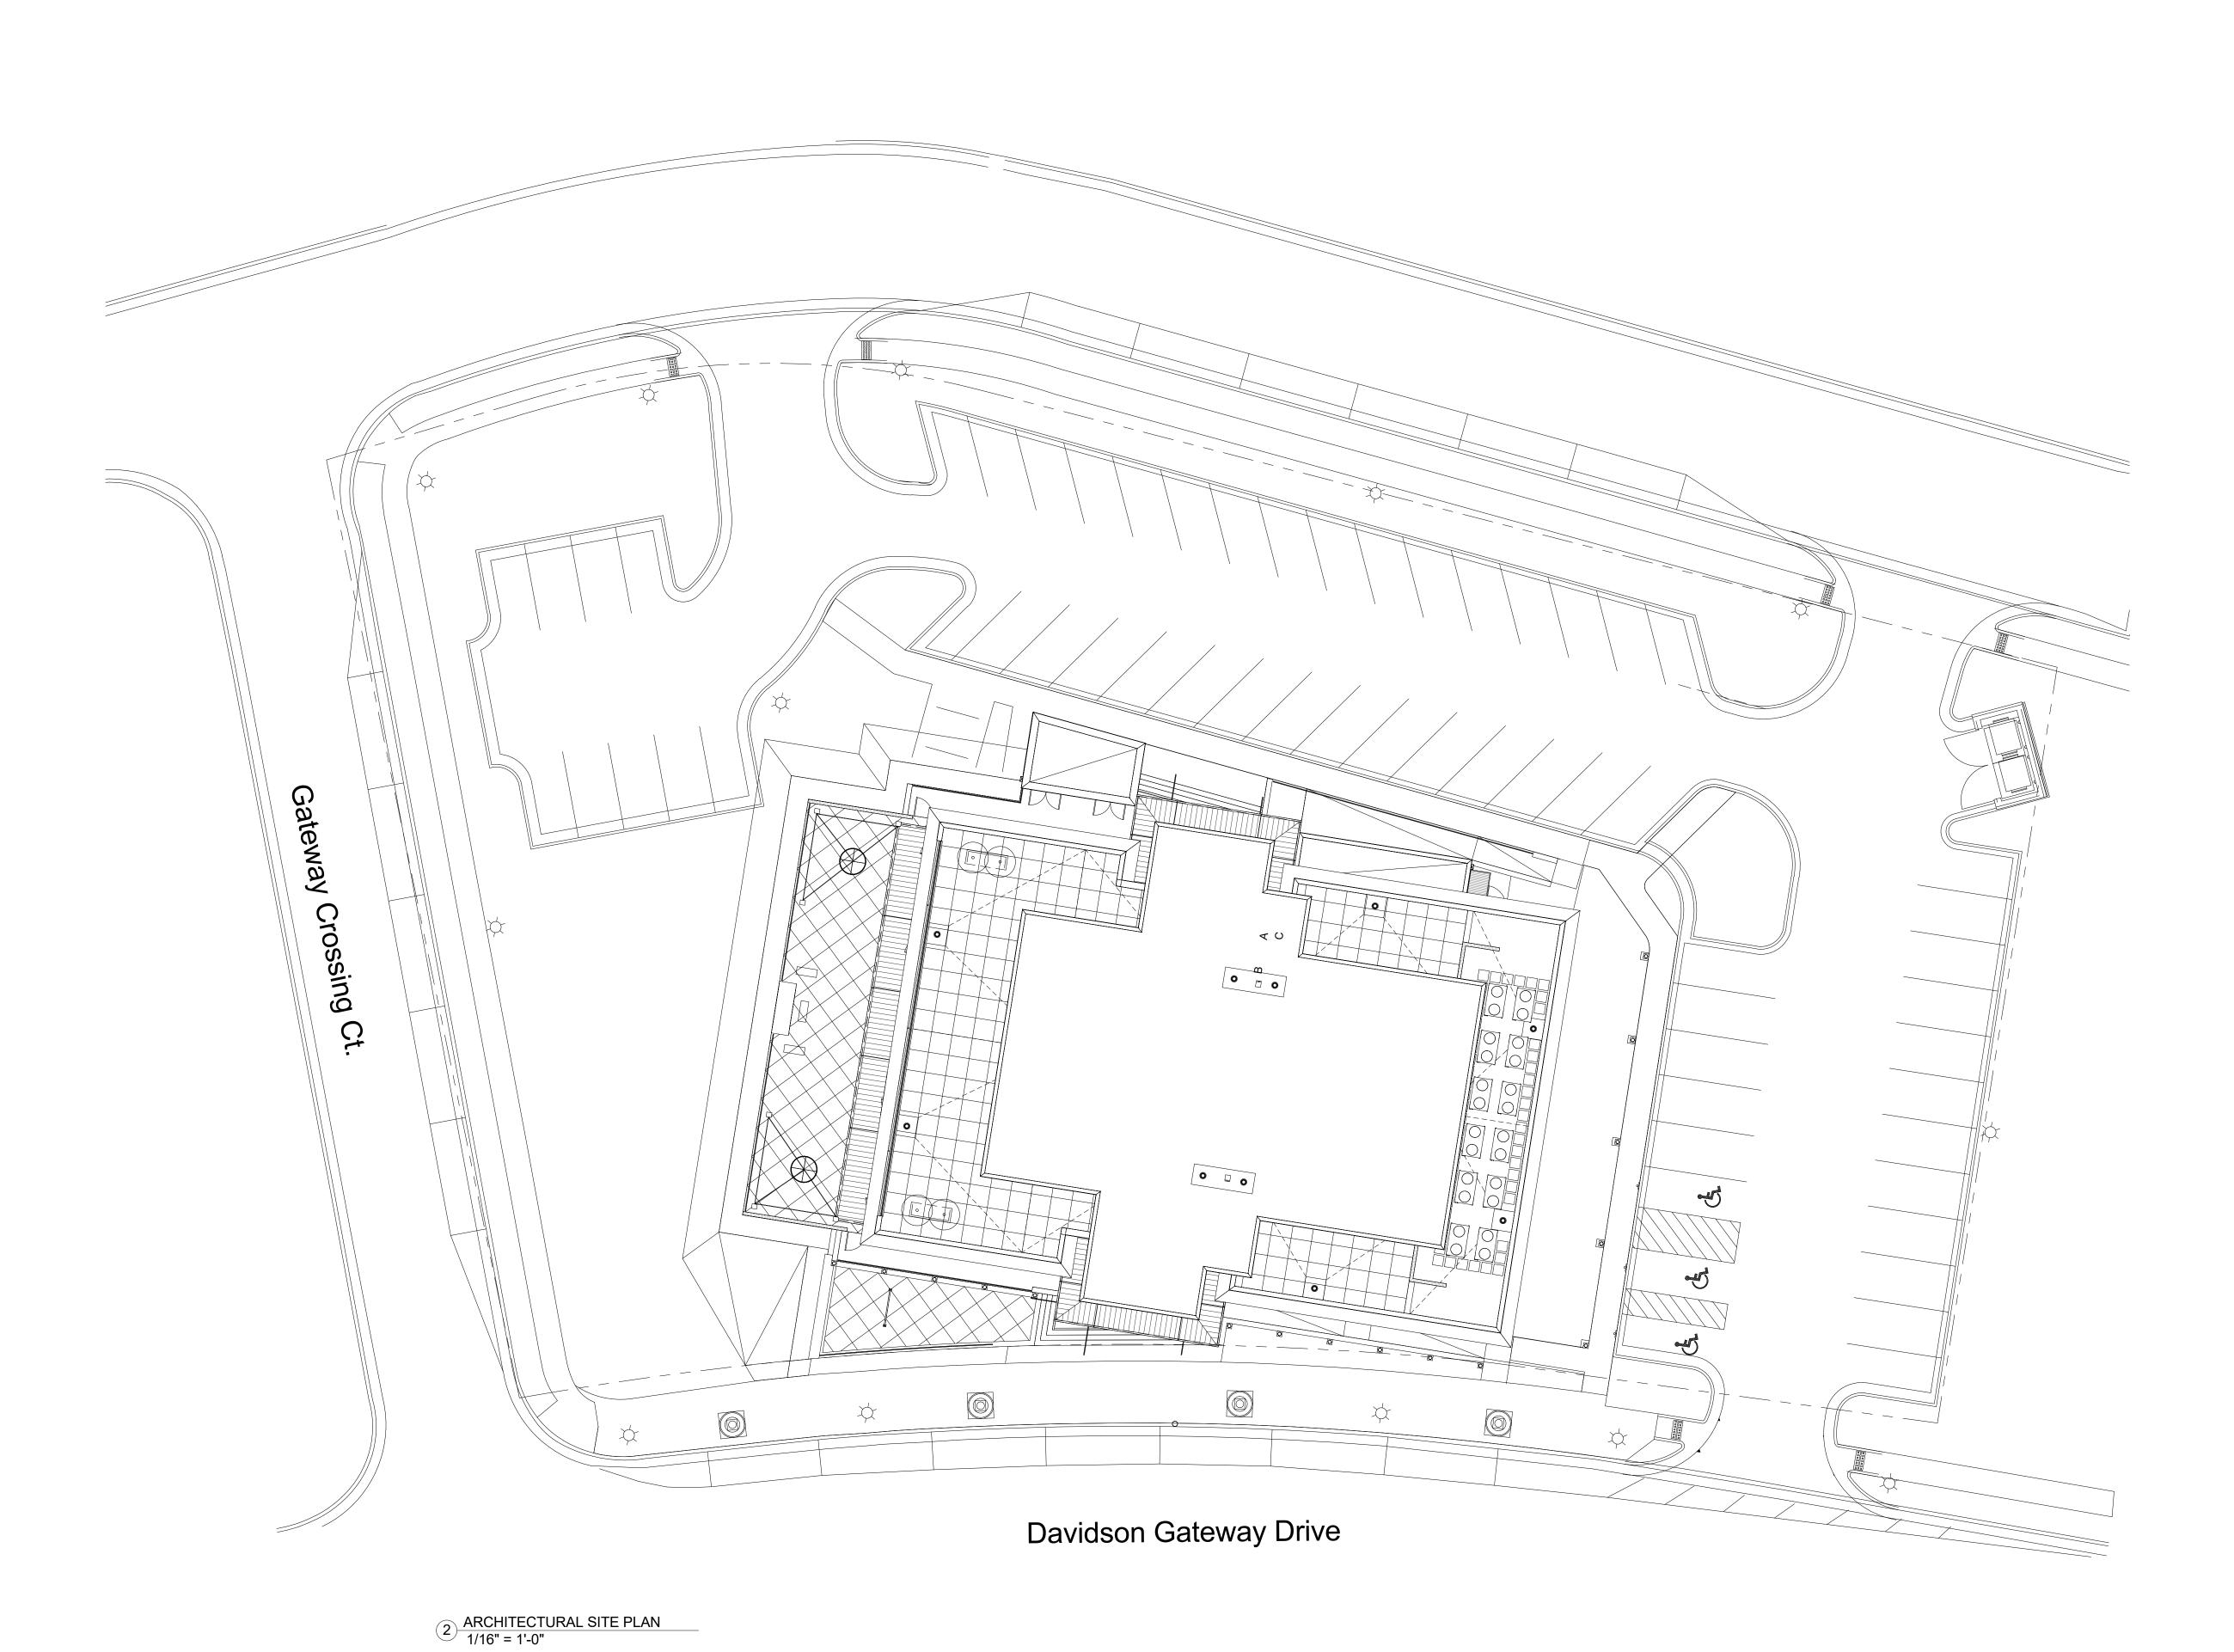

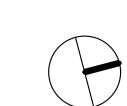

David Martini - Plank

ARCHITECT

PROJECT TEAM:

ARCHITECT OF RECORD

David Martini - Plank, AIA

NC Registration : 5453

143 Village View Drive - Suite 203

Mooresville, NC 28117

704-777-4447

dmartiniplank@gmail.com

Architecture
Interiors

Master Planning
Development

GENERAL CONTRACTOR
Kearey Builders
Ryan Kearey
2915 Charlotte Highway
Mooresville, NC 28117
980-444-6510



<u>PROJE</u>

DAVIDSON GATEWAY CENTER 635 DAVIDSON GATEWAY DRIVE DAVIDSON NC 28036

Sea

Issue Date:

08/12/19

ARCHITECTURAL SITE PLAN

C-102-00

2018 APPENDIX B BUILDING CODE SUMMARY FOR ALL COMMERCIAL PROJECTS

(EXCEPT 1 AND 2-FAMILY DWELLINGS AND TOWNHOUSES) (Reproduce the following data on the building plans sheet 1 or 2)

Owned By: Private Code Enforcement CONTACT: DESIGNER Architectural Civil	d Agent: David Martini-Plate Nick Lyssikatos at Jurisdiction: County		(704) 777 - 44	447 E-Mail dmartiniplank@gmail.c
Owned By: Private Code Enforcement CONTACT: DESIGNER Architectural Civil	te Nick Lyssikatos It Jurisdiction: County			
CONTACT: DESIGNER Architectural Civil	nt Jurisdiction: County	Mecklenburg		
CONTACT: DESIGNER Architectural Civil	TATE AND ADDRESS OF THE ADDRESS OF T			
DESIGNER Architectural Civil	FIRM			
DESIGNER Architectural Civil	FIRM			
Civil		NAME	LICENSE#	TELEPHONE # E-MAIL
	David Martini-Plank, Arch	David Martini-Plank		(704) 777-4447 dmartiniplank@gmail
Element I	Eastlake PLLC	Paul Carter	1317	(865) 816 4557 pcartern@yahoo.com
Electrical	Todd Carey and Assoc.	Todd Carey	09079	(704) 664 9824 toddcarey@toddcarey.
	Todd Carey and Assoc.	Todd Carey	09079	(704) 664 9824 toddcarey@toddcarey
	Todd Carey and Assoc.	Todd Carey	09079	(704) 664 9824 toddcarey@toddcare
	Todd Carey and Assoc.	Todd Carey	09079	(704) 664 9824 toddcarey@toddcare
	pe Todd Carey and Assoc.		09079	(704) 664 9824 toddcarey@toddcare
	Structures Inc	Jim Kunkle	14663	704 662 6844 jim@sturcturesinc.co
Retaining Walls > Other	S' High			- >
	nclude firms and individue	le ench ac truce m	recest pre engi	neered, interior designers, etc.)
(2		ac out a maco, p	errori Pro ang.	
2018 NC BUILD	ING CODE: New Buildin	ng		
2018 NC EXIST	ING BUILDING CODE:	N/A N/A	N/A	
	CTED: (date)	SOUTH THE PARTY OF		CY(S) (Ch. 3):
RENOVATI	E D: (date)	_ PROPOS	ED OCCUPA	NCY(S) (Ch. 3):
OCCUPANCY O	CATEGORY (Table 1604)	.5): Current: N/A	. 1	Proposed: <u>II</u>
				3,000
BASIC BUILDI	NG DATA			
Construction Ty	pe: II-A			
Sprinklers: Yes				
Standpipes: Clas	DOM CONTROL			
Primary Fire Dis		Flood P	lazard Area: N	No
Special Inspection	ons Required: Yes (Contac	procedures and re		1 IOT
Special Inspectio	additional	procedures and re	quirements.)	

ALLOWABLE AREA

Primary Occupancy Classification(s): Busniess Assembly - A-2 N/A N/A N/A N/A

2018 NC Administrative Code and Policies

4th Floor 3rd Floor

Accessory Oc	cupancy Classificat	ion(s): A-2 Kitche	n		
Incidental Use	es (Table 509): N	I/A	1.000		
Special Uses (Chapter 4 – List Co	de Sections): N/	A		
Special Provis	sions: (Chapter 5 -	List Code Section	s): N/A		
Mixed Occup	ancy: Yes Separat	ion: 1 Hr.	Exception:		
Aci	tl	nat the sum of the r llowable floor area acy A + Ac	atios of the actu for each use sh	all floor area of each tall not exceed 1. ccupancy B < 1	occupancy shall be such use divided by the
8	_	+	+	=	≤ 1.00
STORY NO.	DESCRIPTION AND USE	(A) BLDG AREA PER	(B) TABLE 506.2 ⁴	(C) AREA FOR FRONTAGE	(D) ALLOWABLE AREA PER
	1200	STORY (ACTUAL)	AREA	INCREASE ^{1,5}	STORY OR UNLIMITED ^{2,3}

1	Restaurant A-2	10373 SF	46,500	N/A	11,625 SF
2	Business B (tenant)	9931 SF	46,500	N/A	11,625 SF
3	Business B (tenant)	9934 SF	46,500	N/A	11,625 SF
4	Event Space A-2	9933 SF	46,500	N/A	11,625 SF
Fronta a. b. c.	age area increases from Sect Perimeter which fronts a p Total Building Perimeter Ratio (F/P) =	ublic way or or =		g 20 feet minimur	n width =(F)
d.	W = Minimum width of pu Percent of frontage increas)= (%	v.
e. ² Unlin	nited area applicable under c		CARL STREET, CARL	/(/0)

³ Maximum Building Area = total number of stories in the building x D (maximum3 stories) (506.2). ⁴ The maximum area of open parking garages must comply with Table 406.5.4. The maximum area of air traffic control towers must comply with Table 412.3.1. ⁵ Frontage increase is based on the unsprinklered area value in Table 506.2.

ALLOWABLE HEIGHT

	ALLOWABLE	SHOWN ON PLANS	CODE REFERENCE
Building Height in Feet (Table 504.3)	85 Feet	57'-6"	
Building Height in Stories (Table 504.4)	4	4	

FIRE PROTECTION REQUIREMENTS

BUILDING ELEMENT	FIRE	RATING		DETAIL#	DESIGN#	SHEET # FOR	SHEET #
	SEPARATION DISTANCE (FEET)	REQ'D	PROVIDED (W/* REDUCTION)	AND SHEET#	FOR RATED ASSEMBLY	RATED PENETRATION	FOR RATED JOINTS
Structural Frame, including columns, girders, trusses		1	1				
Bearing Walls		Î					
Exterior				0			
North							
East				e e			
West							
South		Ŭ					
Interior		ě Ú		ő			

2018 NC Administrative Code and Policies

Nonbearing Walls and Partitions						
Exterior walls		e de c				
North	> 30'-0"	0	0			
East	> 30'-0"	0	0			
West	> 30'-0"	0	0			
South	> 30'-0"	0	0			
Interior walls and partition	ıs	0				
Floor Construction Including supporting bean and joists	ns	1	1			
Floor Ceiling Assembly						
Columns Supporting Floors	k	1	1			
Roof Construction, includin supporting beams and joists		1	1			
Roof Ceiling Assembly						
Columns Supporting Roof		111				
Shaft Enclosures - Exit	7	2	2	UL937		
Shaft Enclosures - Other		2	2	UL937		
Corridor Separation						
Occupancy/Fire Barrier Sep	aration	1	1		1	
Party/Fire Wall Separation		_				
Smoke Barrier Separation			A			
Smoke Partition		_				
Tenant/Dwelling Unit/ Sleeping Unit Separation						
Incidental Use Separation						

* Indicate section number permitting reduction

PROTECTION (TABLE 705.8)	(%)	(%)

LIFE SAFETY SYSTEM REQUIREMENTS

Emergency Lighting:	Yes
Exit Signs:	Yes
Fire Alarm:	Yes
Smoke Detection Systems:	Yes
Carbon Monoxide Detection:	Yes

LIFE SAFETY PLAN REQUIREMENTS

	Dir D Sitt Bill I Elli I I I I I I I I I I I I I I I I I I
Life Safety Plan Sheet #: _	_LS-100.00
Fire and/or smoke rate	ted wall locations (Chapter 7)
Assumed and real pro	operty line locations (if not on the site plan)

2018 NC Administrative Code and Policies

	Exterior wall opening area with respect to distance to assumed property lines (705.8)
\boxtimes	Occupancy Use for each area as it relates to occupant load calculation (Table 1004.1.2)
	Occupant loads for each area
\boxtimes	Exit access travel distances (1017)
\boxtimes	Common path of travel distances (Tables 1006.2.1 & 1006.3.2(1))
	Dead end lengths (1020.4)
\boxtimes	Clear exit widths for each exit door
M	Mariana alastada a a a a la da a a a a la da a a a la da a a a

Maximum calculated occupant load capacity each exit door can accommodate based on egress width (1005.3) Actual occupant load for each exit door A separate schematic plan indicating where fire rated floor/ceiling and/or roof structure is provided for purposes of occupancy separation

Location of doors with panic hardware (1010.1.10) Location of doors with delayed egress locks and the amount of delay (1010.1.9.7) Location of doors with electromagnetic egress locks (1010.1.9.9)

Location of doors equipped with hold-open devices Location of emergency escape windows (1030) ☐ The square footage of each fire area (202)

☐ The square footage of each smoke compartment for Occupancy Classification I-2 (407.5) Note any code exceptions or table notes that may have been utilized regarding the items above

ACCESSIBLE DWELLING UNITS

TOTAL Units	ACCESSIBLE UNITS REQUIRED	ACCESSIBLE UNITS PROVIDED	Type A Units Required	TYPE A UNITS PROVIDED	TYPE B Units Required	TYPE B UNITS PROVIDED	TOTAL ACCESSIBLE UNITS PROVIDED
----------------	---------------------------------	---------------------------------	-----------------------------	-----------------------	-----------------------------	-----------------------------	---------------------------------------

ACCESSIBLE PARKING (SECTION 1106)

LOT OR PARKING AREA	TOTAL # OF PA	RKING SPACES	# OF ACC	TOTAL#		
	REQUIRED	PROVIDED	REGULAR WITH	VAN SPACE	ACCESSIBLE PROVIDED	
		5' ACCESS AISLE	132" ACCESS AISLE	8' ACCESS AISLE		
				33334734111		
TOTAL			İ			-

PLUMBING FIXTURE REQUIREMENTS (TABLE 2902.1)

USE	V	VATERCLOSI	ETS	URINALS		LAVATORIE	S	SHOWERS	DRINKING	FOUNTAINS
	MALE	FEMALE	UNISEX		MALE	FEMALE	UNISEX	/TUBS	REGULAR	ACCESSIBLE
Bus.	4	6		2	4	4				
A-2	3	6		4	5	5				
REQ'D	9	9			3	3				

SPECIAL APPROVALS

Special approval: (Local Jurisdiction, Department of Insurance, OSC, DPI, DHHS, etc., describe below)

2018 NC Administrative Code and Policies

ENERGY SUMMARY

ENERGY REQUIREMENTS: The following data shall be considered minimum and any special attribute required to meet the energy code shall also be provided. Each Designer shall furnish the required portions of the project information for the plan data sheet. If performance method, state the annual energy cost for the standard reference design vs annual energy cost for the proposed design.

Existing building envelope complies with code: Select one

Exempt Building: Select one Provide code or statutory reference: Climate Zone: Select one

(If "Other" specify source here)_

THERMAL ENVELOPE (Prescriptive method only)

Method of Compliance: Select one

Roof/ceiling Assembly (each assembly) Description of assembly: U-Value of total assembly: R-Value of insulation: Skylights in each assembly: U-Value of skylight:

Exterior Walls (each assembly) Description of assembly: U-Value of total assembly: R-Value of insulation: Openings (windows or doors with glazing)

total square footage of skylights in each assembly:

U-Value of assembly: Solar heat gain coefficient: projection factor: Door R-Values: Walls below grade (each assembly)

U-Value of total assembly: R-Value of insulation: Floors over unconditioned space (each assembly) Description of assembly: U-Value of total assembly: R-Value of insulation:

Floors slab on grade Description of assembly: U-Value of total assembly: R-Value of insulation: Horizontal/vertical requirement: slab heated:

Description of assembly:

2018 NC Administrative Code and Policies

2018 APPENDIX B BUILDING CODE SUMMARY FOR ALL COMMERCIAL PROJECTS

STRUCTURAL DESIGN (PROVIDE ON THE STRUCTURAL SHEETS IF APPLICABLE)

DESIGN LOADS: $\label{eq:monotone} \textbf{Importance Factors:} \qquad \text{Wind} \qquad (I_W) \quad \underline{Select \ one}$ Snow (I_S) Select one Seismic (I_E) Select one Live Loads: **Ground Snow Load:** ____ mph (ASCE-7) Wind Load: Basic Wind Speed Exposure Category Select one SEISMIC DESIGN CATEGORY: Select one Provide the following Seismic Design Parameters: Occupancy Category (Table 1604.5) Select one

Spectral Response Acceleration S_S______%g Site Classification (ASCE 7) Select one Data Source: Select one Basic structural system Select one Analysis Procedure: Select one Architectural, Mechanical, Components anchored? Select one

2018 NC Administrative Code and Policies

LATERAL DESIGN CONTROL: Select one SOIL BEARING CAPACITIES: Select one _____ psf
Pile size, type, and capacity ____

2018 APPENDIX B BUILDING CODE SUMMARY FOR ALL COMMERCIAL PROJECTS

MECHANICAL DESIGN (PROVIDE ON THE MECHANICAL SHEETS IF APPLICABLE)

MECHANICAL SUMMARY

MECHANICAL SYSTEMS, SERVICE SYSTEMS AND EQUIPMENT

Thermal Zone winter dry bulb: summer dry bulb:_____ Interior design conditions winter dry bulb: ___ summer dry bulb:____ relative humidity: ___ Building heating load: Building cooling load: Mechanical Spacing Conditioning System Unitary description of unit:

heating efficiency: cooling efficiency: size category of unit: Size category. If oversized, state reason.: Chiller Size category. If oversized, state reason.:

List equipment efficiencies:

2018 APPENDIX B BUILDING CODE SUMMARY FOR ALL COMMERCIAL PROJECTS ELECTRICAL DESIGN

(PROVIDE ON THE ELECTRICAL SHEETS IF APPLICABLE) ELECTRICAL SUMMARY

ELECTRICAL SYSTEM AND EQUIPMENT

Method of Compliance: Select one Lighting schedule (each fixture type) lamp type required in fixture number of lamps in fixture ballast type used in the fixture

number of ballasts in fixture total wattage per fixture total interior wattage specified vs. allowed (whole building or space by space)

total exterior wattage specified vs. allowed

C406.6 Dedicated Outdoor Air System

Additional Efficiency Package Options (When using the 2018 NCECC; not required for ASHRAE 90.1) C406.2 More Efficient HVAC Equipment Performance C406.3 Reduced Lighting Power Density
C406.4 Enhanced Digital Lighting Controls C406.5 On-Site Renewable Energy

C406.7 Reduced Energy Use in Service Water Heating

David Martini - Plank ARCHITECT

> PROJECT TEAM: ARCHITECT OF RECORD David Martini - Plank, AIA NC Registration: 5453 143 Village View Drive - Suite 203 Mooresville, NC 28117 704-777-4447 dmartiniplank@gmail.com Architecture Interiors Master Planning Development

GENERAL CONTRACTOR Kearey Builders Ryan Kearey 2915 Charlotte Highway Mooresville, NC 28117 980-444-6510



<u>PROJECT</u>

DAVIDSON GATEWAY CENTER 635 DAVIDSON GATEWAY DRIVE **DAVIDSON NC 28036**

2018 NC Administrative Code and Policies

Issue Date:


08/12/19


APPENDIX B

LS-100-00

SHEET:

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THIRD FLOOR OCCUPANCY PLAN

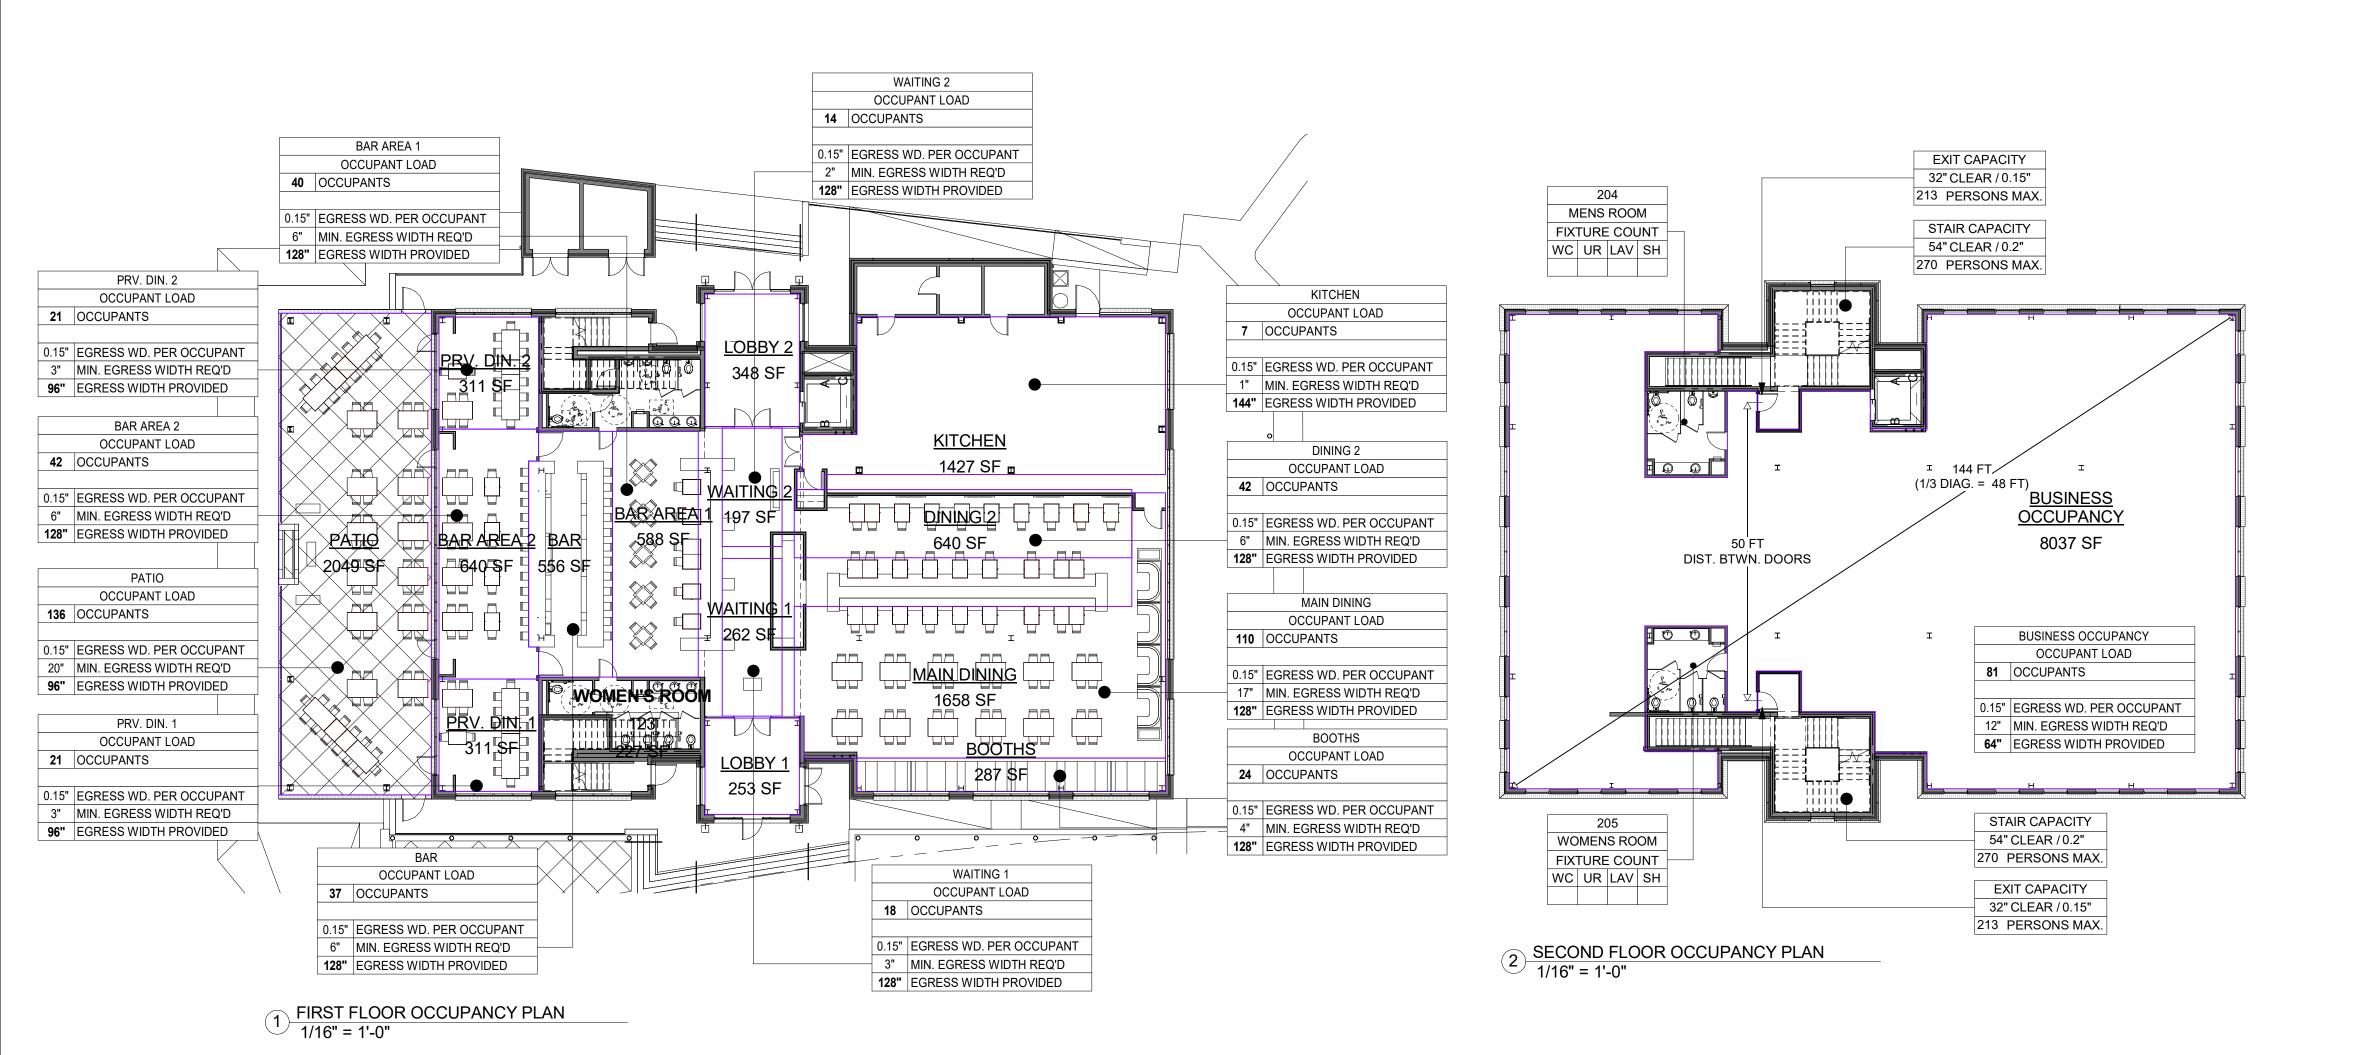1/16" = 1'-0"

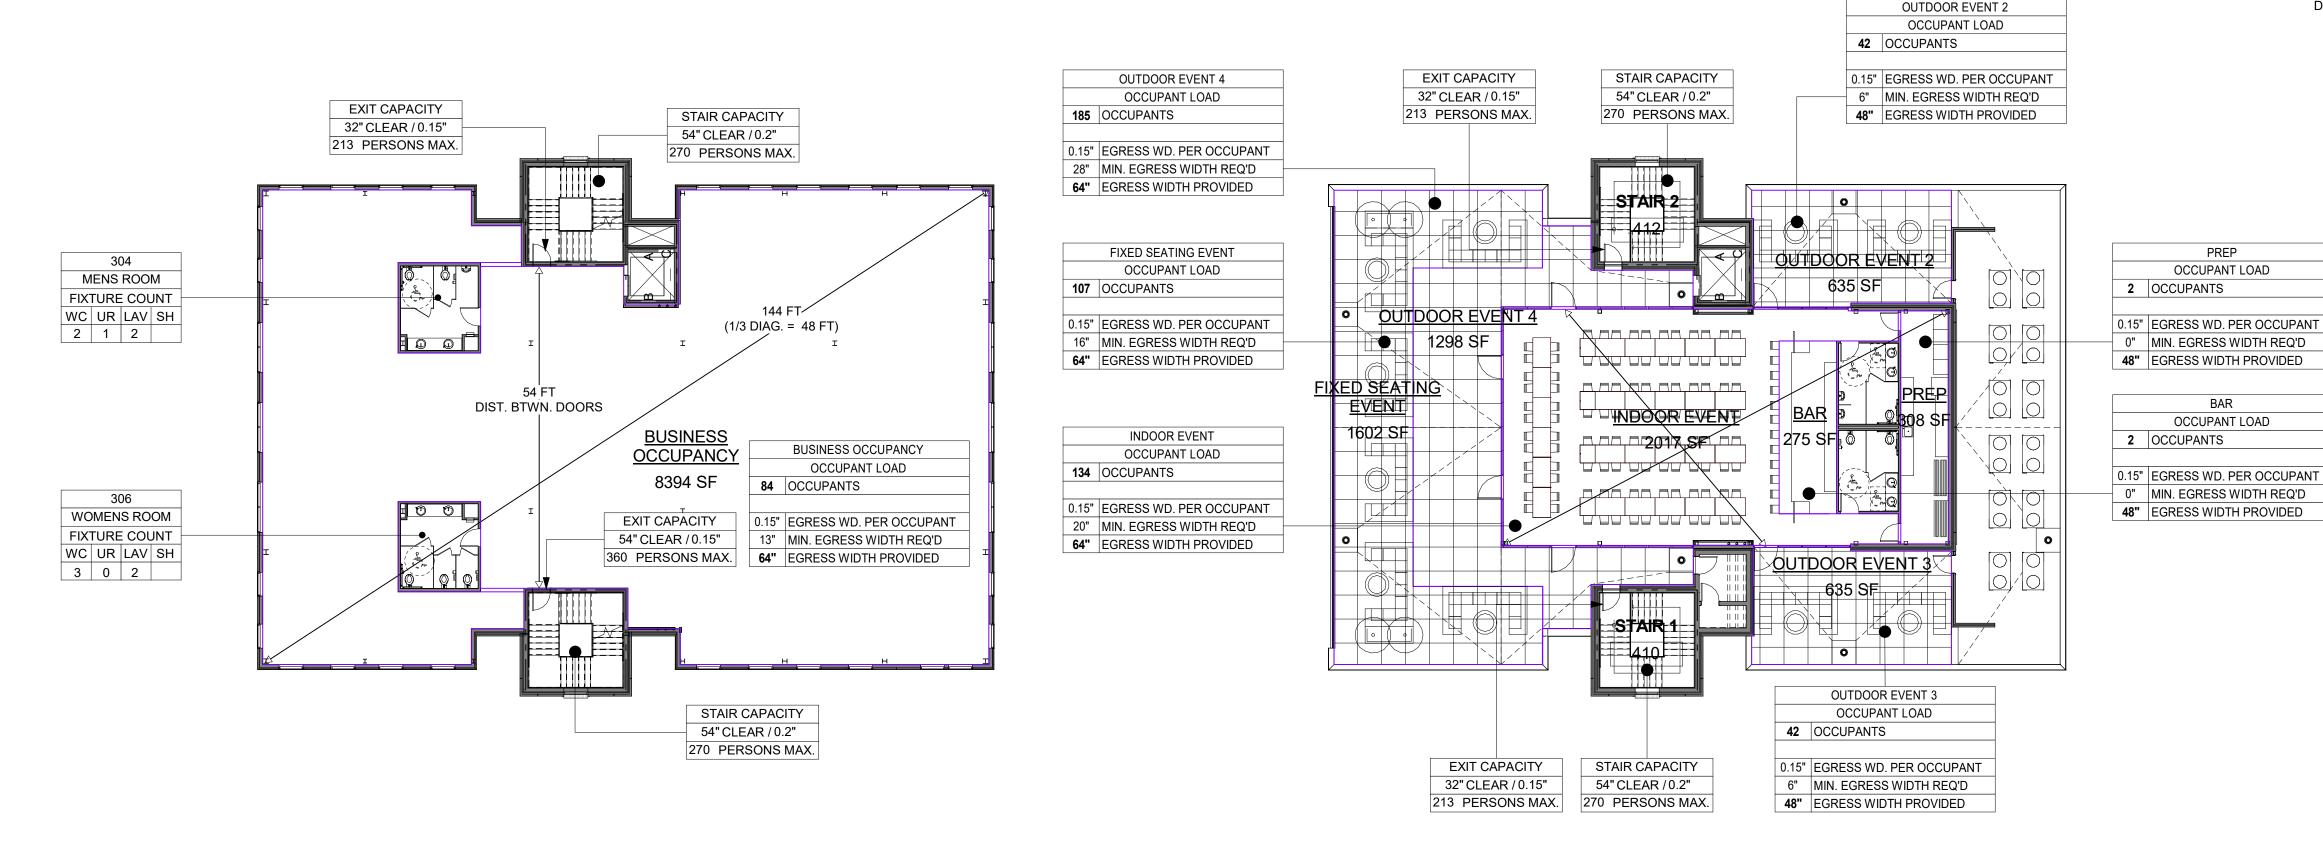4 FOURTH FLOOR OCCUPANCY PLAN
1/16" = 1'-0"

OCCUPANCY CALCULATIONS

FIRST FLOOR

ASSEMBLY A-2 197 S.F. / 15 = 14 PERSONS **WAITING 2** 588 S.F. / 15 = 40 PERSONS BAR AREA 1 311 S.F. / 15 = 21 PERSONS PRV. DIN 2 BAR AREA 2 640 S.F. / 15 = 42 PERSONS 2049 S.F. / 15 = 136 PERSONS PATIO 311 S.F. / 15 = 21 PERSONS PRV DIN 1 556 S.F. / 15 = 37 PERSONS **WAITING 1** 262 S.F. / 15 = 8 PERSONS BOOTHS FIXED SEATING 24 PERSONS MAIN DINING 1658 S.F. / 15 = 110 PERSONS 640 S.F. / 15 = 42 PERSONS DINING 2 KITCHEN 1427 S.F. / 200 = 7 PERSONS

TOTAL FIRST FLOOR = 502 PERSONS

SECOND FLOOR

BUSINESS WARM SHELL TENANT SPACE 8067 S.F / 100 = 81 PERSONS

THIRD FLOOR

WARM SHELL TANANT SPACE 8408 S.F / 100 = 84 PERSONS

FOURTH FLOOR

ASSEMBLY A-2 FIXED SEATING EVENT 1602 S.F. / 15 = 107 PERSONS 636 S.F. / 15 = 42 PERSONS OUTDOOR EVENT 2 637 S.F. / 15 = 42 PERSONS **OUTDOOR EVENT 3 OUTDOOR EVENT 4** 1298 S.F. / 7 = 185 PERSONS 2017 S.F. / 15 = 134 PERSONS INDOOR EVENT 275 S.F. / 200 = 2 PERSONS PREP 308 S.F. / 200 = 2 PERSONS

TOTAL FOURTH FLOOR = 514 PERSONS

TOTAL OCCUPANT LOAD = 1,181 PERSONS

TRAVELS DISTANCES

MAXIMUM TRAVEL DISTANCE BETWEEN EXITS


FIRST FLOOR = SECOND FLOOR = THIRD FLOOR = FOURTH FLOOR =

OCCUPANT LOAD

OCCUPANT LOAD

CLEAR EXIT PATH MINIMUM 42" ALL ISLES

- 1. ALL EXIT DOORS SHALL BE EQUIPPED WITH CODE APPROVED PUSH BAR TYPE QUICK RELEASE PANIC HARDWARE ADA COMPLIANT.
- 2. ALL INTERIOR DOORS SHALL BE EQUIPPED WITH CODE APPROVED ADA LEVER TYPE DOOR HANDLES AND PUSH PLATES.
- 3. DEAD END DISTANCE 20'-0" MAX.
- 4. 2 EXITS MUST BE VISIBLE FROM ANY POINT.
- 5. ALL RESTROOMS ENTRY DOORS SHALL HAVE AUTOMATIC DOOR CLOSERS.

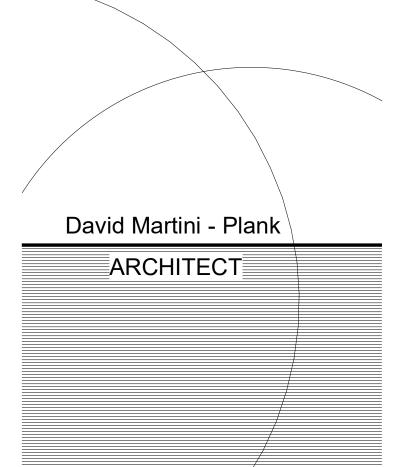

PROJECT TEAM: **ARCHITECT OF RECORD** David Martini - Plank, AIA NC Registration: 5453 143 Village View Drive - Suite 203 Mooresville, NC 28117 704-777-4447 dmartiniplank@gmail.com Architecture Interiors Master Planning Development

GENERAL CONTRACTOR Kearey Builders Ryan Kearey 2915 Charlotte Highway Mooresville, NC 28117 980-444-6510




PROJECT

DAVIDSON GATEWAY CENTER 635 DAVIDSON GATEWAY DRIVE DAVIDSON NC 28036

08/12/19 Issue Date:

OCCUPANCY PLANS

OC-100-00

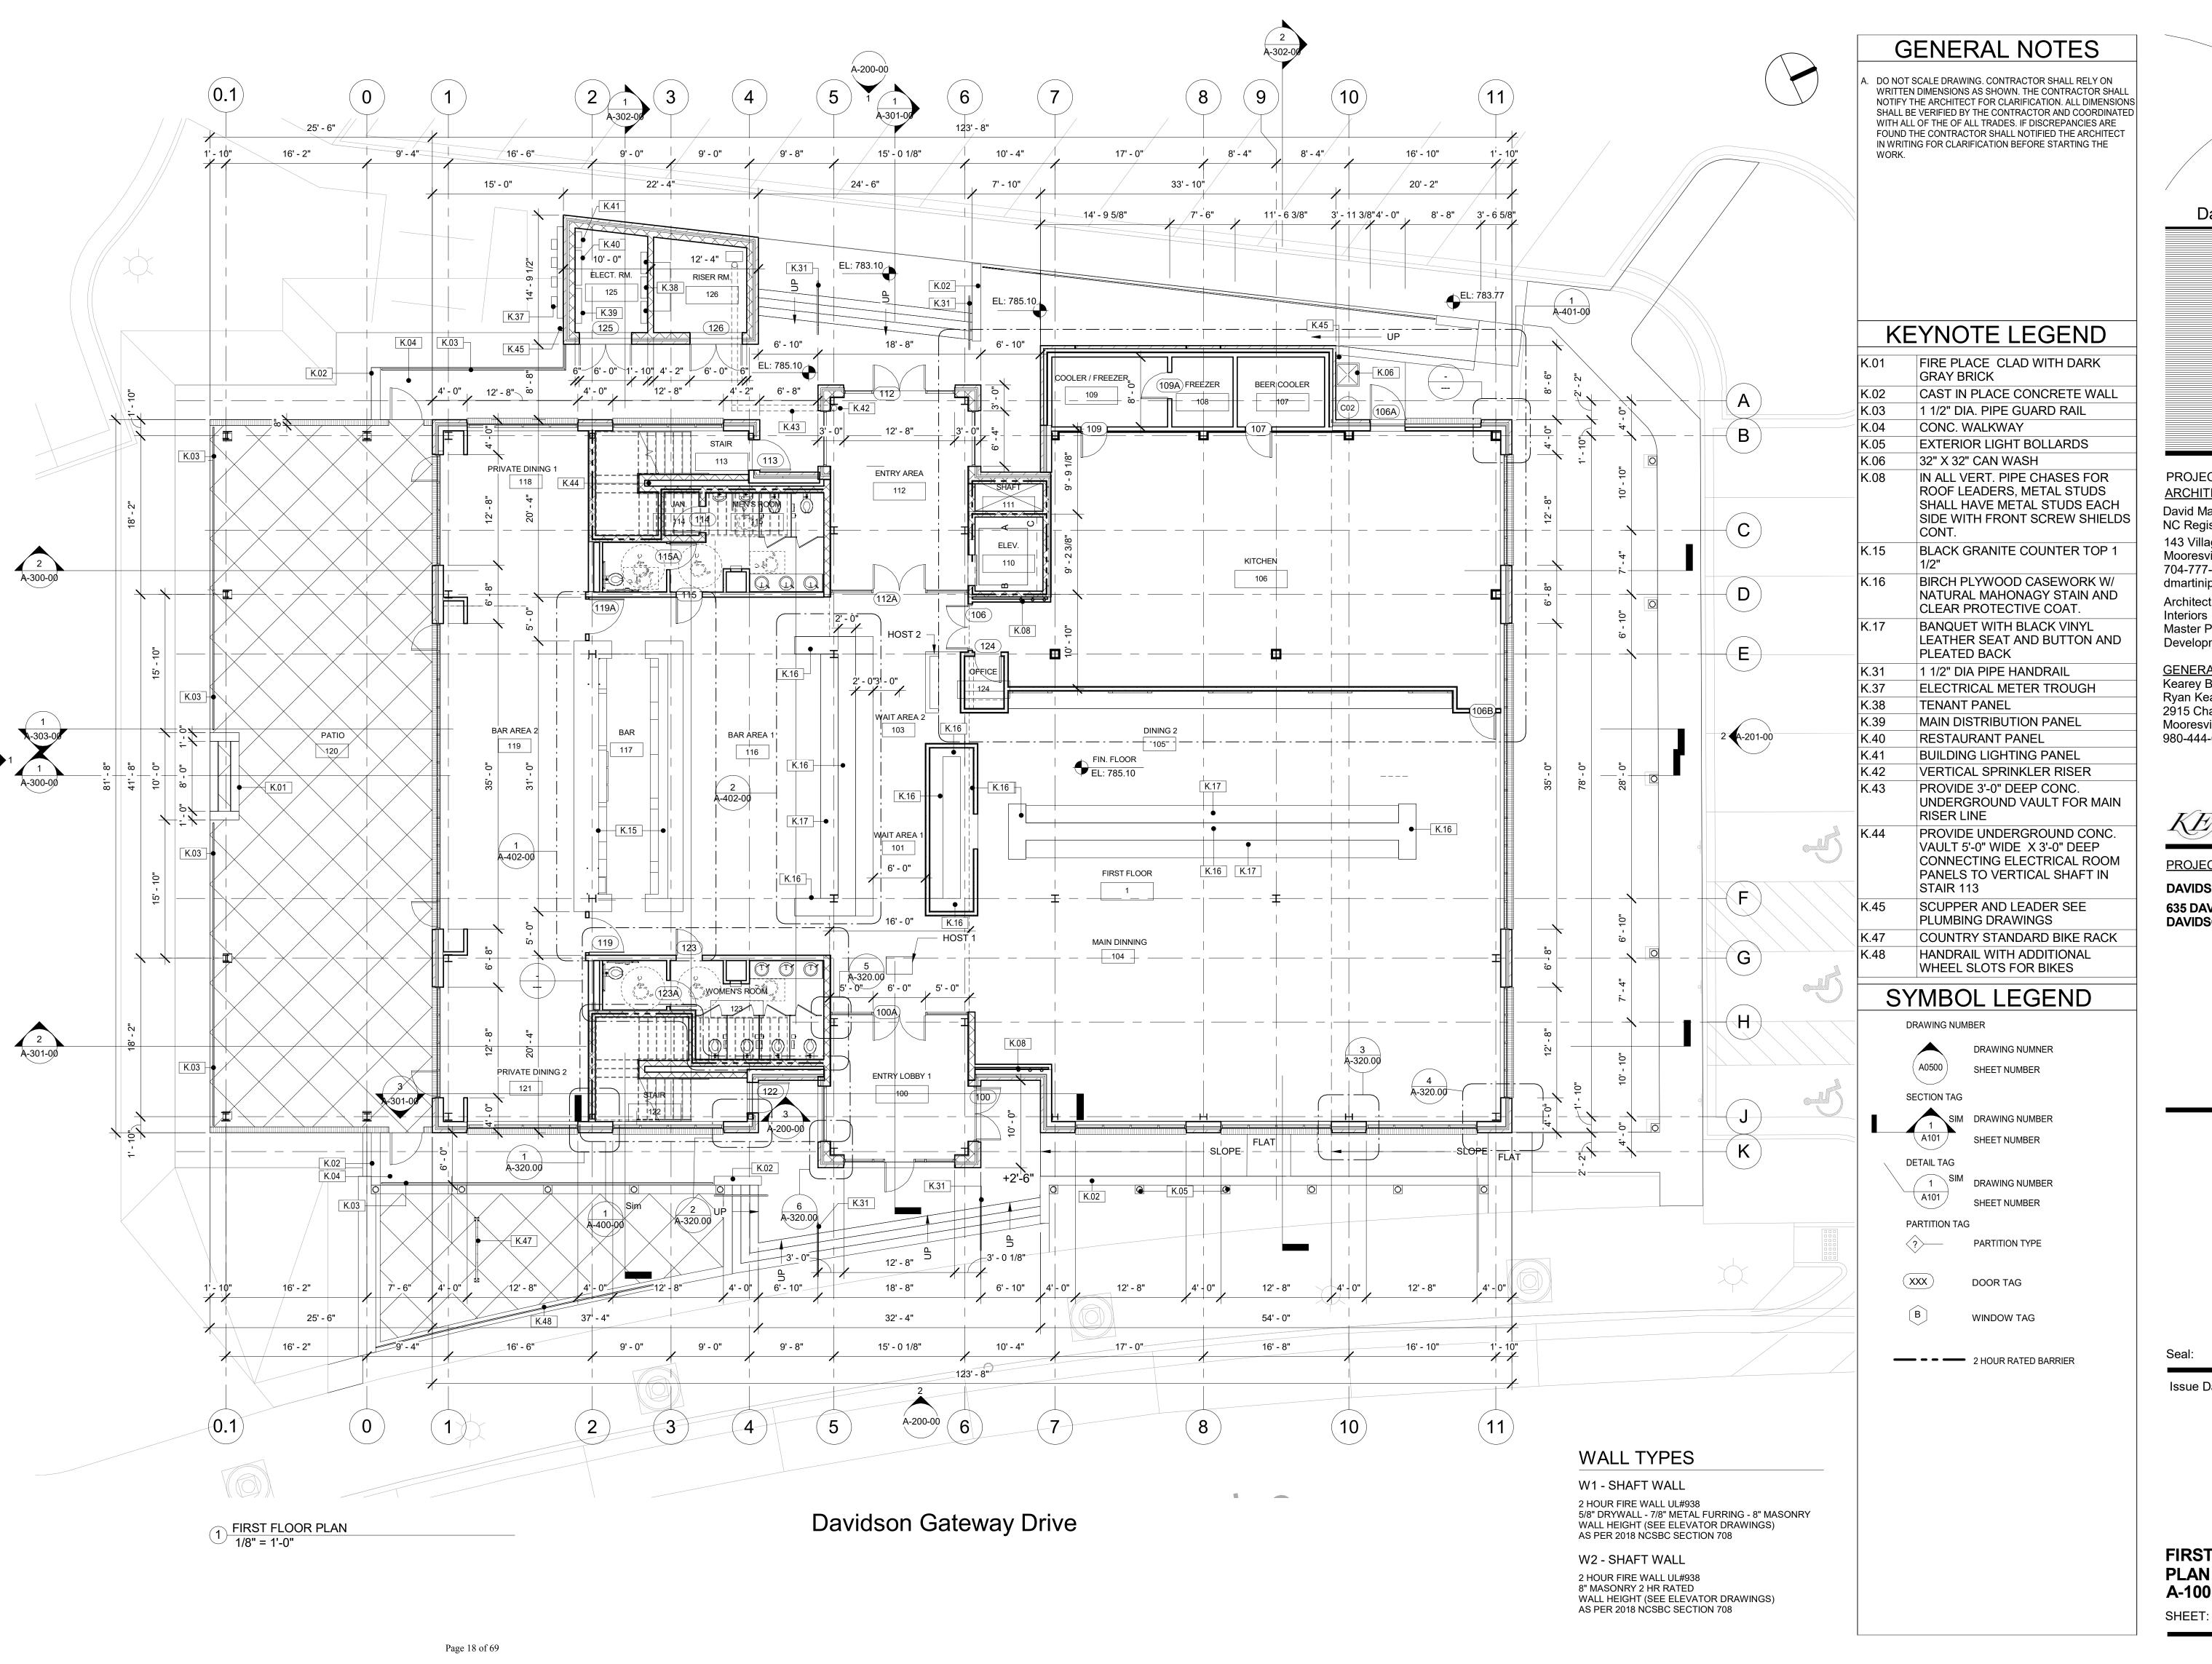

David Martini - Plank

ARCHITECT

PROJECT TEAM: **ARCHITECT OF RECORD** David Martini - Plank, AIA NC Registration: 5453 143 Village View Drive - Suite 203 Mooresville, NC 28117 704-777-4447 dmartiniplank@gmail.com Architecture Interiors Master Planning Development

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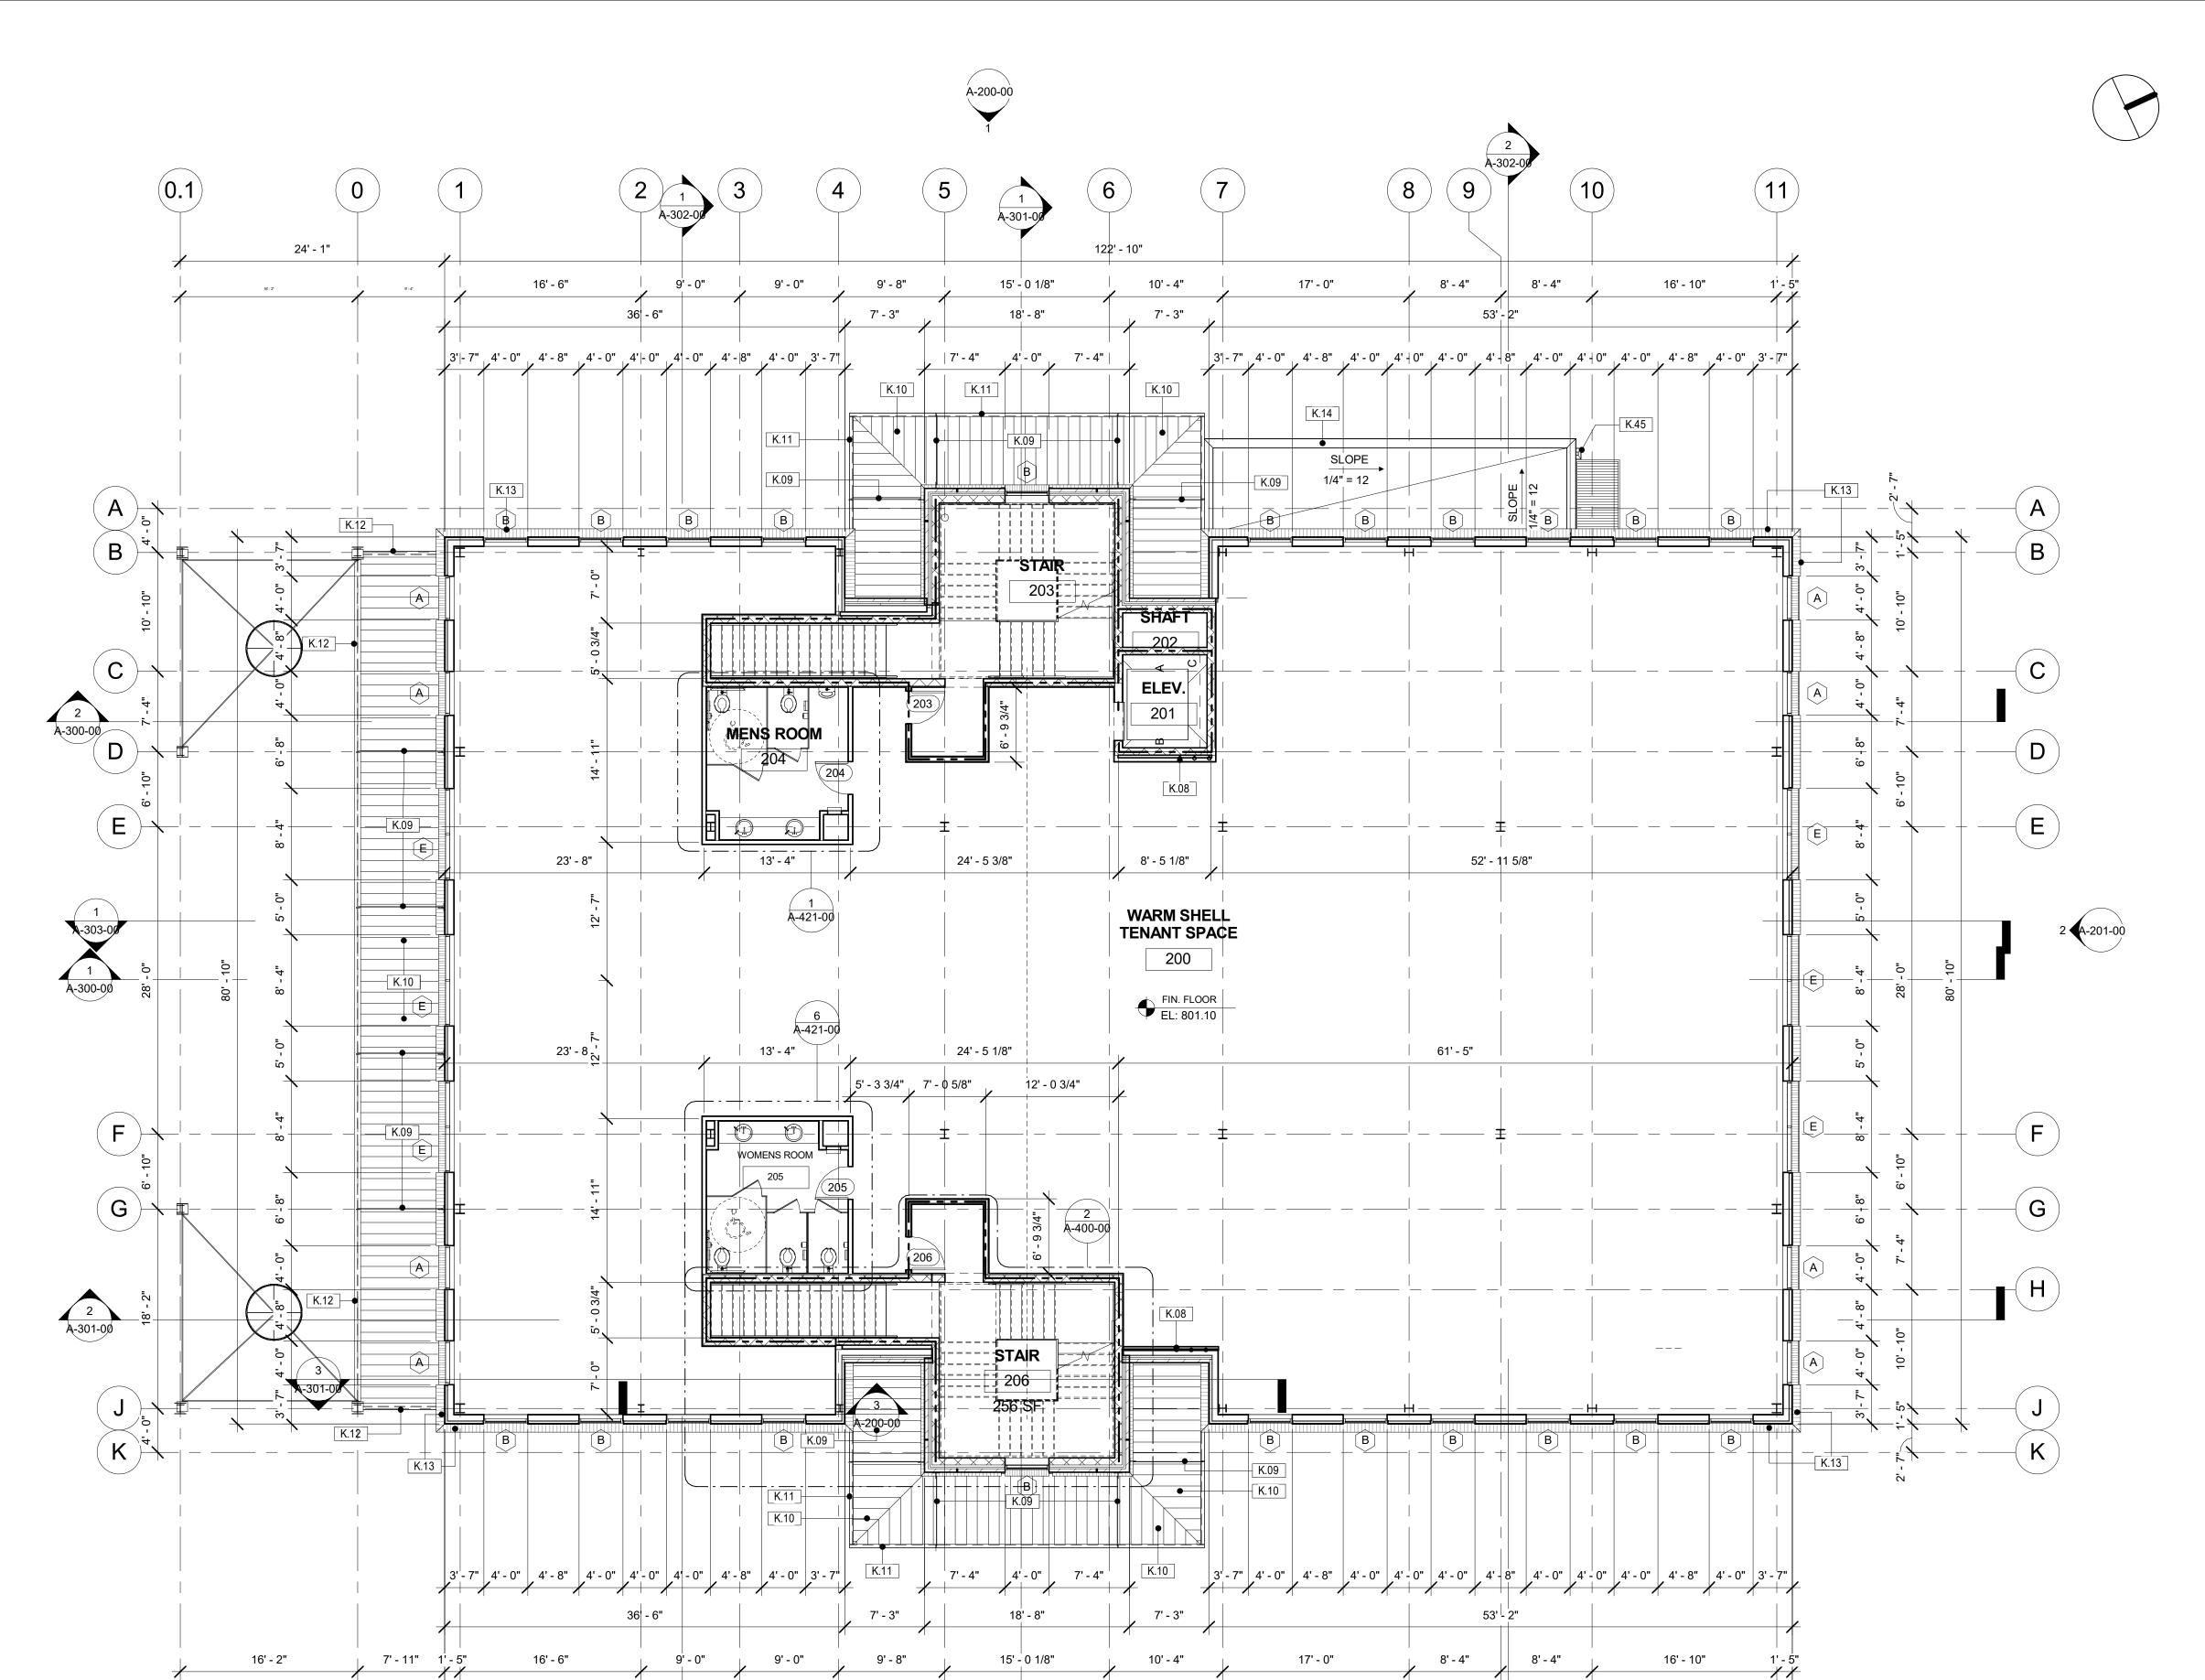
<u>PROJECT</u>

DAVIDSON GATEWAY CENTER 635 DAVIDSON GATEWAY DRIVE DAVIDSON NC 28036

Issue Date:

08/12/19

FIRST FLOOR CONSTRUCTION **PLAN** A-100-00



122' - 10"

6

8

9

5

WALL TYPES

(11)

W1 - SHAFT WALL

2 HOUR FIRE WALL UL#938

5/8" DRYWALL - 7/8" METAL FURRING - 8" MASONRY
WALL HEIGHT (SEE ELEVATOR DRAWINGS)
AS PER 2018 NCSBC SECTION 708

W2 - SHAFT WALL

2 HOUR FIRE WALL UL#938
8" MASONRY 2 HR RATED
WALL HEIGHT (SEE ELEVATOR DRAWINGS)
AS PER 2018 NCSBC SECTION 708

GENERAL NOTES

A. DO NOT SCALE DRAWING. CONTRACTOR SHALL RELY ON WRITTEN DIMENSIONS AS SHOWN. THE CONTRACTOR SHALL NOTIFY THE ARCHITECT FOR CLARIFICATION. ALL DIMENSIONS SHALL BE VERIFIED BY THE CONTRACTOR AND COORDINATED WITH ALL OF THE OF ALL TRADES. IF DISCREPANCIES ARE FOUND THE CONTRACTOR SHALL NOTIFIED THE ARCHITECT IN WRITING FOR CLARIFICATION BEFORE STARTING THE WORK.

KEYNOTE LEGEND

IN ALL VERT. PIPE CHASES FOR ROOF LEADERS, METAL STUDS SHALL HAVE METAL STUDS EACH SIDE WITH FRONT SCREW SHIELDS CONT.

ANCHOR FLANGES AND SOLID STEEL ROD

FACTORY KYNAR ANTI-FADE PAINT COLOR WITH PROTECTIVE FINISH

11 CANOPY STEEL CHANNEL W/
KYNAR ANTI-FADE PAINT COLOR


PRE-FAB METAL CANOPY W/

WITH PROTECTIVE FINISH. SEE STRUCT. DWGS. SEE ARCHITECTURAL DWGS FOR VERT. WEB FINS AND DETAIL DIMENSIONS. SUBMIT SHOP DWGS FOR ARCHITECTURAL AND STRUCTURAL APPROVAL.

K.12 STEEL BEAM SEE STRUCT. DWGS.
K.13 STEPPED BRICK CORBEL
K.14 OUTLINE OF FREEZER / COOLER

K.45 SCUPPER AND LEADER SEE PLUMBING DRAWINGS

ROOF BELOW

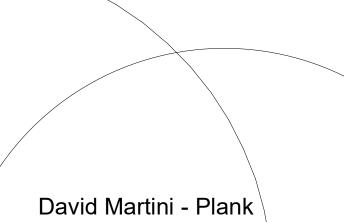

ARCHITECT

PROJECT TEAM:

PROJECT TEAM:

ARCHITECT OF RECORD

David Martini - Plank, AIA

NC Registration: 5453

143 Village View Drive - Suite 203

Mooresville, NC 28117

704-777-4447

dmartiniplank@gmail.com

Architecture
Interiors

Development

GENERAL CONTRACTOR
Kearey Builders
Ryan Kearey
2915 Charlotte Highway
Mooresville, NC 28117

Master Planning



<u>PROJECT</u>

980-444-6510

DAVIDSON GATEWAY CENTER 635 DAVIDSON GATEWAY DRIVE DAVIDSON NC 28036

SYMBOL LEGEND

A0500

DRAWING NUMNER
SHEET NUMBER

SECTION TAG

SIM DRAWING NUMBER

SHEET NUMBER

DRAWING NUMBER

DETAIL TAG

1
SIM
DRAWING NUMBER
SHEET NUMBER

PARTITION TAG

PARTITION TYPE

DOOR TAG

B

WINDOW TAG

2 HOUR RATED BARRIER

Issue Date:

08/12/19

SECOND FLOOR PLAN

A-101-00

SHEET:

 $\left(egin{array}{c} oldsymbol{2} \end{array}
ight)$

1 SECOND FLOOR CONSTRUCTION PLAN 1/8" = 1'-0"

(3

24' - 1"

(0.1)



9' - 0"

MENS ROOM (BO4)

304

13' - 4"

13' - 4"

WOMENS ROOM

9' - 0"

₩ A-200-0Ø

7' - 3"

9' - 8"

16' - 6"

23' - 8"

23' - 8" - 5

3'-7" | 4'-0" | 4'-8" | 4'-0" | 4'-0" | 4|-0" | 4'-8" | 4'-0" | 3'-7"

16' - 6"

1 THIRD FLOOR CONSTRUCTION PLAN
1/8" = 1'-0"

36' - 6"

3' - 7" - 4' - 0" - 4' - 8" - 4' - 0" - 4' - 0" - 4' - 0" - 4' - 0" - 4' - 8" - 4' - 0" - 3' - 7"

9' - 8"

7' - 3"

7' - 3"

(6)

10' - 4"

7' - 3"

302

ELEY.

301

K.08

WARM SHELL

TENANT SPACE

300

FIN. FLOOR EL: 815.10

7' - 3"

10' - 4"

122' - 10"

A-400-00

307

307

+ · — · — · [B} — · — · | |

18' - 8"

15' - 0 1/8"

A-200-00

17' - 0"

85' - 10 1/8"

85' - 10 1/8"

(A)

8' - 4"

53' - 2"

3'-7" 4'-0" 4'-0" 4'-0" 4'-0" 4'-0" 4'-0" 3'-7"

9

8' - 4"

8' - 4"

16' - 10"

(11)

3'-7", 4'-0", 4'-8", 4'-0", 4'-0", 4'-0", 4'-0", 4'-0", 4'-0", 4'-0", 4'-0", 4'-0", 4'-0", 3'-

8' - 4"

| (A) |

15' - 0 1/8"

18' - 8"

18' - 8"

STAIR


303



2 A-201-00

(11`

16' - 10"

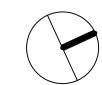

GENERAL NOTES

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David Martini - Plank

ARCHITECT

KEYNOTE LEGEND

K.08 IN ALL VERT. PIPE CHASES FOR ROOF LEADERS, METAL STUDS SHALL HAVE METAL STUDS EACH SIDE WITH FRONT SCREW SHIELDS CONT.



Master Planning Development **GENERAL CONTRACTOR**

Kearey Builders Ryan Kearey 2915 Charlotte Highway Mooresville, NC 28117 980-444-6510




<u>PROJECT</u>

DAVIDSON GATEWAY CENTER 635 DAVIDSON GATEWAY DRIVE **DAVIDSON NC 28036**

SYMBOL LEGEND

A0500

DRAWING NUMNER SHEET NUMBER

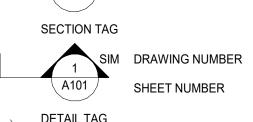

DRAWING NUMBER

DETAIL TAG DRAWING NUMBER SHEET NUMBER

PARTITION TAG PARTITION TYPE

(xxx)DOOR TAG WINDOW TAG

2 HOUR RATED BARRIER

Issue Date:

THIRD FLOOR PLAN

08/12/19

A-102-00

SHEET:

WALL TYPES

W1 - SHAFT WALL 2 HOUR FIRE WALL UL#938 5/8" DRYWALL - 7/8" METAL FURRING - 8" MASONRY WALL HEIGHT (SEE ELEVATOR DRAWINGS) AS PER 2018 NCSBC SECTION 708

W2 - SHAFT WALL 2 HOUR FIRE WALL UL#938 8" MASONRY 2 HR RATED WALL HEIGHT (SEE ELEVATOR DRAWINGS) AS PER 2018 NCSBC SECTION 708





A-303-00

(G)

A-301-00




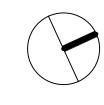

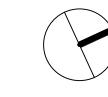

GENERAL NOTES

DO NOT SCALE DRAWING. CONTRACTOR SHALL RELY ON WRITTEN DIMENSIONS AS SHOWN. THE CONTRACTOR SHALL NOTIFY THE ARCHITECT FOR CLARIFICATION. ALL DIMENSIONS SHALL BE VERIFIED BY THE CONTRACTOR AND COORDINATED WITH ALL OF THE OF ALL TRADES. IF DISCREPANCIES ARE FOUND THE CONTRACTOR SHALL NOTIFIED THE ARCHITECT IN WRITING FOR CLARIFICATION BEFORE STARTING THE

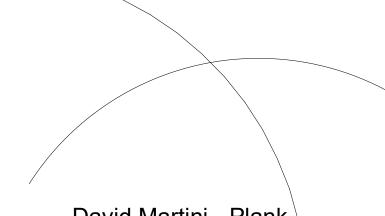

David Martini - Plank

ARCHITECT

KEYNOTE LEGEND

IN ALL VERT. PIPE CHASES FOR ROOF LEADERS, METAL STUDS SHALL HAVE METAL STUDS EACH SIDE WITH FRONT SCREW SHIELDS CONT.

RAISED FLOOR ON ADJUSTABLE

ROOF DRAIN BELOW RAISED FLOOR ROOF DRAIN TEMPERED GLASS RAILING ROOF WALKWAY PADS MECHANICAL EQUIPMENT. SEE MECH. DWGS.

PEDESTAL SYSTEM

PROJECT TEAM: **ARCHITECT OF RECORD** David Martini - Plank, AIA NC Registration: 5453 143 Village View Drive - Suite 203 Mooresville, NC 28117 704-777-4447 dmartiniplank@gmail.com Architecture Interiors Master Planning

GENERAL CONTRACTOR Kearey Builders Ryan Kearey 2915 Charlotte Highway Mooresville, NC 28117 980-444-6510

Development



<u>PROJECT</u>

DAVIDSON GATEWAY CENTER 635 DAVIDSON GATEWAY DRIVE **DAVIDSON NC 28036**

SYMBOL LEGEND

DRAWING NUMBER

A0500

DRAWING NUMNER SHEET NUMBER

SECTION TAG DRAWING NUMBER SHEET NUMBER DETAIL TAG

DRAWING NUMBER SHEET NUMBER PARTITION TAG

PARTITION TYPE (xxx)DOOR TAG


WINDOW TAG

2 HOUR RATED BARRIER

Issue Date:

08/12/19

FOURTH FLOOR CONSTRUCTION PLAN A-103-00 SHEET:

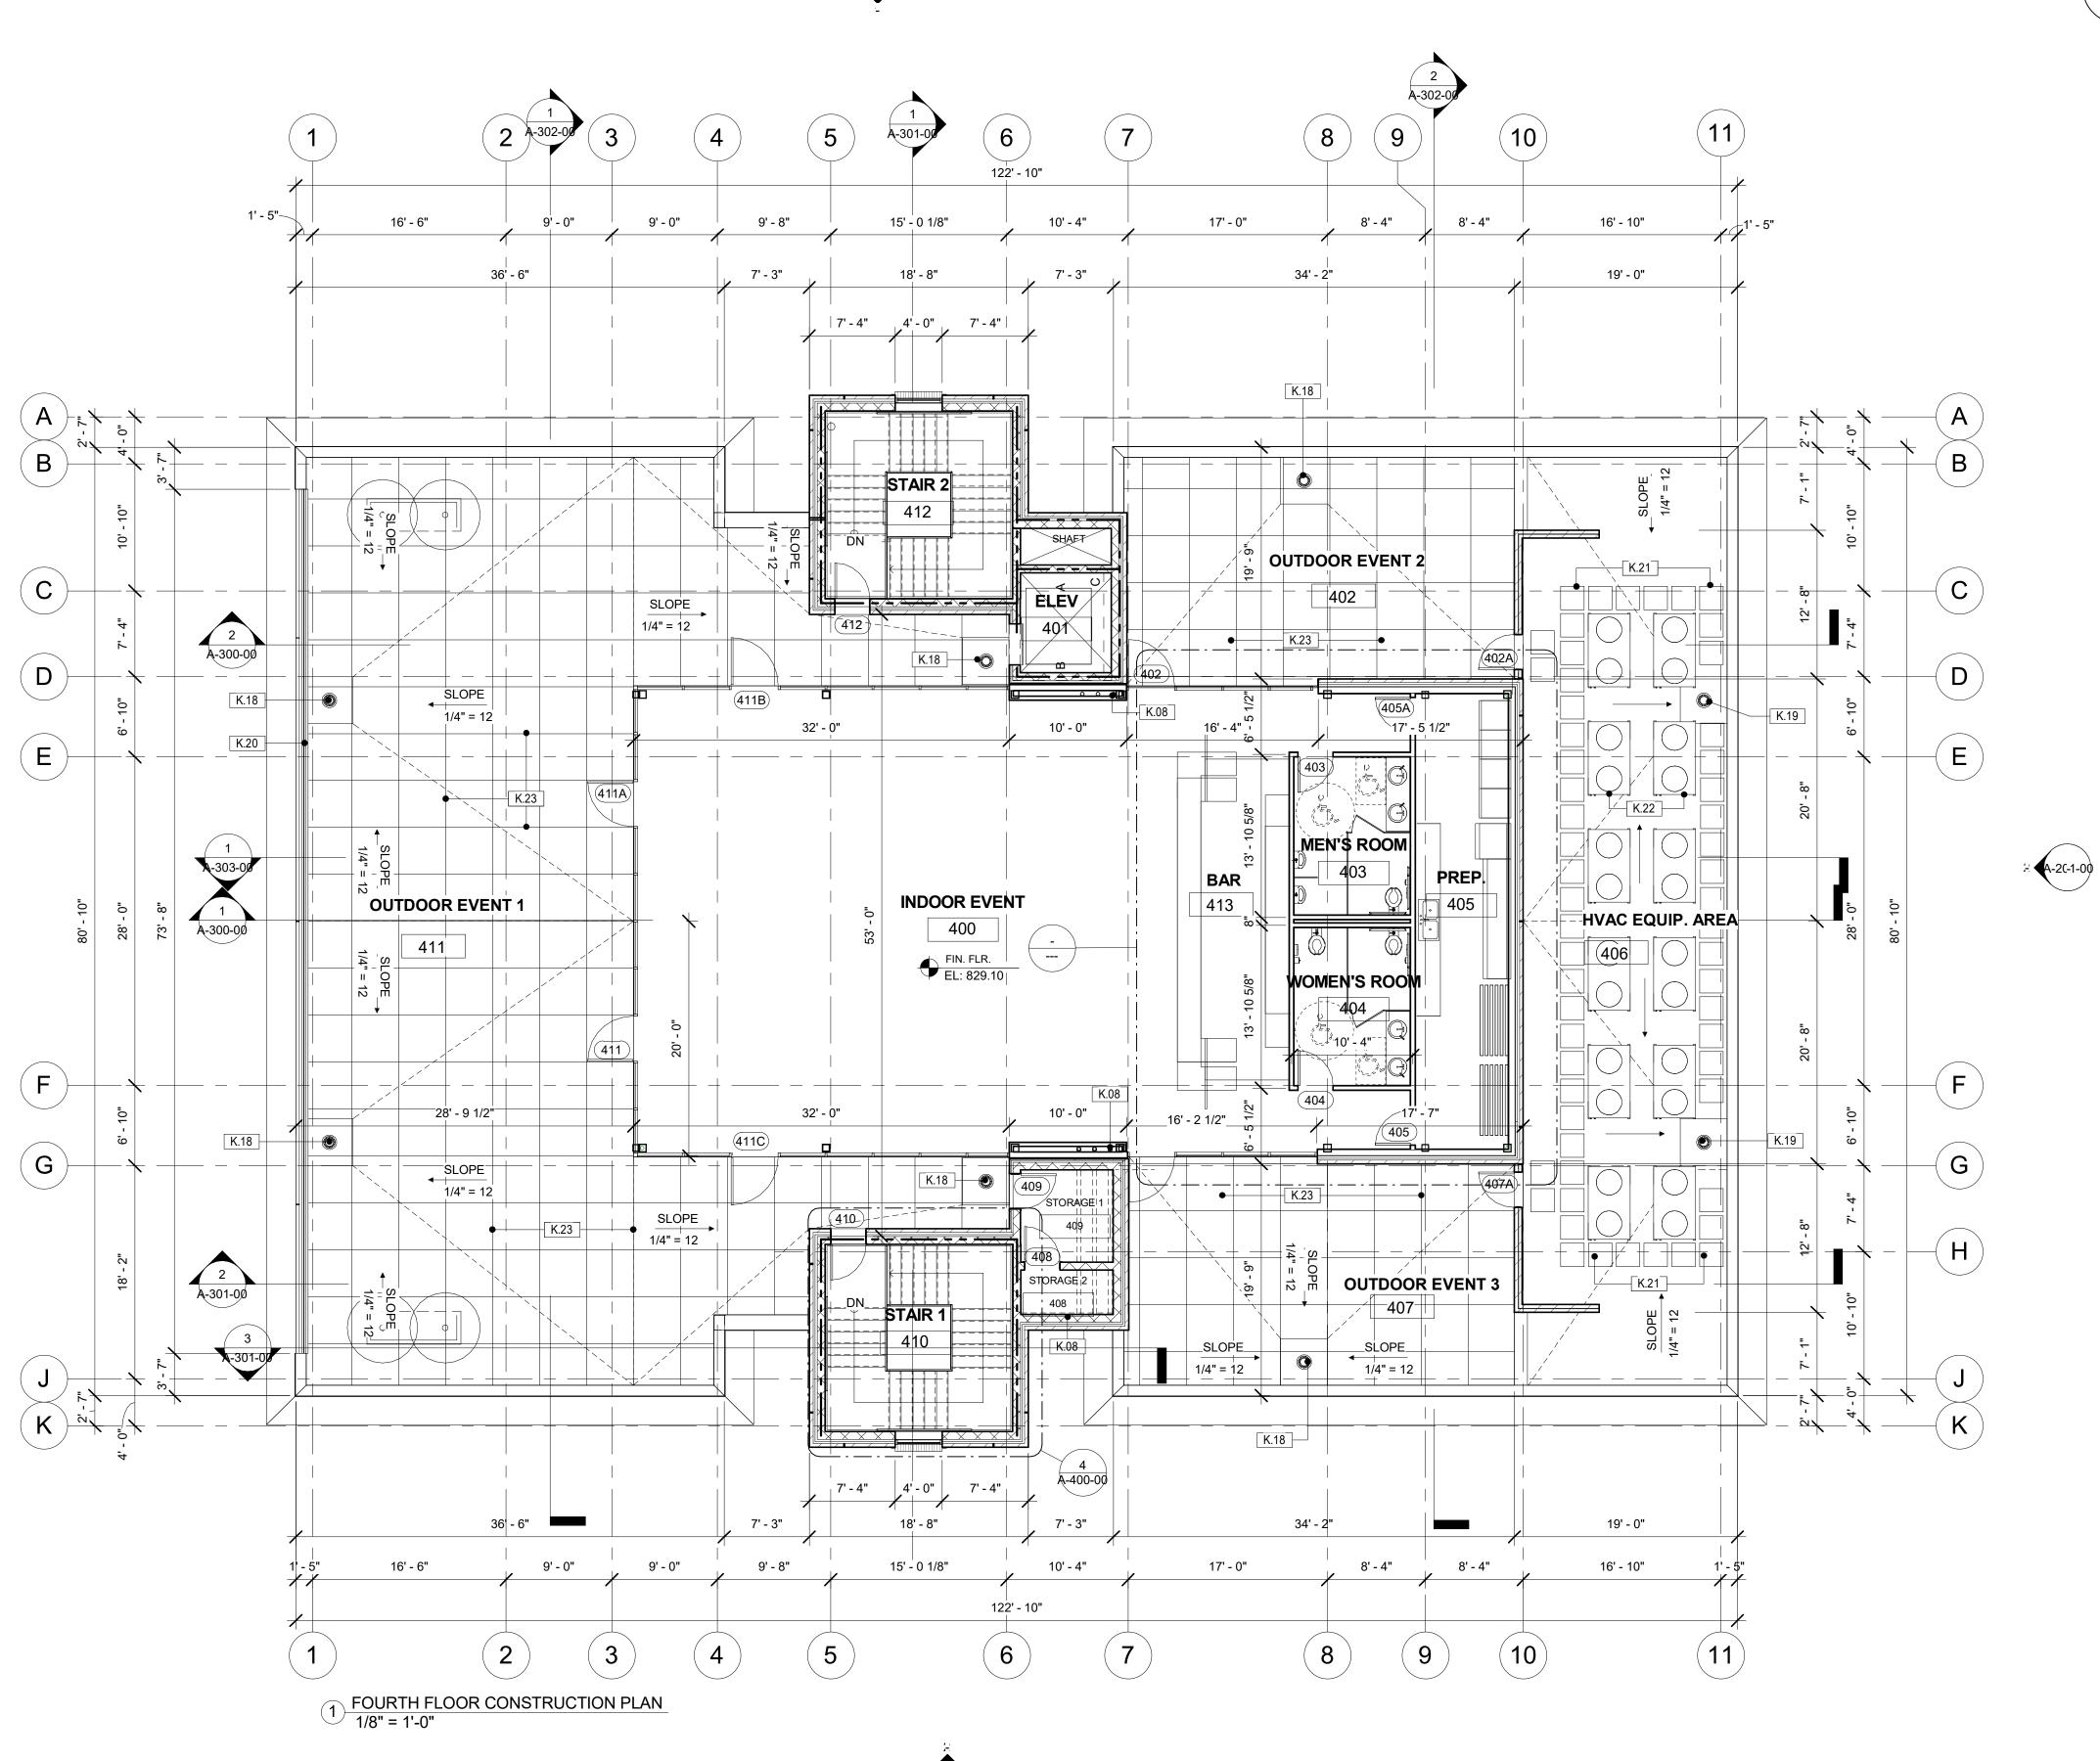


A-2C-0-0)


WALL TYPES

AS PER 2018 NCSBC SECTION 708

W1 - SHAFT WALL 2 HOUR FIRE WALL UL#938 5/8" DRYWALL - 7/8" METAL FURRING - 8" MASONRY WALL HEIGHT (SEE ELEVATOR DRAWINGS)

W2 - SHAFT WALL 2 HOUR FIRE WALL UL#938 8" MASONRY 2 HR RATED WALL HEIGHT (SEE ELEVATOR DRAWINGS) AS PER 2018 NCSBC SECTION 708

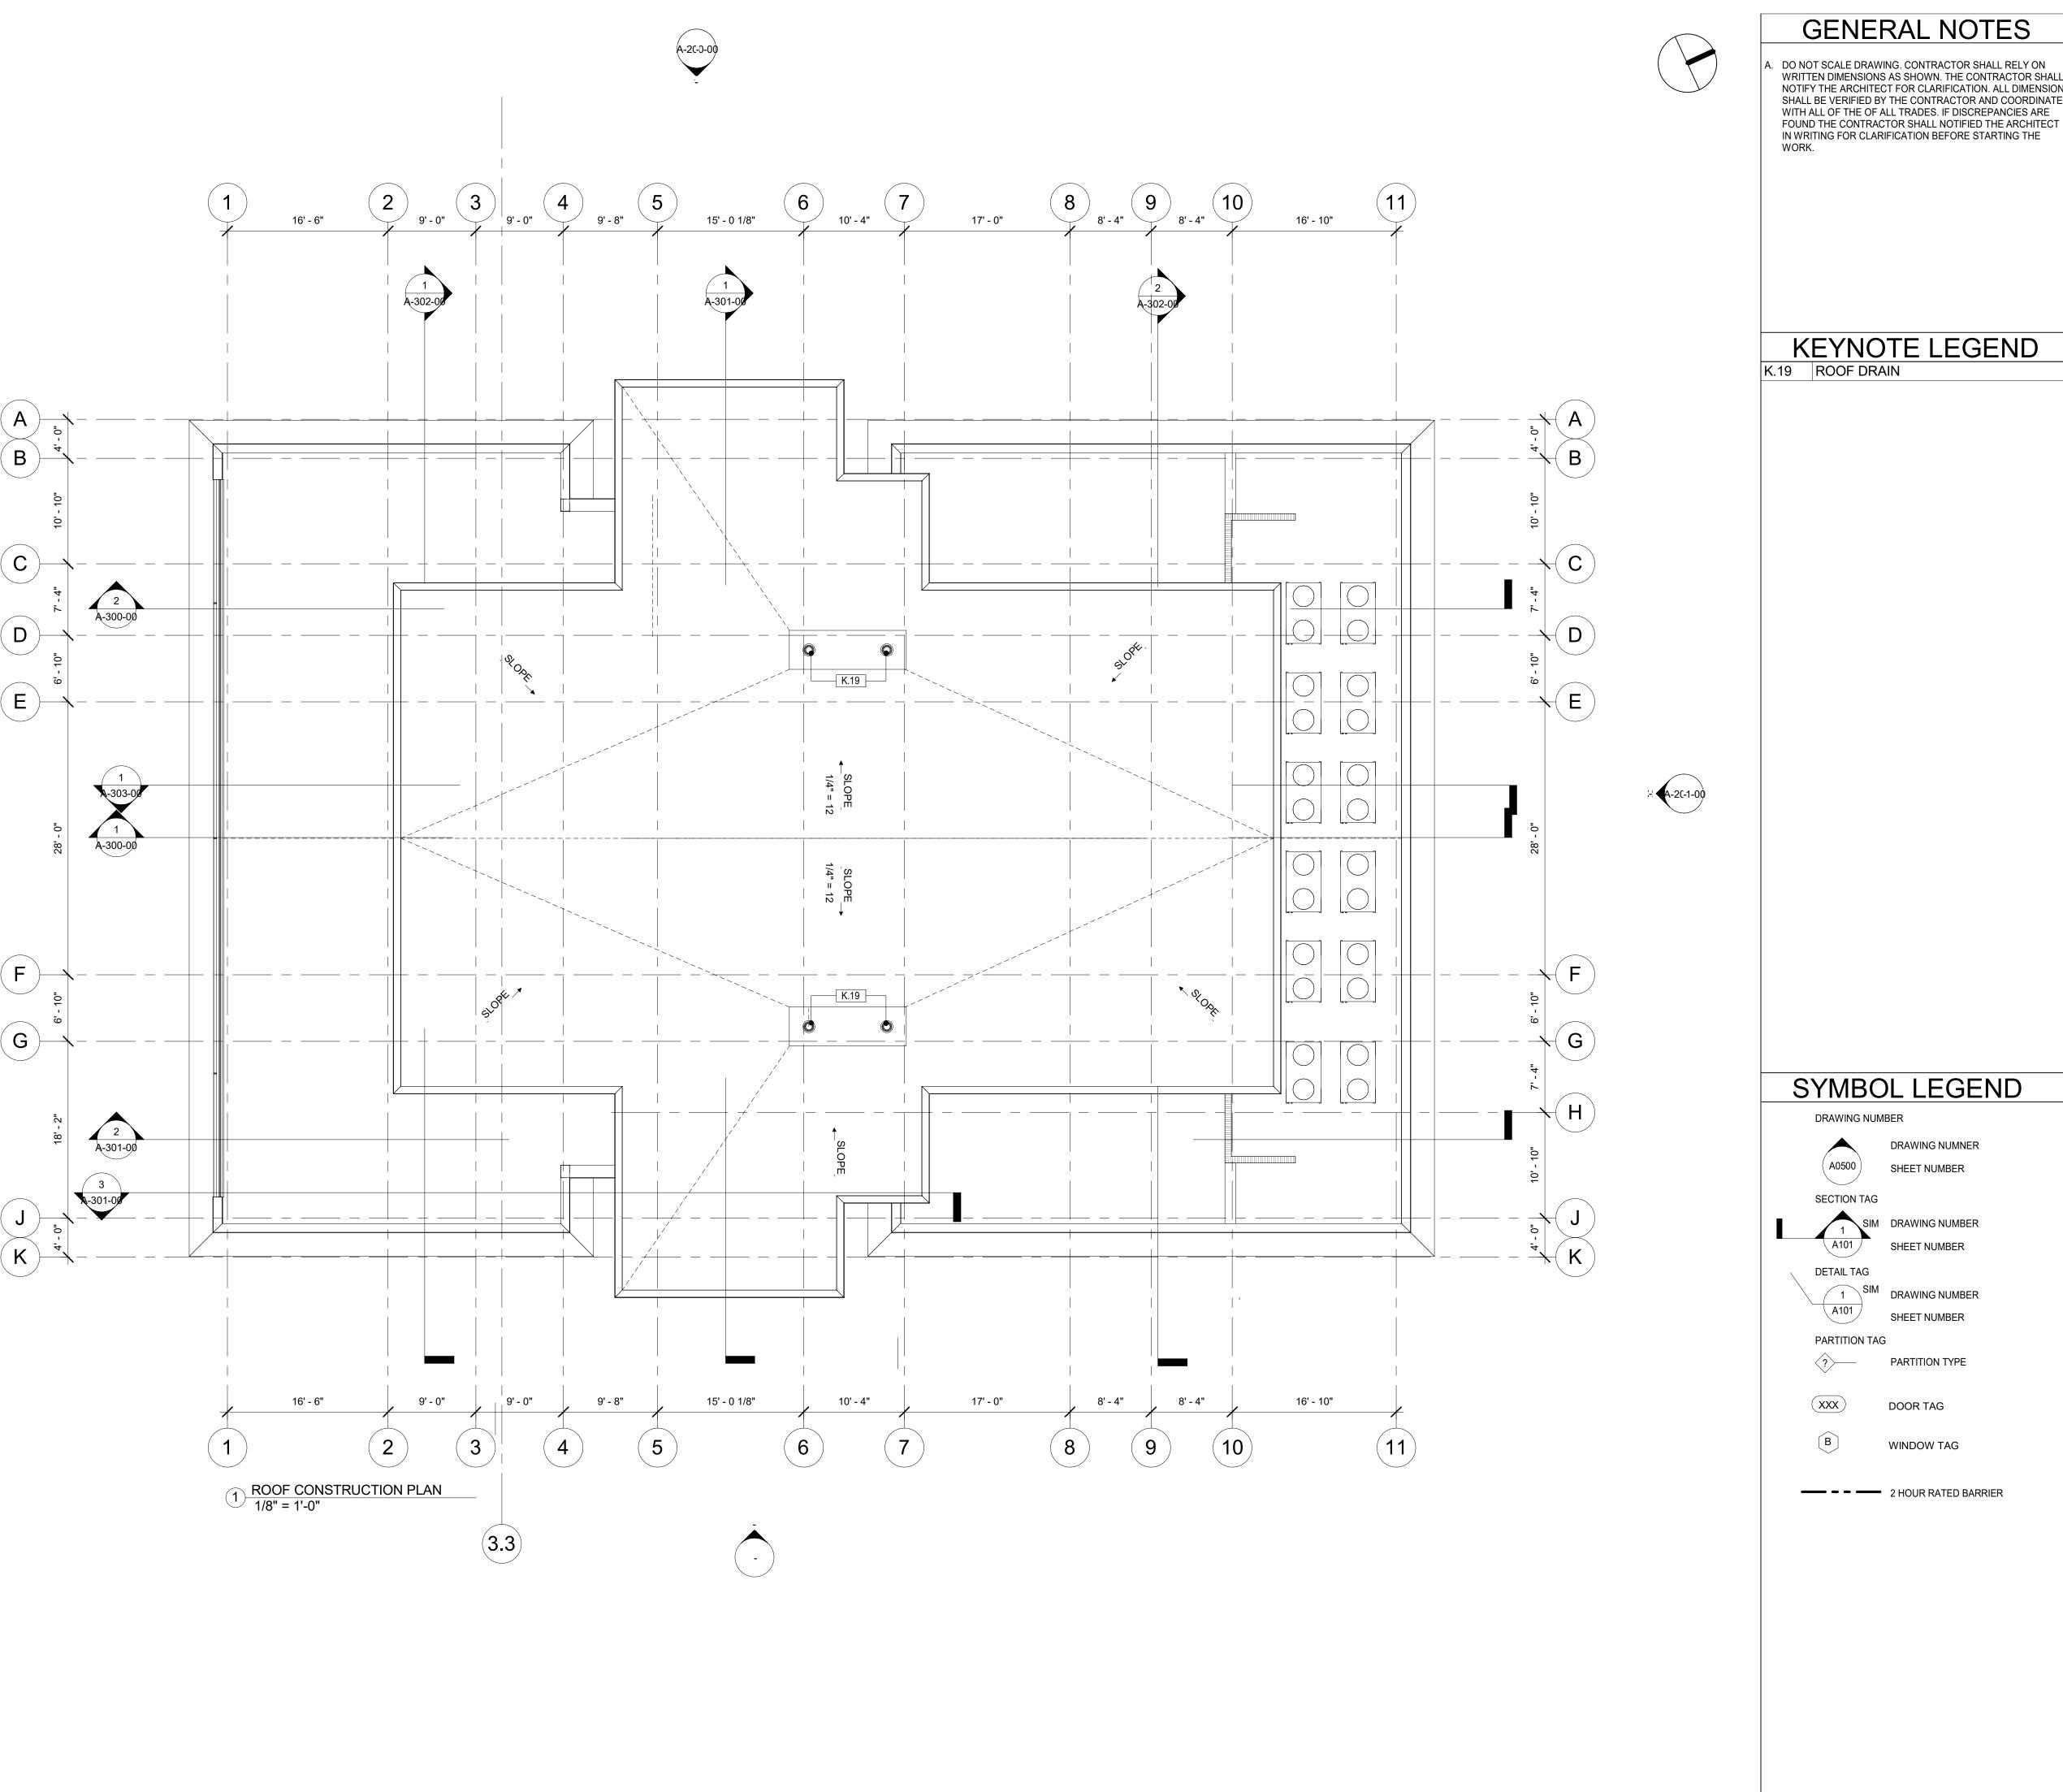

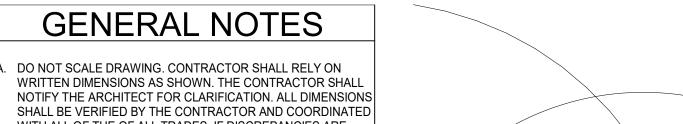

David Martini - Plank

ARCHITECT

KEYNOTE LEGEND

PROJECT TEAM: ARCHITECT OF RECORD David Martini - Plank, AIA NC Registration : 5453 143 Village View Drive - Suite 203 Mooresville, NC 28117 704-777-4447 dmartiniplank@gmail.com Architecture Interiors Master Planning

GENERAL CONTRACTOR Kearey Builders Ryan Kearey 2915 Charlotte Highway Mooresville, NC 28117 980-444-6510

Development



DAVIDSON GATEWAY CENTER 635 DAVIDSON GATEWAY DRIVE **DAVIDSON NC 28036**

SYMBOL LEGEND

DRAWING NUMBER

(xxx)

DRAWING NUMNER SHEET NUMBER

SECTION TAG SIM DRAWING NUMBER SHEET NUMBER DETAIL TAG

1 SIM DRAWING NUMBER SHEET NUMBER PARTITION TAG

PARTITION TYPE

WINDOW TAG

2 HOUR RATED BARRIER


DOOR TAG


Issue Date:

ROOF CONSTRUCTION PLAN

08/12/19

A-104-00

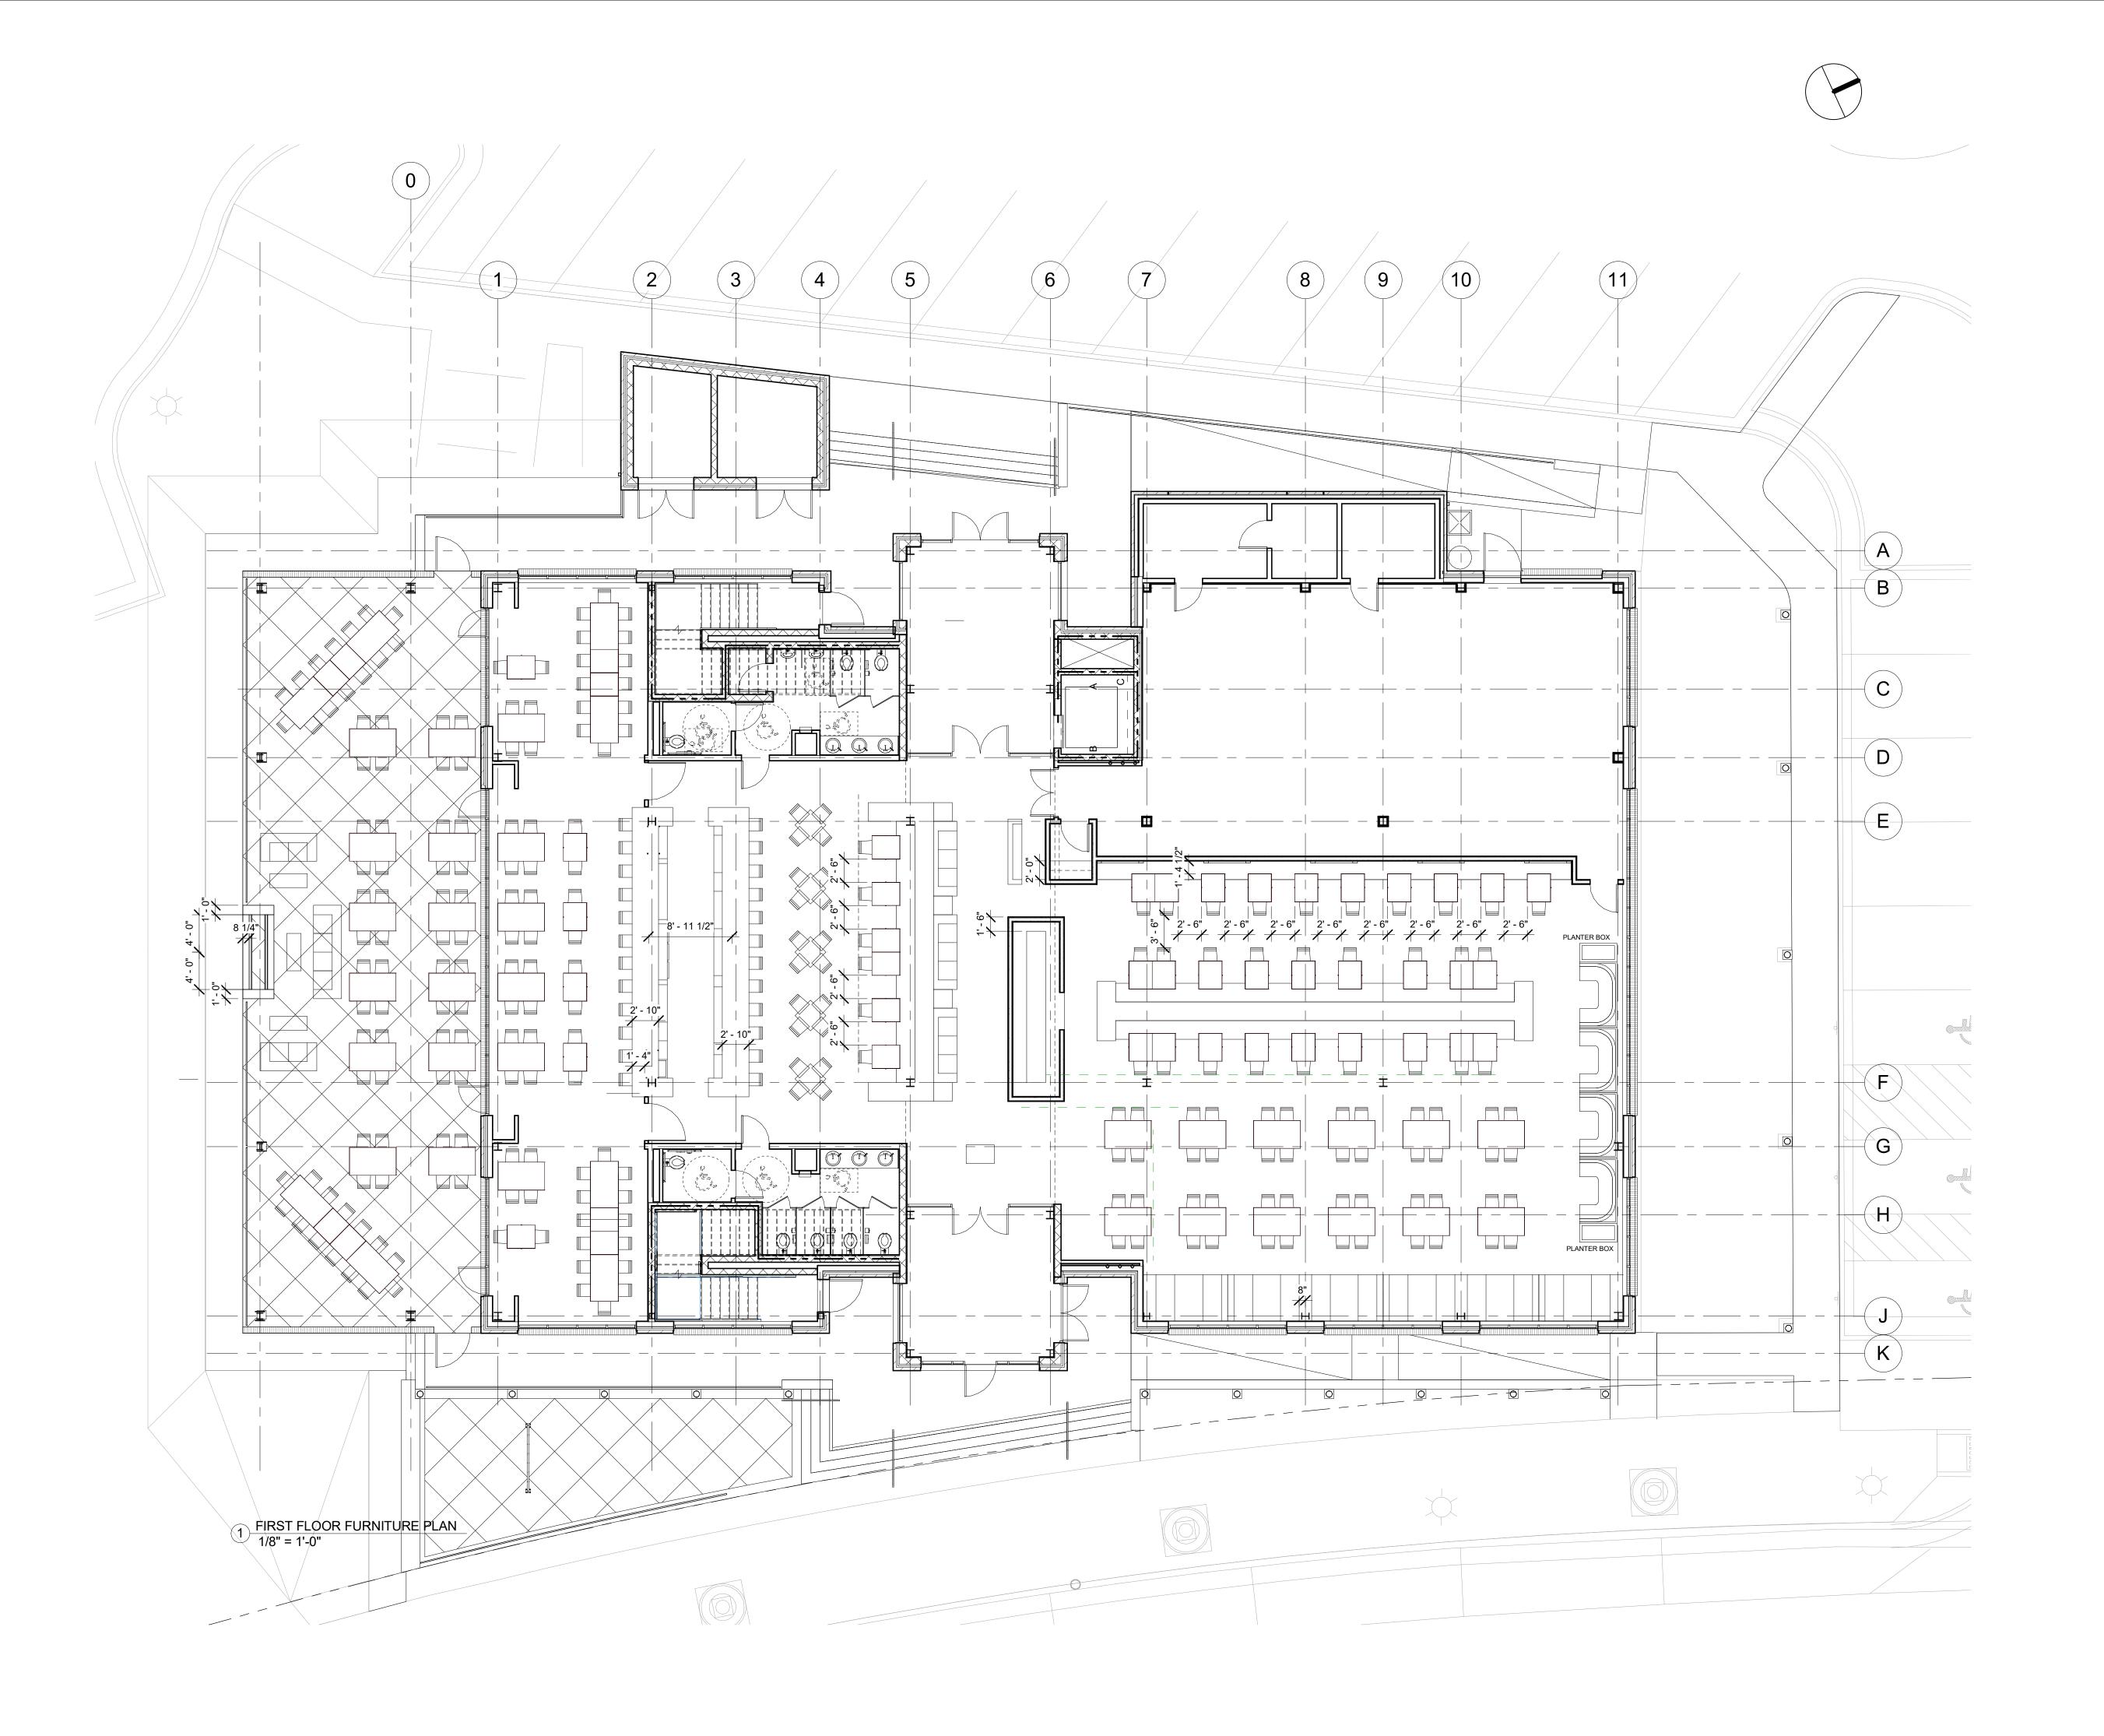

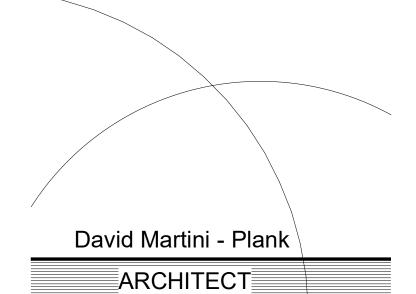

PROJECT TEAM:

ARCHITECT OF RECORD

David Martini - Plank, AIA

NC Registration: 5453

143 Village View Drive - Suite 203

Mooresville, NC 28117

704-777-4447

dmartiniplank@gmail.com

Architecture
Interiors
Master Planning
Development

GENERAL CONTRACTOR
Kearey Builders
Ryan Kearey
2915 Charlotte Highway
Mooresville, NC 28117
980-444-6510



PROJECT

DAVIDSON GATEWAY CENTER 635 DAVIDSON GATEWAY DRIVE DAVIDSON NC 28036


Sea

Issue Date:


08/12/19

FIRST FLOOR FURNITURE PLAN

A-160-00

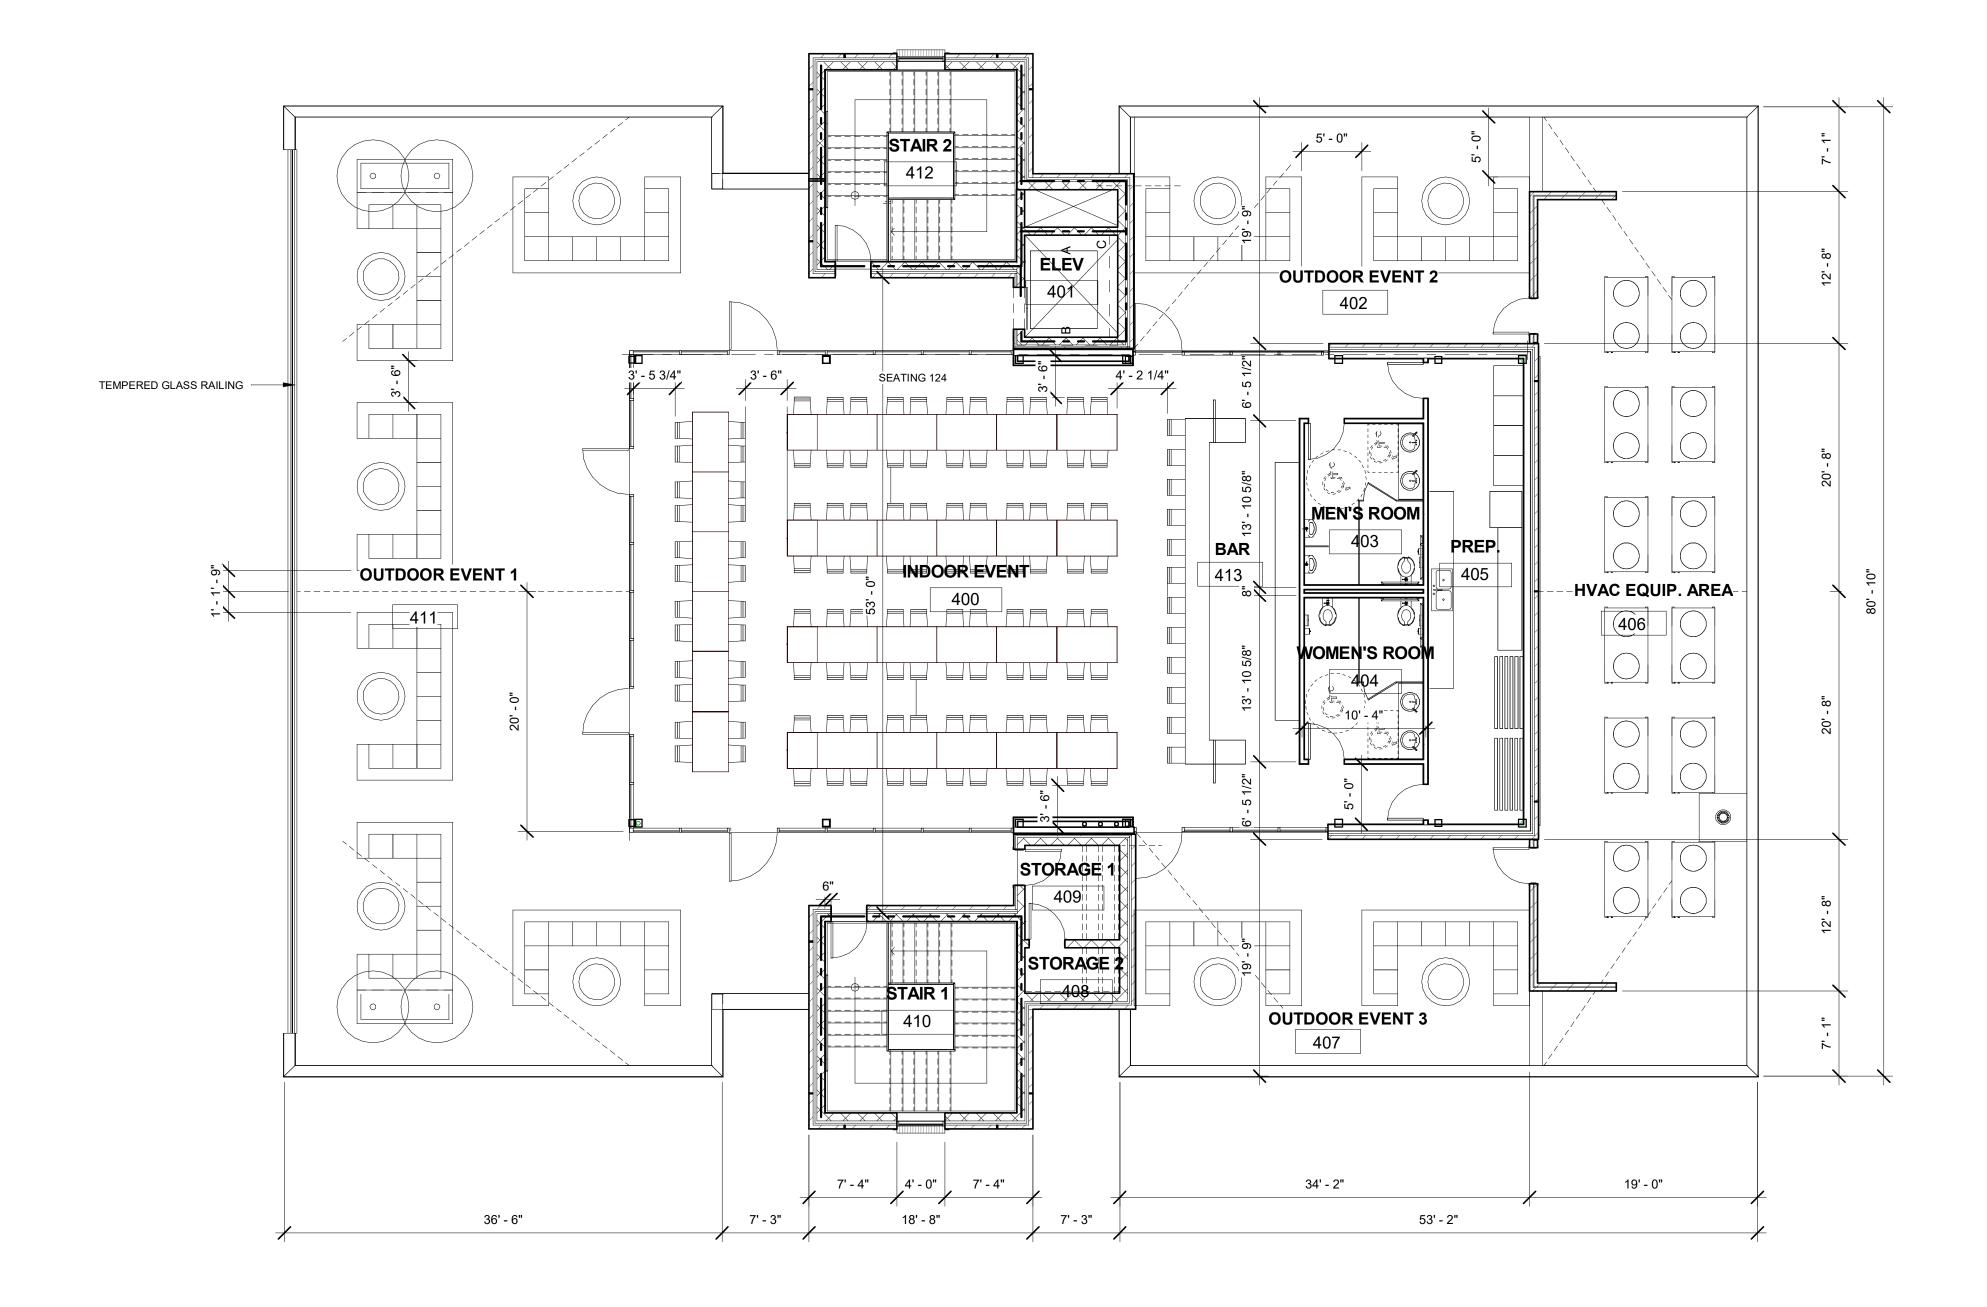

1 FOURTH FLOOR FURNITURE PLAN
1/8" = 1'-0"

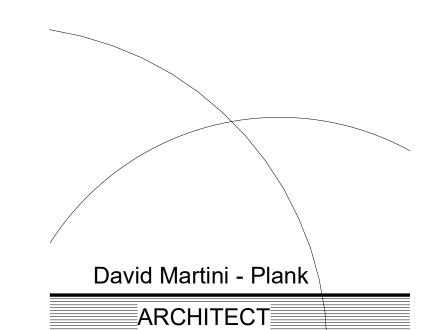

PROJECT TEAM:
ARCHITECT OF RECORD

David Martini - Plank, AIA
NC Registration: 5453
143 Village View Drive - Suite 203
Mooresville, NC 28117
704-777-4447
dmartiniplank@gmail.com

Architecture
Interiors
Master Planning

GENERAL CONTRACTOR
Kearey Builders
Ryan Kearey
2915 Charlotte Highway
Mooresville, NC 28117
980-444-6510

Development



PROJECT

DAVIDSON GATEWAY CENTER 635 DAVIDSON GATEWAY DRIVE DAVIDSON NC 28036

S

Issue Date:


08/12/19

FOURTH FLOOR FURNITURE PLAN A-161-00






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KEYNOTE LEGEND

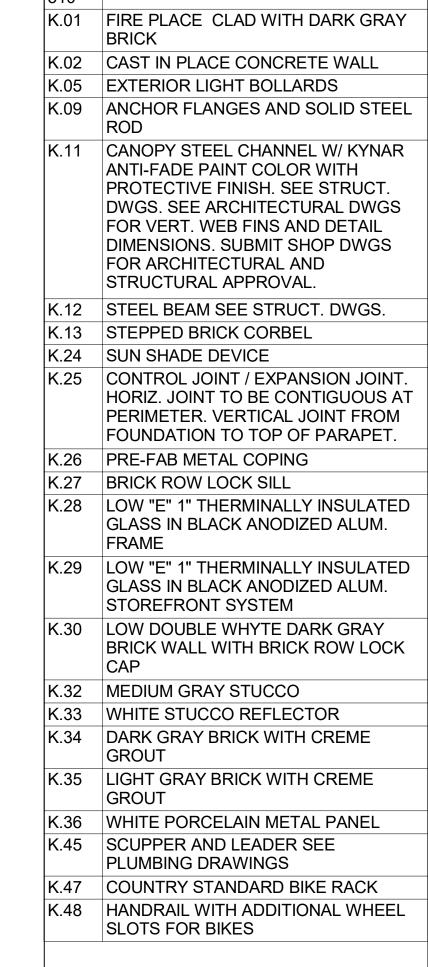

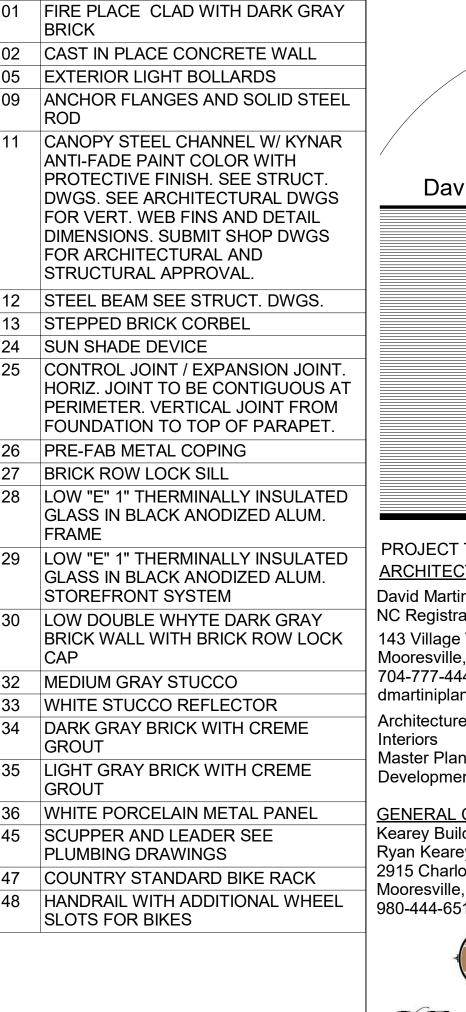

08/12/19 Issue Date:

ELEVATIONS


A-200-00 SHEET:





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K	EYNOTE LEGEND
K.09	ANCHOR FLANGES AND SOLID STEEL ROD
K.11	CANOPY STEEL CHANNEL W/ KYNAR ANTI-FADE PAINT COLOR WITH PROTECTIVE FINISH. SEE STRUCT. DWGS. SEE ARCHITECTURAL DWGS FOR VERT. WEB FINS AND DETAIL DIMENSIONS. SUBMIT SHOP DWGS FOR ARCHITECTURAL AND STRUCTURAL APPROVAL.
K.13	STEPPED BRICK CORBEL
K.24	SUN SHADE DEVICE
K.25	CONTROL JOINT / EXPANSION JOINT. HORIZ. JOINT TO BE CONTIGUOUS AT PERIMETER. VERTICAL JOINT FROM FOUNDATION TO TOP OF PARAPET
K.26	PRE-FAB METAL COPING
K.28	LOW "E" 1" THERMINALLY INSULATED GLASS IN BLACK ANODIZED ALUM. FRAME
K.29	LOW "E" 1" THERMINALLY INSULATED GLASS IN BLACK ANODIZED ALUM. STOREFRONT SYSTEM

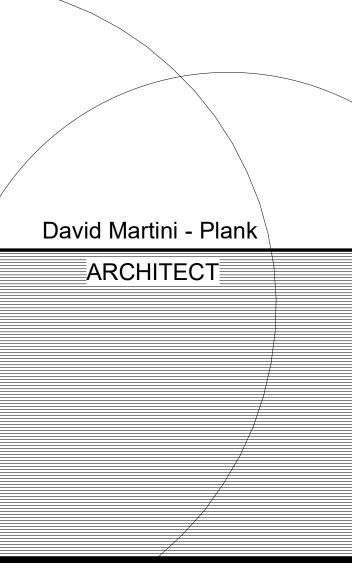

PROJECT TEAM:

ARCHITECT OF RECORD

David Martini - Plank, AIA

NC Registration : 5453

143 Village View Drive - Suite 203

Mooresville, NC 28117

704-777-4447

dmartiniplank@gmail.com

Architecture
Interiors

Master Planning
Development

GENERAL CONTRACTOR

Kearey Builders

Kearey Builders
Ryan Kearey
2915 Charlotte Highway
Mooresville, NC 28117
980-444-6510



PROJECT

DAVIDSON GATEWAY CENTER 635 DAVIDSON GATEWAY DRIVE DAVIDSON NC 28036


08/12/19

Issue Date:

ELEVATIONS

A-201-00 SHEET:



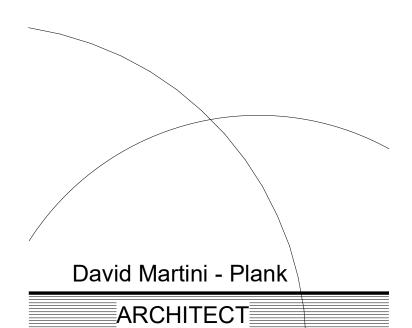

PROJECT TEAM:

ARCHITECT OF RECORD

David Martini - Plank, AIA

NC Registration: 5453

143 Village View Drive - Suite 203

Mooresville, NC 28117

704-777-4447

dmartiniplank@gmail.com

Architecture
Interiors

Master Planning
Development

GENERAL CONTRACTOR
Kearey Builders
Ryan Kearey
2915 Charlotte Highway
Mooresville, NC 28117
980-444-6510



PROJECT

DAVIDSON GATEWAY CENTER

635 DAVIDSON GATEWAY DRIVE
DAVIDSON NC 28036


368

Issue Date:

08/12/19

BUILDING SECTION

A-300-00 SHEET:

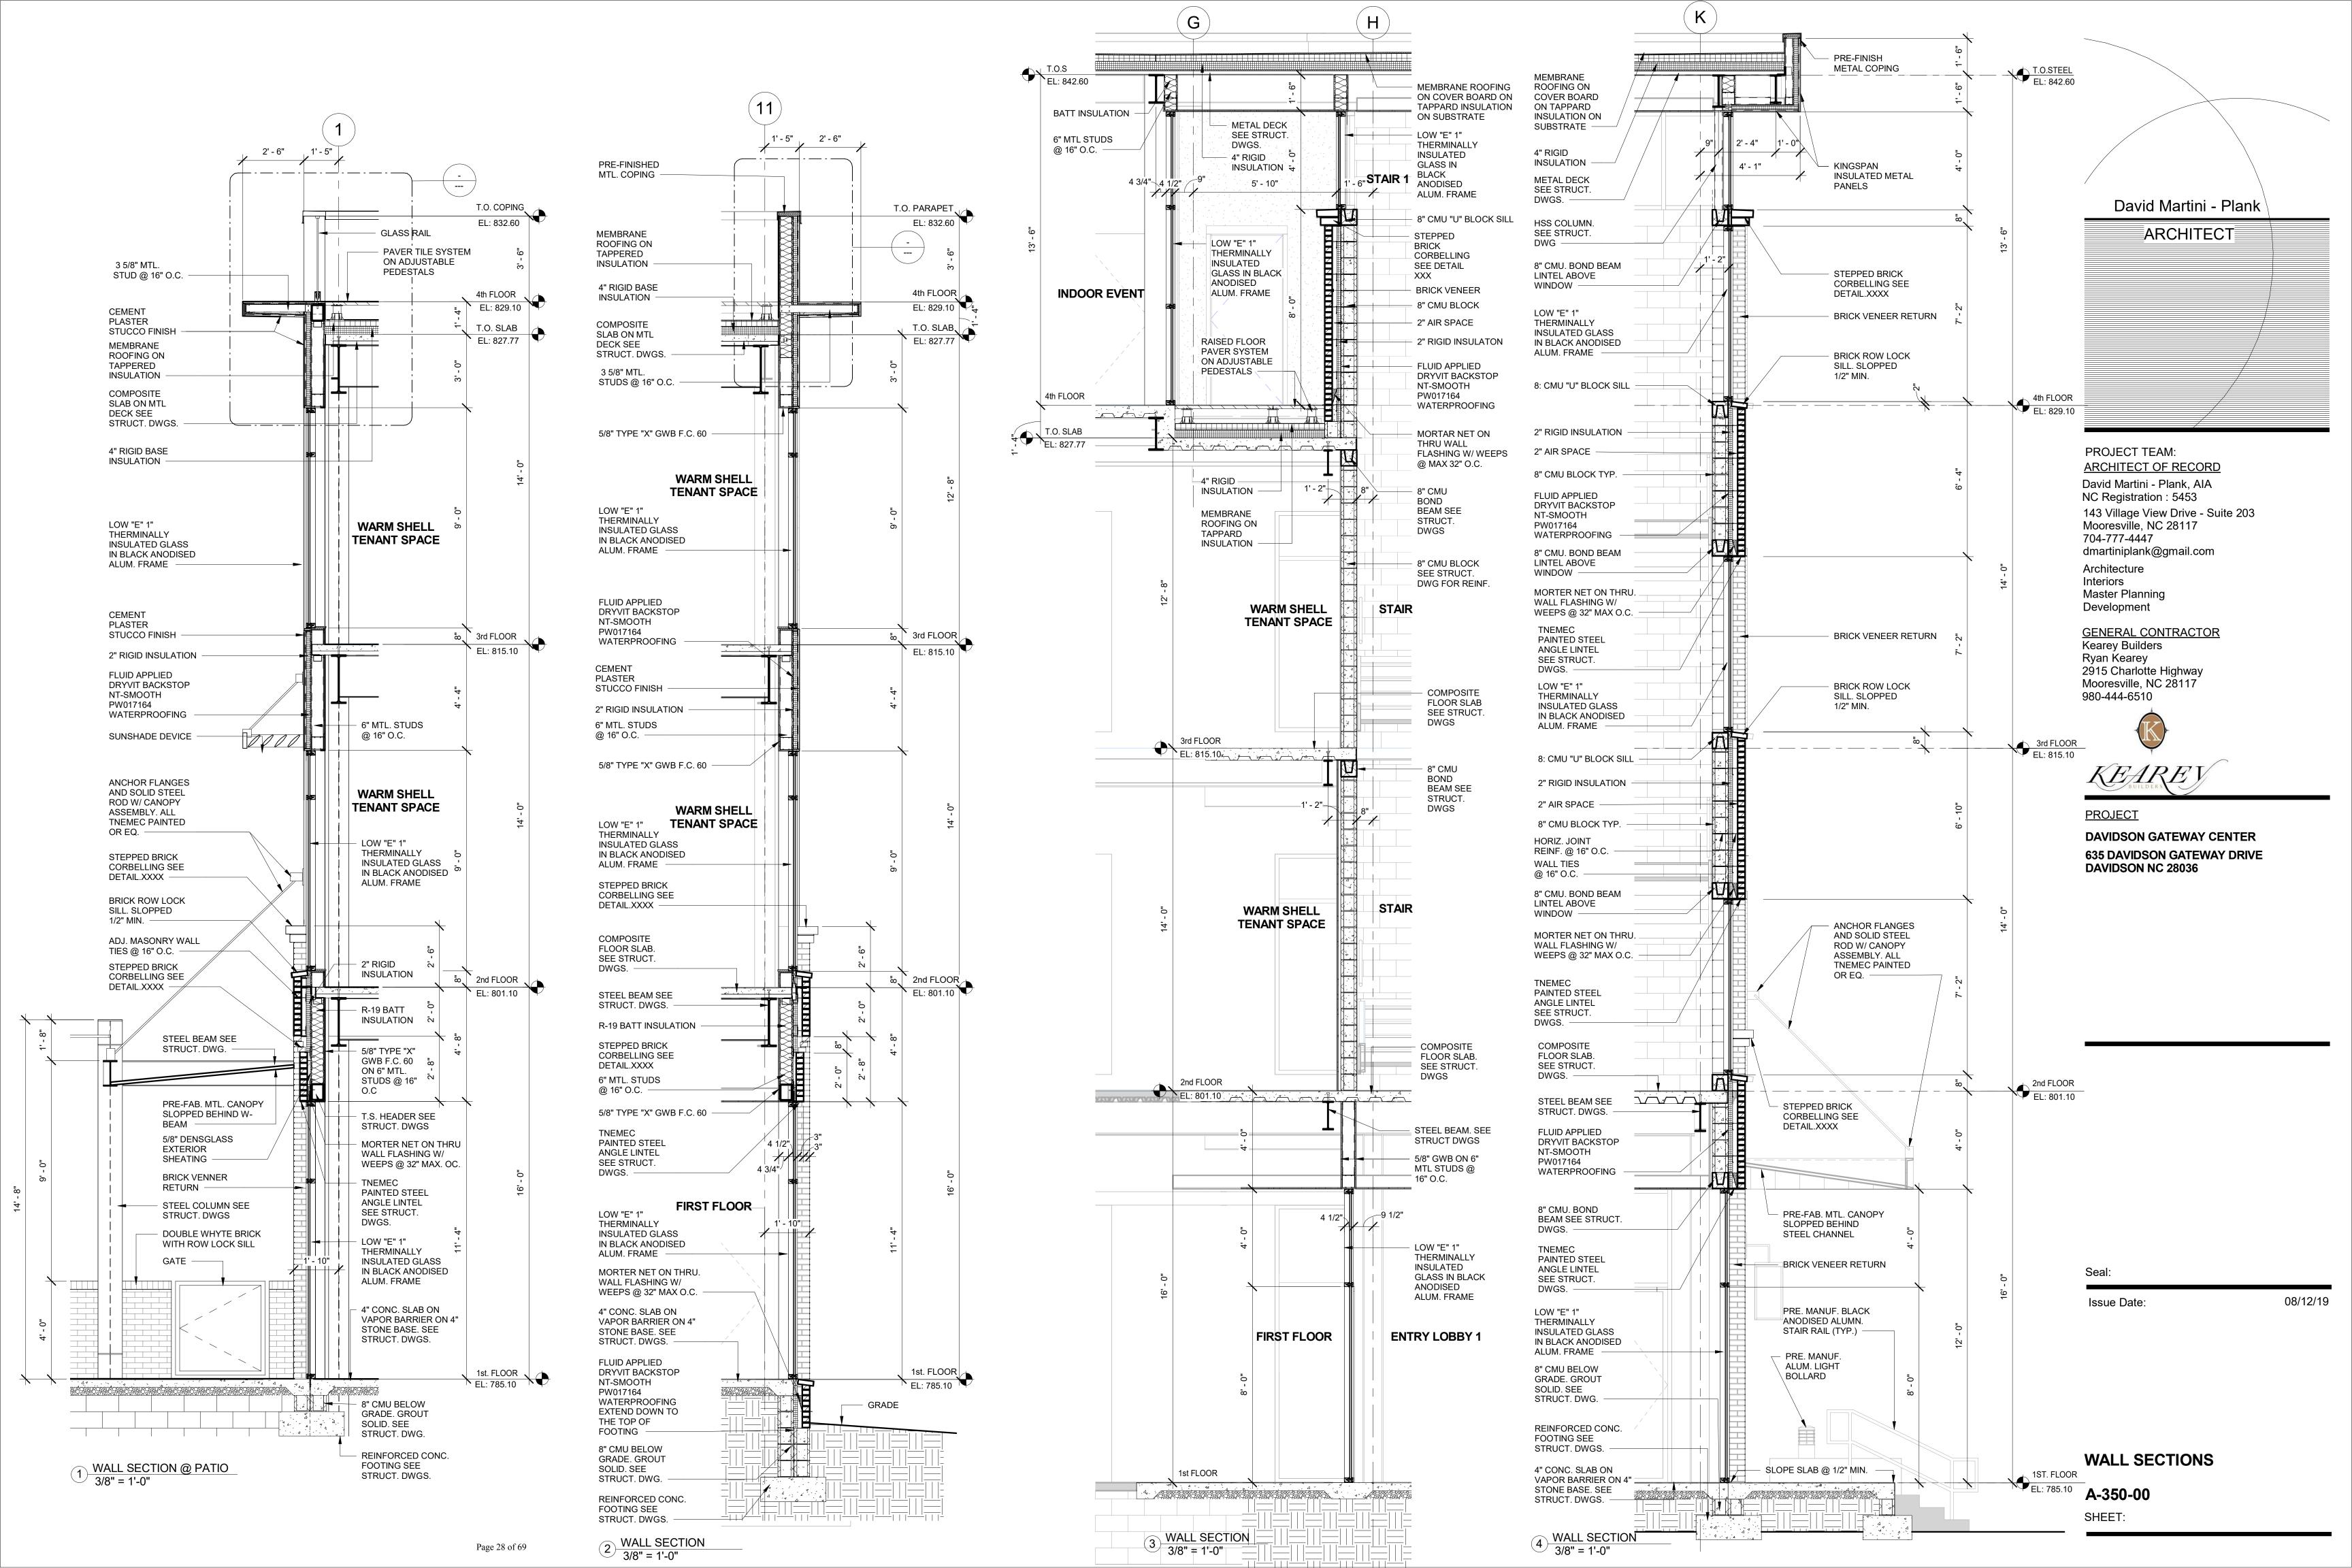



David Martini - Plank

ARCHITECT

PROJECT TEAM: ARCHITECT OF RECORD

David Martini - Plank, AIA

NC Registration: 5453

143 Village View Drive - Suite 203

Mooresville, NC 28117

704-777-4447

dmartiniplank@gmail.com Architecture
Interiors
Master Planning
Development

GENERAL CONTRACTOR
Kearey Builders
Ryan Kearey
2915 Charlotte Highway
Mooresville, NC 28117
980-444-6510



<u>PROJECT</u>

DAVIDSON GATEWAY CENTER 635 DAVIDSON GATEWAY DRIVE DAVIDSON NC 28036


Issue Date:

08/12/19

PERSPECTIVE VIEWS

A-459.00



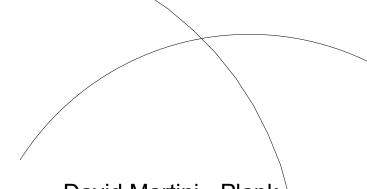

David Martini - Plank

ARCHITECT

PROJECT TEAM:
ARCHITECT OF RECORD

David Martini - Plank, AIA
NC Registration: 5453

143 Village View Drive - Suite 203
Mooresville, NC 28117
704-777-4447
dmartiniplank@gmail.com

Architecture
Interiors
Master Planning
Development

GENERAL CONTRACTOR
Kearey Builders
Ryan Kearey
2915 Charlotte Highway
Mooresville, NC 28117
980-444-6510



<u>PROJECT</u>

DAVIDSON GATEWAY CENTER 635 DAVIDSON GATEWAY DRIVE DAVIDSON NC 28036

Sea


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08/12/19


PERSPECTIVE VIEW

A-460.00 SHEET:

Page 30 of 69

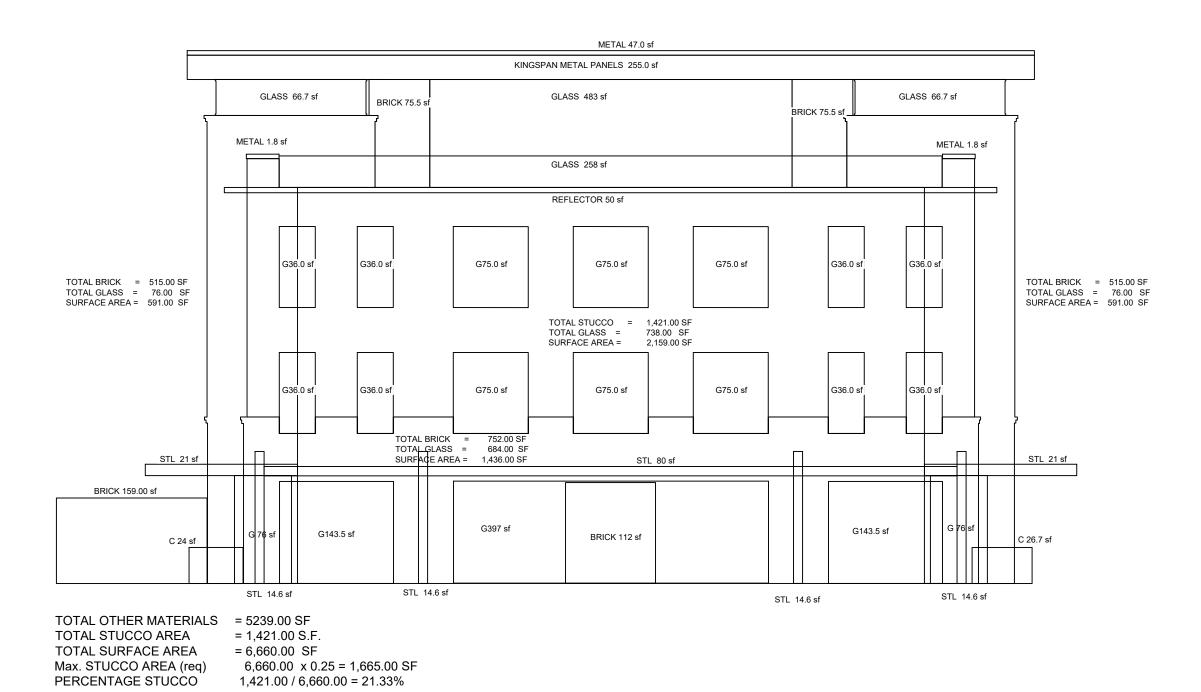


PERCENTAGE OF STUCCO @ FACADE NOT GREATER THAN 25 %

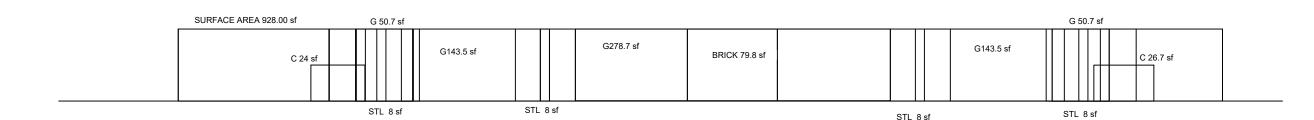


TOTAL AREA = 928.2 SF TOTAL GLASS = 616.4 S.F. PERCENTAGE TRANSPARENCY 616.4 / 928.2 = 66.4 %

PERCENTAGE OF TRANSPARENY @ FIRST FLOOR AT LEAST 65%



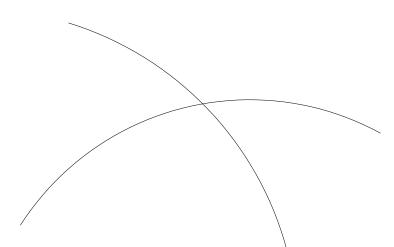

David Martini - Plank

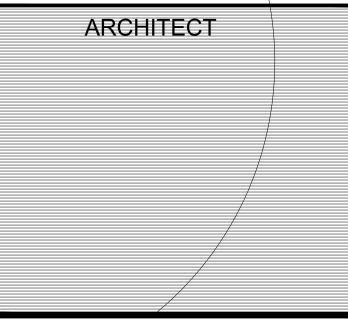

PROJECT TEAM:

GENERAL CONTRACTOR

Kearey Builders Ryan Kearey 2915 Charlotte Highway Mooresville, NC 28117 980-444-6510

ARCHITECT OF RECORD

David Martini - Plank, AIA NC Registration : 5453

143 Village View Drive - Suite 203 Mooresville, NC 28117 704-777-4447 dmartiniplank@gmail.com

Architecture Interiors Master Planning Development

PROJECT

DAVIDSON GATEWAY CENTER 635 DAVIDSON GATEWAY DRIVE DAVIDSON NC 28036


Sea

Issue Date:

07/31/19

SOUTH ELEVATION

MA-101-00 SHEET:

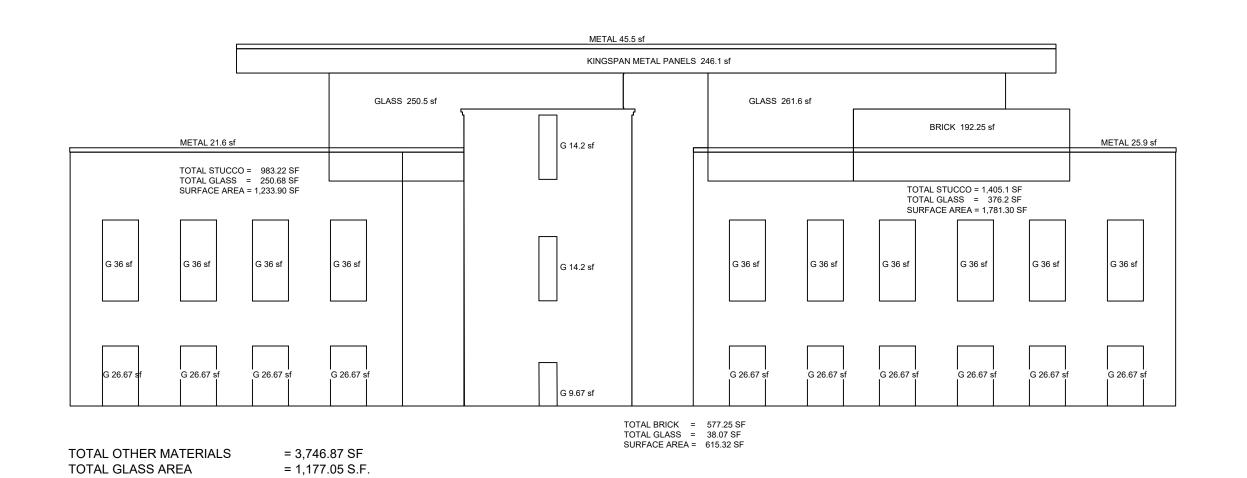


PERCENTAGE OF TRANSPARENY @ UPPER FLOORS AT LEAST 30%


= 4,923.92 SF

PERCENTAGE TRANSPARENCY 1,177.05 / 4,923.92 = 23.9%


TOTAL SURFACE AREA

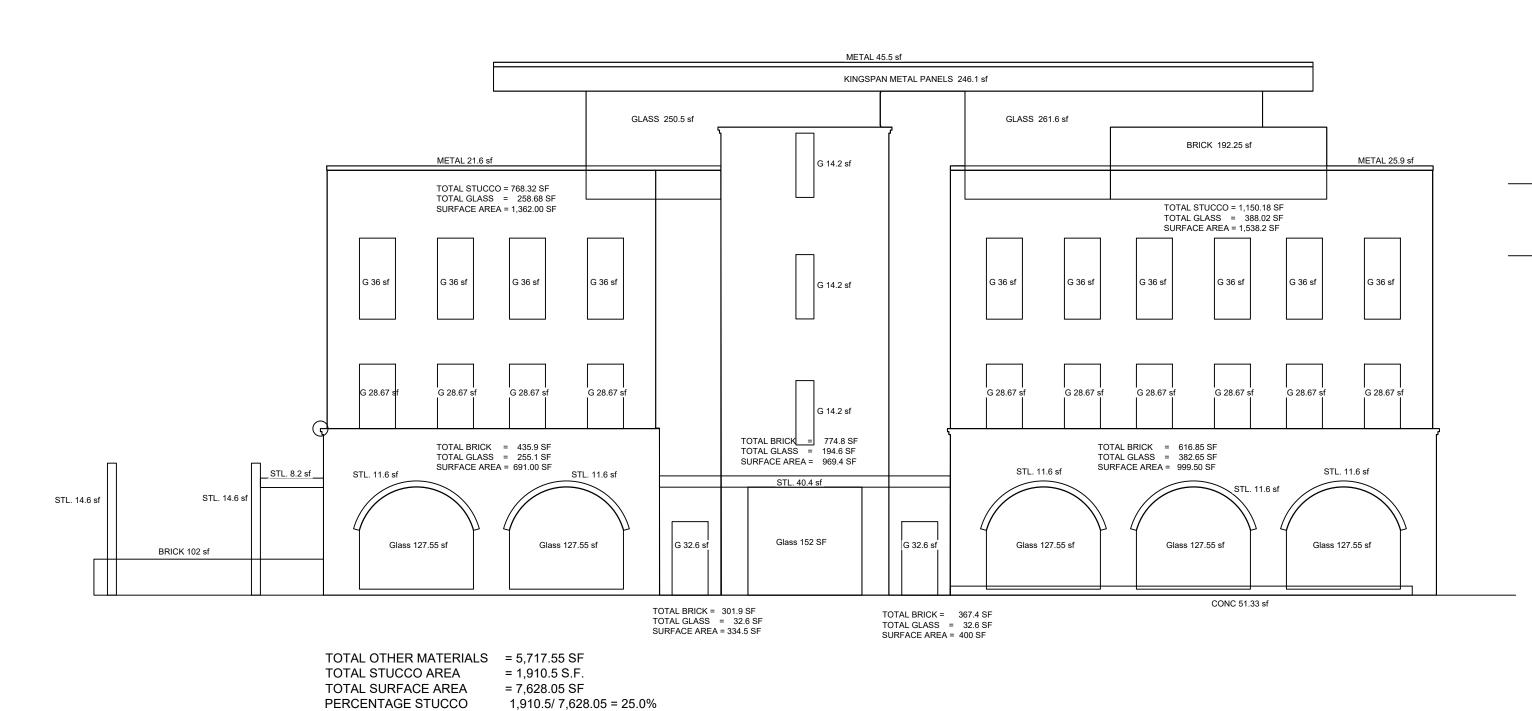


PERCENTAGE OF STUCCO @ FACADE NOT GREATER THAN 25%

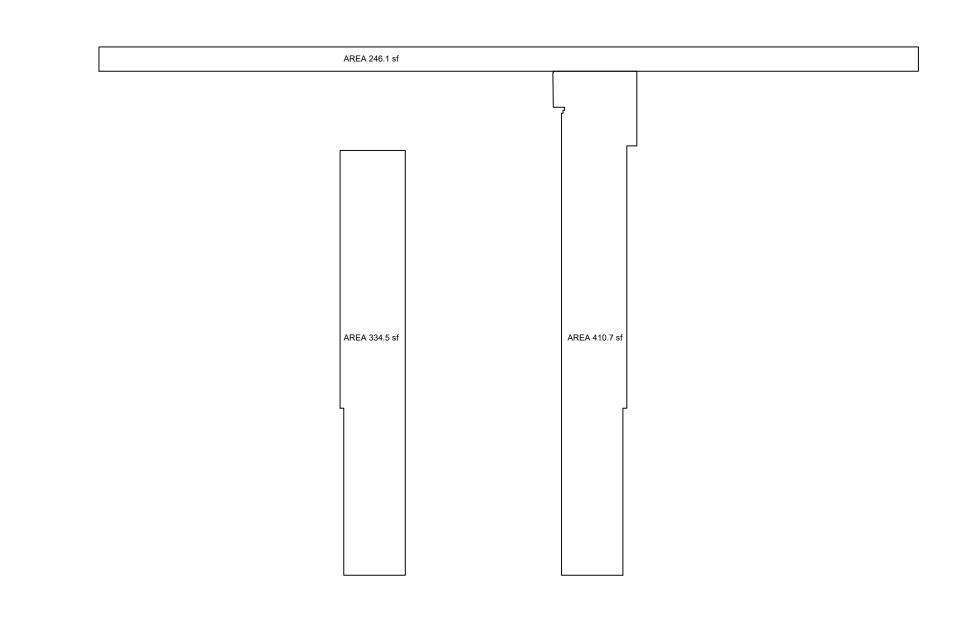

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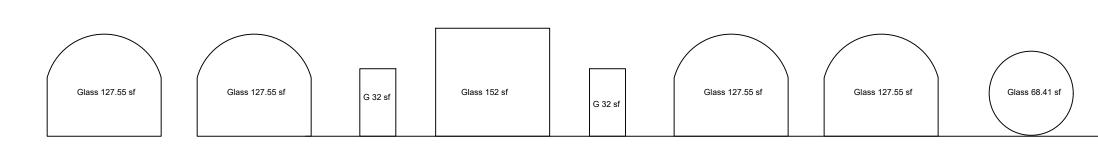


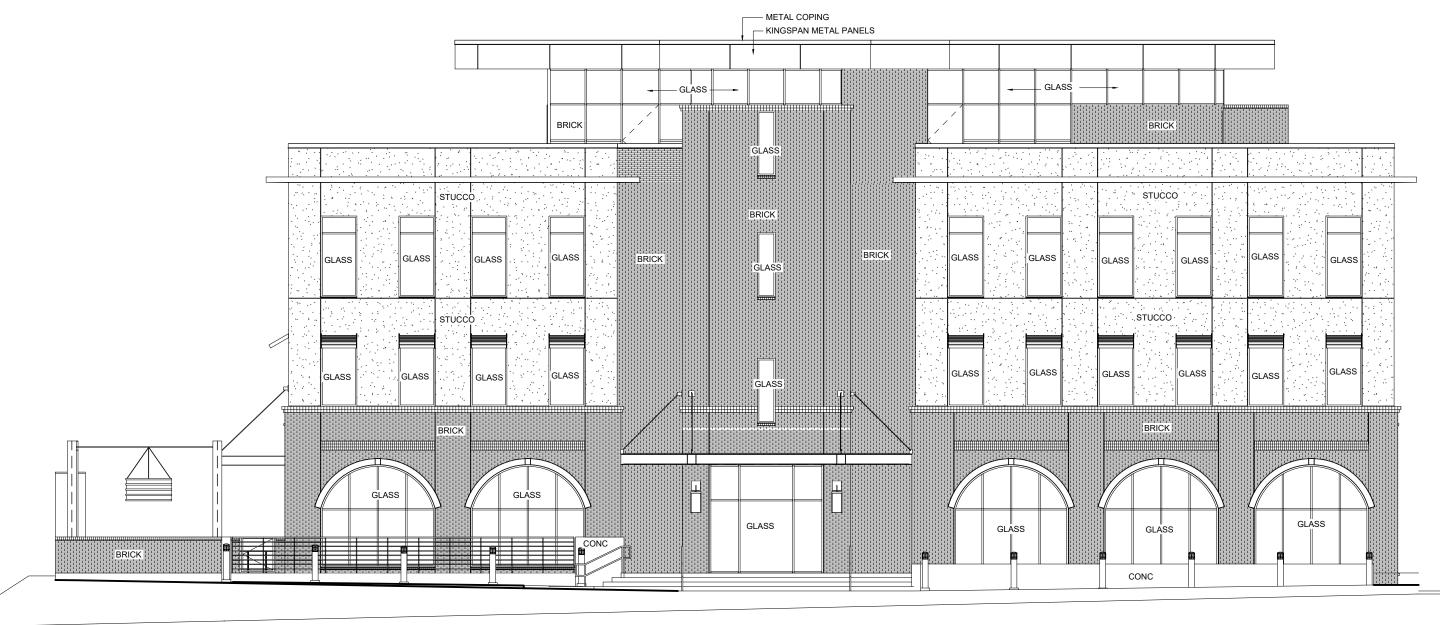

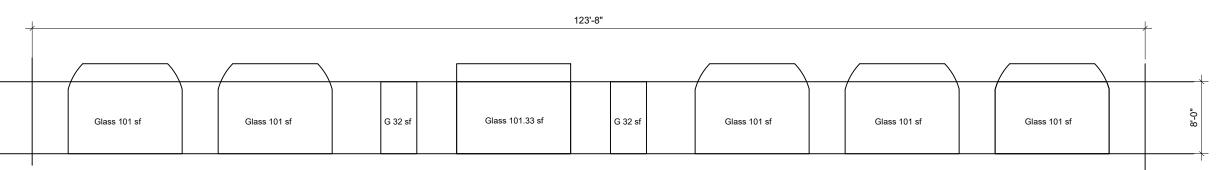TOTAL AREA 989 SF TOTAL GLASS (WITH ROUND GLASS IN LAST BAY) = 637.74 S.F. PERCENTAGE TRANSPARENCY 637.74 / 989 = 64.48 %

TOTAL GLASS (WITH LAST BAY) = 670.33 S.F. PERCENTAGE TRANSPARENCY 670.33 / 989 = 67.7 % > 65 %


TOTAL GLASS FIRST FLOOR FACADE



TOTAL AREA 989 SF TOTAL GLASS (WITHOUT LAST BAY) = 726.2 S.F. PERCENTAGE TRANSPARENCY 726.2 / 989 = 73.4 %

TOTAL GLASS (WITH LAST BAY) = 794.61 S.F. PERCENTAGE TRANSPARENCY 794.61 / 989 = 80.3 %

PERCENTAGE OF TRANSPARENY @ FIRST FLOOR AT LEAST 65%

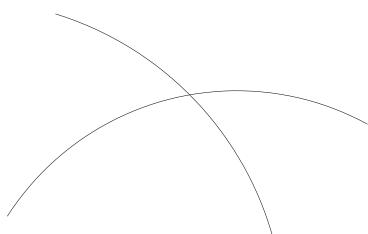

David Martini - Plank ARCHITECT

PROJECT TEAM:

GENERAL CONTRACTOR Kearey Builders Ryan Kearey 2915 Charlotte Highway Mooresville, NC 28117 980-444-6510

ARCHITECT OF RECORD David Martini - Plank, AIA NC Registration: 5453

143 Village View Drive - Suite 203 Mooresville, NC 28117 704-777-4447 dmartiniplank@gmail.com

Architecture Interiors Master Planning Development

PROJECT


DAVIDSON GATEWAY CENTER 635 DAVIDSON GATEWAY DRIVE DAVIDSON NC 28036

Issue Date:

07/31/19

MA-102-00

EAST ELEVATION

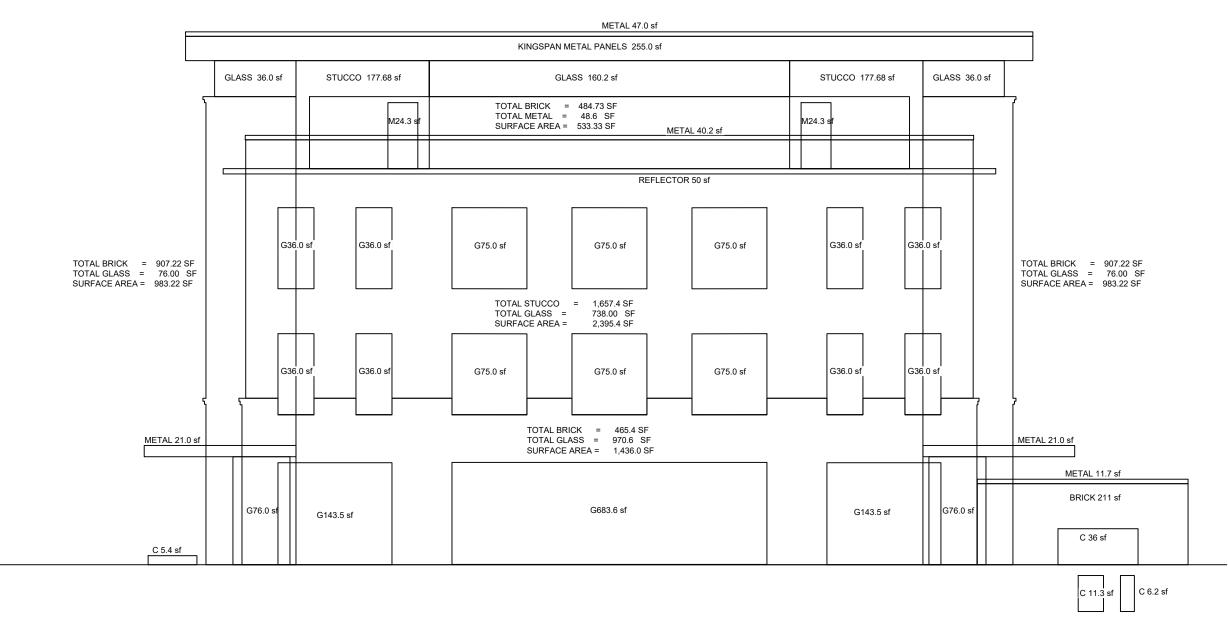

TOTAL OTHER MATERIALS = 5,878.97 SF TOTAL STUCCO AREA = 2,012.76 S.F.


TOTAL STUCCO AREA = 2,012.76 S.F.


TOTAL SURFACE AREA = 7,891.73 SF


Max. STUCCO AREA (req) 7,891 x 0.25 = 1,972.75 SF

PERCENTAGE STUCCO 2,012.76 / 7,891 = 25.5%

PERCENTAGE OF STUCCO @ FACADE

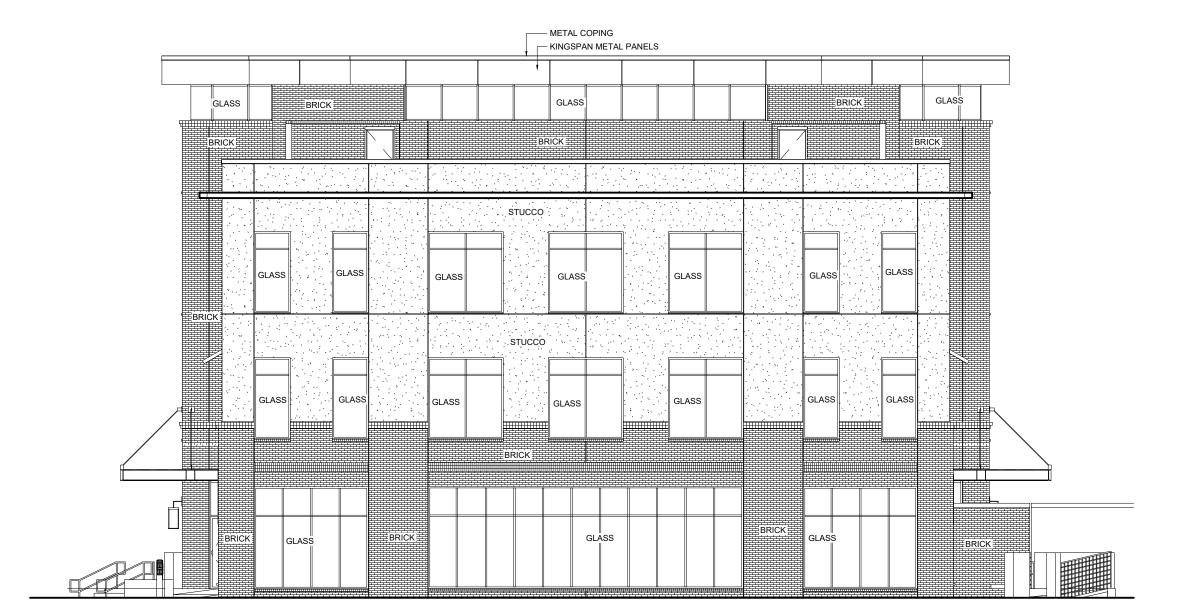

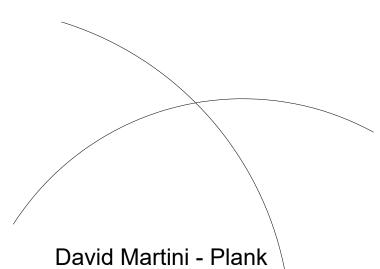

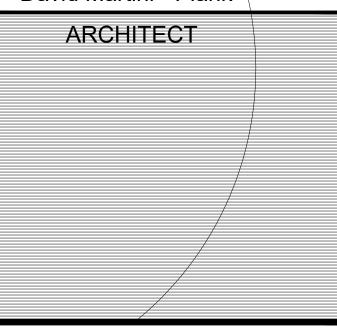

PROJECT TEAM:

GENERAL CONTRACTOR

Kearey Builders Ryan Kearey 2915 Charlotte Highway Mooresville, NC 28117 980-444-6510

ARCHITECT OF RECORD

David Martini - Plank, AIA NC Registration : 5453

143 Village View Drive - Suite 203 Mooresville, NC 28117 704-777-4447 dmartiniplank@gmail.com

Architecture Interiors Master Planning Development

PROJECT

DAVIDSON GATEWAY CENTER 635 DAVIDSON GATEWAY DRIVE DAVIDSON NC 28036

Issue Date:


FYI SUBMISSION

NORTH ELEVATION


07/31/19


MA-103-00 SHEET:


Page 33 of 69

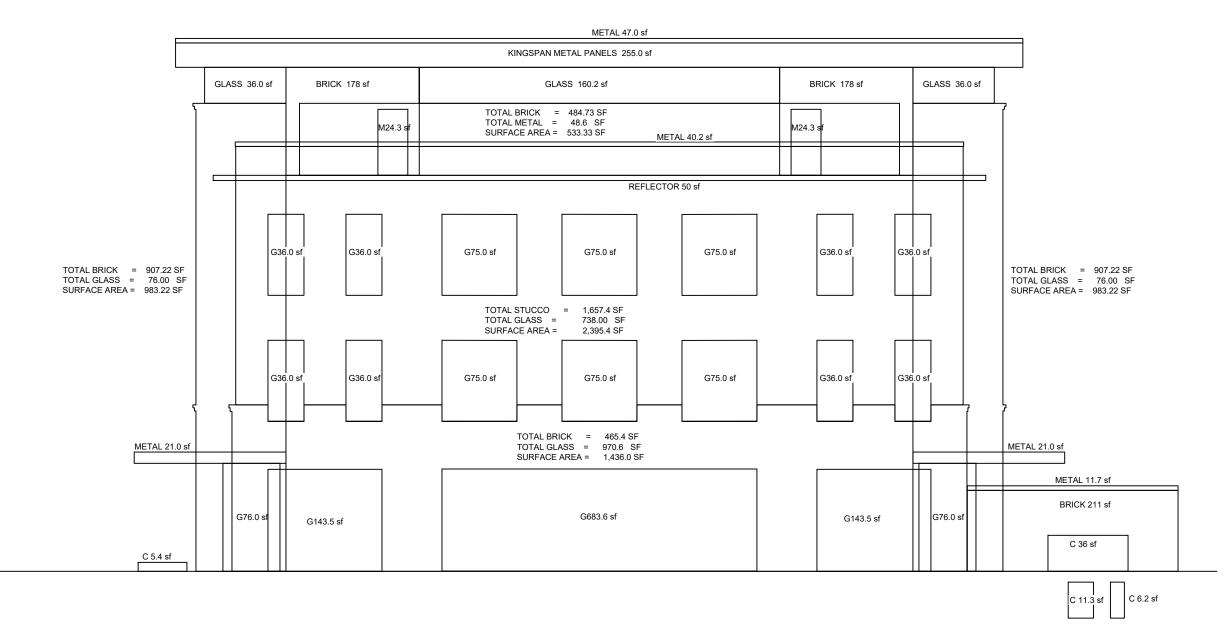

PERCENTAGE OF STUCCO @ FACADE

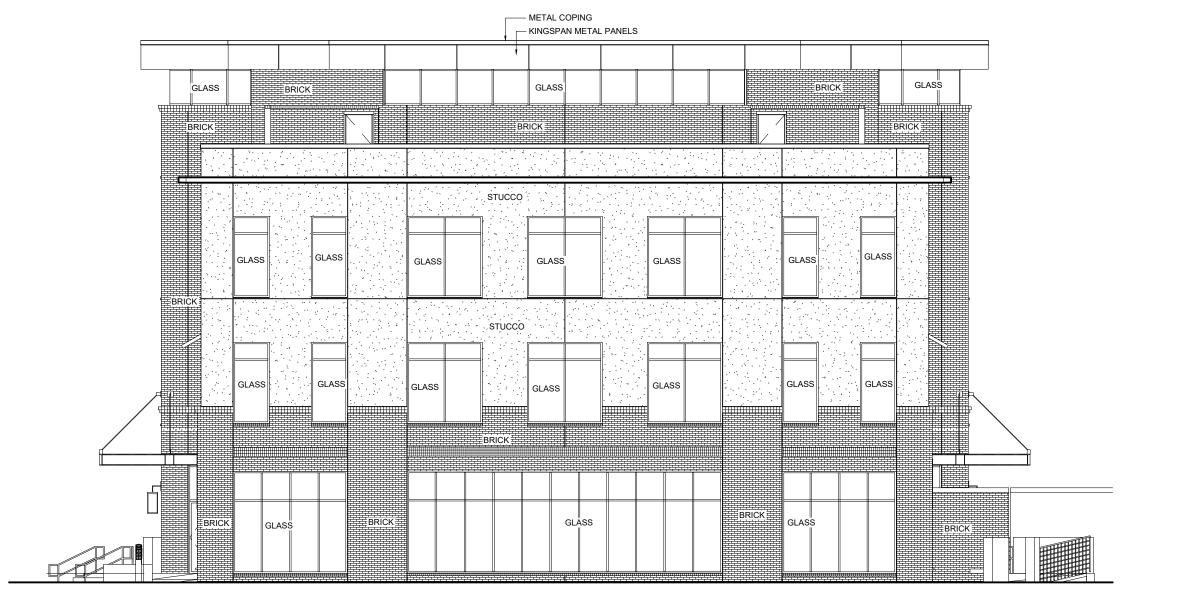

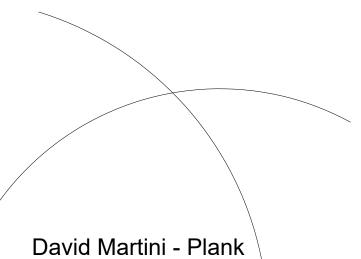

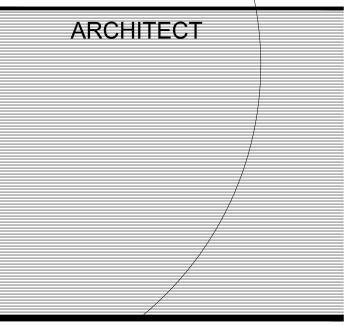

PROJECT TEAM:

GENERAL CONTRACTOR

Kearey Builders
Ryan Kearey
2915 Charlotte Highway
Mooresville, NC 28117 980-444-6510

ARCHITECT OF RECORD

David Martini - Plank, AIA NC Registration : 5453

143 Village View Drive - Suite 203 Mooresville, NC 28117 704-777-4447 dmartiniplank@gmail.com

Architecture Interiors Master Planning Development

PROJECT

DAVIDSON GATEWAY CENTER 635 DAVIDSON GATEWAY DRIVE **DAVIDSON NC 28036**

Issue Date:


CORRECTED DRB SUBMISSION

07/31/19

NORTH ELEVATION


MA-103-00 SHEET:

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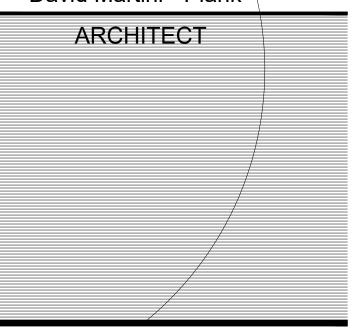


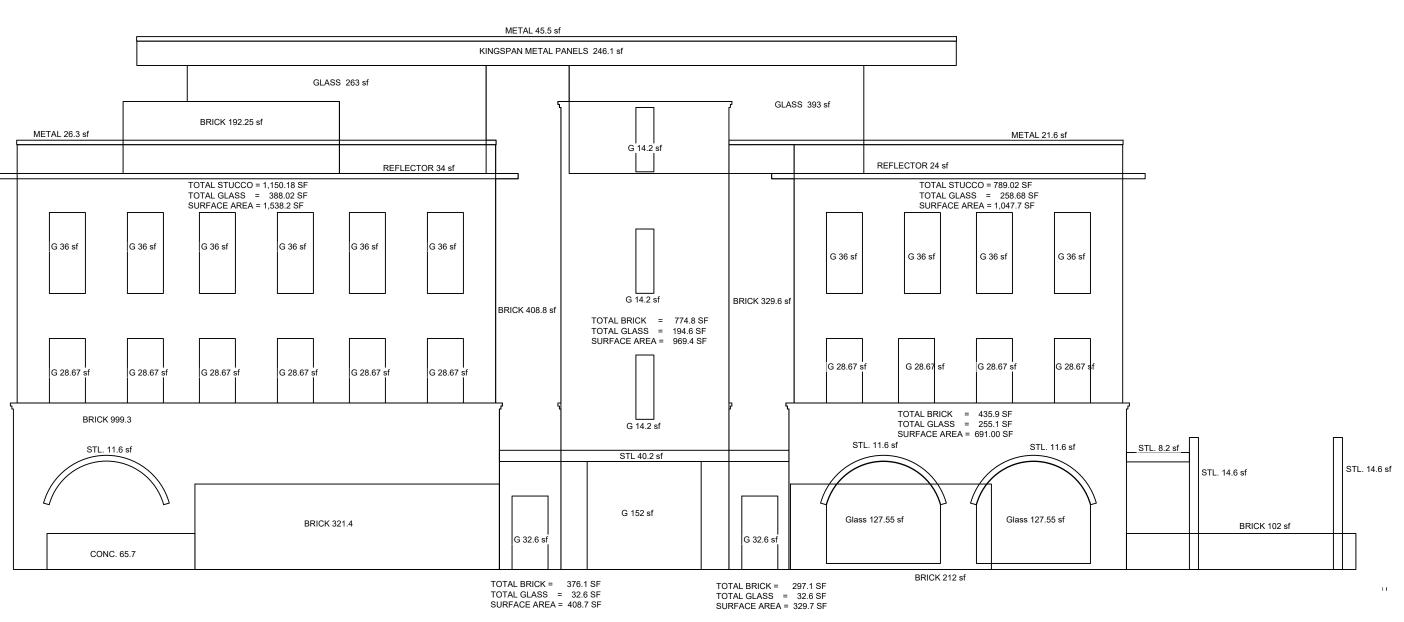

PERCENTAGE OF STUCCO @ FACADE NOT GREATER THAN 25 %

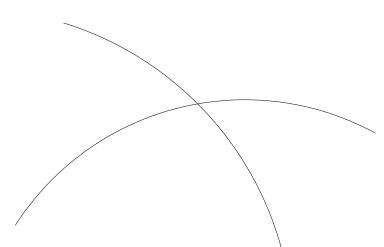

David Martini - Plank



PROJECT TEAM:

GENERAL CONTRACTOR

Kearey Builders Ryan Kearey 2915 Charlotte Highway Mooresville, NC 28117 980-444-6510

ARCHITECT OF RECORD

David Martini - Plank, AIA

NC Registration: 5453

143 Village View Drive - Suite 203 Mooresville, NC 28117 704-777-4447 dmartiniplank@gmail.com

Architecture Interiors Master Planning Development

PROJECT

DAVIDSON GATEWAY CENTER 635 DAVIDSON GATEWAY DRIVE DAVIDSON NC 28036

Sea

Issue Date:

07/31/19

WEST ELEVATION

MA-104-00 SHEET:



IMAGE FROM DAVIDSON HUB

SIMILAR FOR DAVIDSON GATEWAY CENTER

- BLACK STEEL
- BLACK ANODIZED STOREFRONT SYSTEM
- LIGHTLY GREY TINTED GLAZINGBLACK PAINTED HANDRAILS

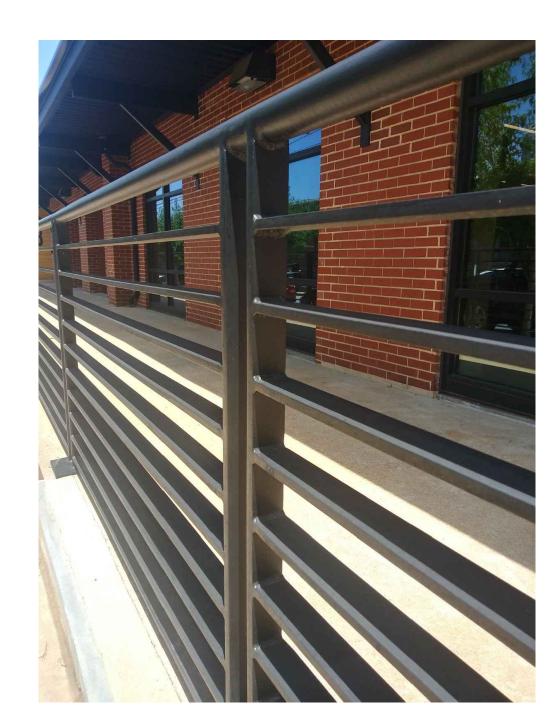


IMAGE FROM DAVIDSON HUB

SIMILAR FOR DAVIDSON GATEWAY CENTER

BLACK PAINTED HANDRAILS

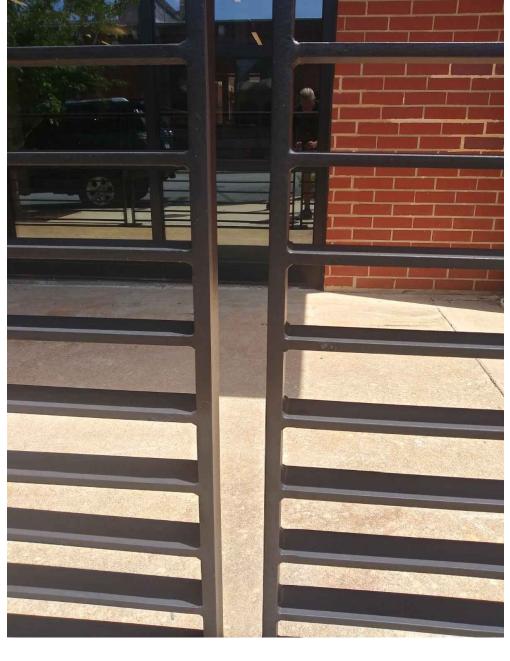


IMAGE FROM DAVIDSON HUB

SIMILAR FOR DAVIDSON GATEWAY CENTER

• BLACK PAINTED HANDRAILS WITH BIKE WHEEL SLOT AT NEW FRONT PLAZA.



IMAGE FROM DAVIDSON HUB

SIMILAR FOR DAVIDSON GATEWAY CENTER

- ALL STUCCO AT 2nd, 3rd & 4th FLOORS TO BE LIGHT GREY MATCHING DAVIDSON HUB.
- ALL WINDOWS AND STOREFRONT SYSTEMS TO BE BLACK ANODIZED ALUM. FRAMES.

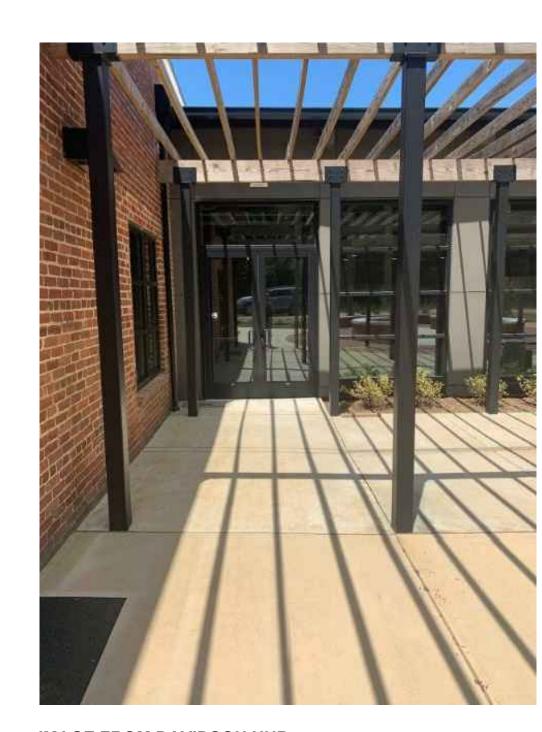


IMAGE FROM DAVIDSON HUB

SIMILAR FOR DAVIDSON GATEWAY CENTER

- ALL STUCCO AT 2nd, 3rd & 4th FLOORS TO BE LIGHT GREY MATCHING DAVIDSON HUB.
- ALL DOORS AND STOREFRONT SYSTEMS TO BE BLACK ANODIZED ALUM. FRAMES.



IMAGE FROM DAVIDSON HUB

SIMILAR FOR DAVIDSON GATEWAY CENTER

 ALL STUCCO AT 2nd, 3rd & 4th FLOORS TO BE LIGHT GREY MATCHING DAVIDSON HUB.


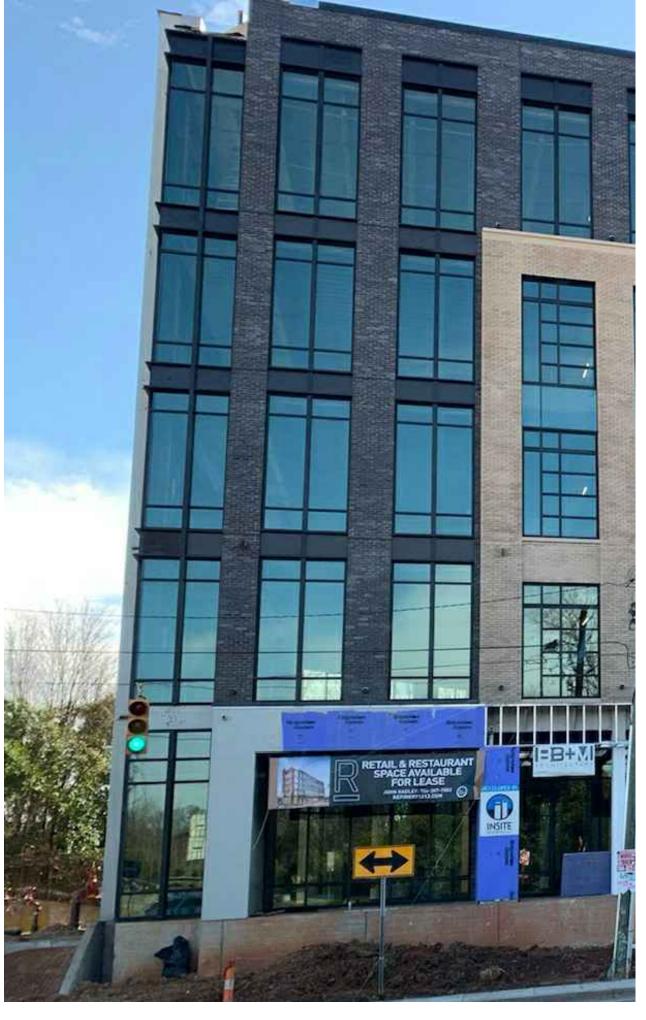


IMAGE FROM MOOREHEAD STREET BLDG.

SIMILAR FOR DAVIDSON GATEWAY CENTER

- ALL BRICK AT 1st. FLOOR, STAIR TOWERS, AND SITE TO BE DARK GREY BRICK WITH LIGHT GREY MORTAR.
- VERTICAL INFILL BRICK BETWEEN STAIR TOWERS FROM 1st FLOOR TO 4th FLOOR AND ENTIRE EVENT LEVEL TO BE CREAM COLOR BRICK TO COMPLIMENT GREY BRICK.

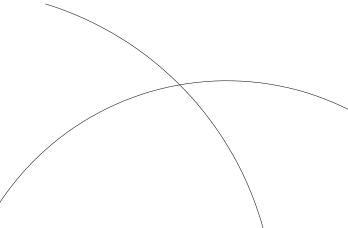

David Martini - Plank

ARCHITECT ARCHITECT

PROJECT TEAM:

GENERAL CONTRACTOR

Kearey Builders Ryan Kearey 2915 Charlotte Highway Mooresville, NC 28117 980-444-6510

ARCHITECT OF RECORD

David Martini - Plank, AIA NC Registration : 5453

143 Village View Drive - Suite 203 Mooresville, NC 28117 704-777-4447 dmartiniplank@gmail.com

Architecture Interiors Master Planning Development

PROJECT

DAVIDSON GATEWAY CENTER 635 DAVIDSON GATEWAY DRIVE DAVIDSON NC 28036

Seal:

Issue Date:

07/31/19

EXTERIOR MATERIAL FINISHES

MA-105-00 SHEET:





Crystal Lighting Corp. 13182 Flores St, Santa Fe Spring, CA 90670 Ph: 562-944-0223 Fax: 562-944-0225 www.crystallighting.us
All products are proudly manufactured and/or assembled in the USA

Malibu Series Architectural LED Bollard



Extruded Aluminum Housing with flush Mounting Base and Vandal-Resistant Screws, Powder coat Finish, Internal Ballast Tray for Easy Maintenance. Clear Polycarbonate Lens (Standard). 3/8 x 10" Long Anchor Bolts (Included). LED Array Optional 15W, 20W and 35 System. Ideal for lighting pedestrian walkways and accenting the exterior grounds of office and apartment buildings, hotel and parks. Comes with a 10 year warranty

FEACTURES

- Energy Savings: Over 66% compared to HID light sources.
- Improved lumen maintenance
- Utilizes high efficient LED's
- Operating temperatures: -30°C ~ 60°C.
- Driver: Constant current, 120~277v, 50/60Hz, 480v (Optional)
- Suitable for wet locations.
- Dimming, occupancy sensors, photo cell and wireless controls capable (optional).
- Operating Life: >200,000 hours.

CONSTRUCTION

- Extruded aluminum body with die-cast aluminum louvers.
- Powder coat bronze finish (standard) various colors available (custom).
- Clear polycarbonate lens (standard).
- Silicone gasket to prevent leakage and provide weather-tight
- Mounting: Mounting kit with 10" anchor bolts included

















CAT#	DIA.	HEIGHT	TOPS	WATTAGE	DRIVER	ССТ	COLOR	OPTIONS
Malibu Series (MLB)	8" OD (8OD) 6" OD (6OD)	42" (42) 36" (36) 24" (24)	DOME TOP (DT) FLAT TOP (FT) CONE TOP (CT)	15W - 1376Lms (10) 20W - 2752Lms (20) 30W -4128Lms (30)	120V/277V (UNV) 480V (48)	3000K (3K) 4000K (4K) 5000K (5K)	BLACK (BLK) WHITE (WH) BRONZE (BRZ) SILVER (SIL) MARINE GRADE (MG)	PHOTOCELL (PC) 180° SIDE SHIELD (HSS) VANDAL RESISTANT BASE (VRB)

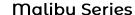


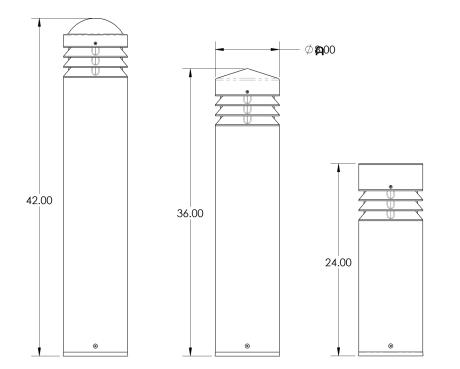

Dimensions						
CAT#	А	В				
MLB-42	6"	42"				
MLB-36	or	36"				
MLB-24	8"	24"				

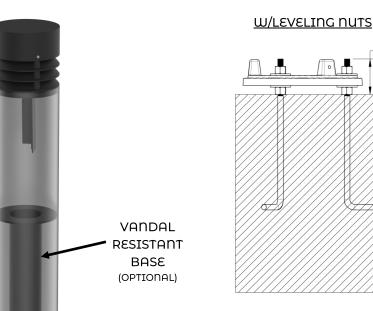

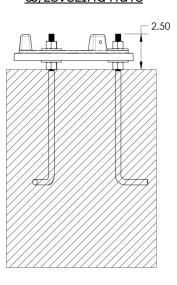

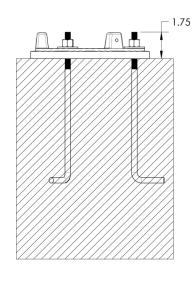


W/OUT LEVELING NUTS

MODEL#	INPUT POWER	LUMEN OUTPUT	LP/W	COLOR TEMP. (CCT)	CRI	RATED LIFE (L70)	INPUT VOLTAGE	INPUT FREQUENCY
MLB-15CLED	15W	2,250	150	5000K	70+	>200,000	120-277V	50/60HZ
MLB-20CLED	20W	2950	147	5000K	70+	>200,000	120-277V	50/60HZ
 MLB-30CLED	30W	3950	131	5000K	70+	>200,000	120-277V	50/60HZ

Crystal Lighting Corporation 13182 Flores st. Santa Fe Springs CA 90670 Phone: 562-944-0223 Fax: 562-944-0225 WEB: www.crystallighting.us Email: robert@crystallighting.us



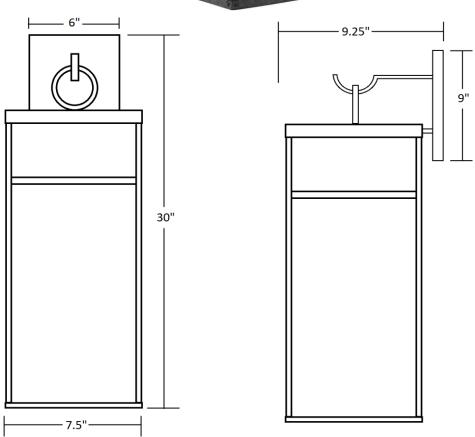

PROJECT NAME:	TYPE:	UL LISTED SUITABLE FOR: WET LOCATION	CATALOG # CLA-20-MOD-INC-BLK	
	DATE:	LAMPING:	DIMENSION	S:
CUSTOMER OR REP:	8/28/2019	1 MED BASE SOCKET	30" HIG	H X 7.5" W X 9.25" EXT.
	DRAWING BY:	STYLE:	FINISH:	POWDERCOAT
APPROVED BY:	Robert Naranjo	WALL MOUNT	LENS:	CLEAR ACRYLIC
	Any & all information appe	aring here is propriety & confidential. It may not	MATERIAL:	aluminum
be used without prior authorization of: CRYSTAL LIGHTING CORPORATION				120V Page 39 of 69

Trogon Collection

Diecast LED Brick Lights

ELCO's Trogon Collection consists of diecast wet location LED Brick Lights which are offered in 5.4W or 12W, 3000K, 120V with an Angled Louver, Open Frame Lens or Grill Faceplate in a sharp White, Black or Bronze powder coated finish.




INTEGRATED LED



WET LOCATION



90+ CR

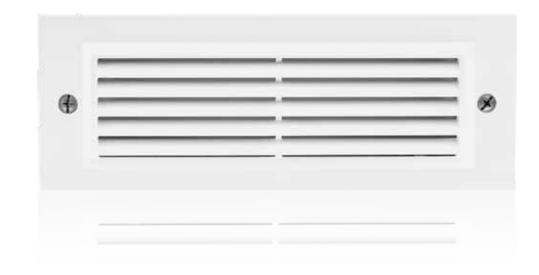


Trogon Collection

LED Brick Lights





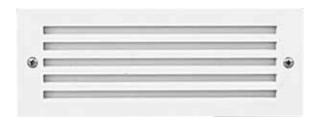



LED Brick Light with Angled Louver

- Diecast aluminum housing and faceplate
- Integrated LED board and driver
- · Diffused glass lens behind louver
- Wet Location listed for indoor or outdoor use
- UL Listed for poured concrete
- UL Listed for direct contact with insulation (type IC)
- Housing equipped with (2) side brackets and (2) ½" knockouts for easy wiring
- Life span of 35,000 hours L70

Input Power	5.4W
Lumens	340
Color Temp.	3000K
CRI	90+
Input Volt	120V
Wet Location	UL listed






LED Brick Light with Grill Faceplate

- Diecast aluminum housing and faceplate
- Integrated LED board and driver
- Diffused glass lens behind grill
- Wet Location listed for indoor or outdoor use
- UL Listed for poured concrete
- UL Listed for direct contact with insulation (type IC)
- Housing equipped with (2) side brackets and (2) ½" knockouts for easy wiring
- Life span of 35,000 hours L70

Input Power	5.4W
Lumens	340
Color Temp.	3000K
CRI	90+
Input Volt	120V
Wet Location	UL listed



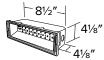



Product Introduction


- 1. Patent owned design, fashion and beautiful appearance, adopt isolated two bodies design could have the separate heat dissipation fully ensure the stability and long lifespan of LED light.
- 2. With multiway rotate function of round support or "U" support available to meet the various occasions demands for outdoor projects.
- 3. Light body adopts high pressure die-casting aluminum, surface with electrostatic plastic coating. Lampshade adopts high strength toughened glass, resist the impact and friction.
- 4. Adopt American CREE original LED light source, high flus output, excellent consistency of light color; Constant current driver with PWM gray control installed inside, RGB gray level reaches to 65,536 degree equally, make the light result much beautiful.
- 5. Powerful DMX512 interface adopts high reliable bus connect, all has the function of automatic addressing.


Specification

Page 42 of 69

3000K


Product Code Led品牌/	SL1132FE-25	SL1132FD-25	SL1132FF-24	SL1132FC-72
Led Brand	CREE XP-L	CREE XP-G3	CREE RGBW 4 in1	CREE XP-E2
Led Quantity	25pcs	25pcs	24pcs	72pcs
Rared Power	120W	85W	150W/200W	150W
Input Voltage	AC100-305V	AC100-305V	DC36V / AC100-3	305V
Frequency Range	50/60Hz	50/60Hz	50/60Hz	50/60Hz
Color	Single	Single	RGBW	RGB
Beam Rangle #	2.6° 3.5° 12° 20° 30	0° 60° 10X70° 5X20	15° 20° 30° 15X60°	15° 10° 12.5° 15X60°
Control Mode	CC/DALI/0-10V	CC/DALI/0-10V	DMX512/RDM	DMX512/RDM
Life	50000H	50000H	50000H	50000H
Protection Grade	IP66	IP66	IP66	IP66
Ambient Temperature	–25℃∽50℃	–25℃∽50℃	–25℃∽50℃	–25℃∽50℃
Ambient Humidity	10%∽90%	10%∽90%	10%∽90%	10%∽90%

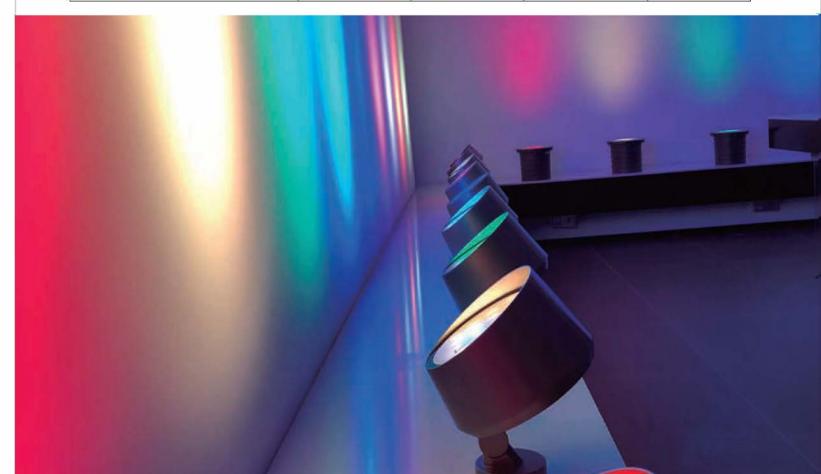

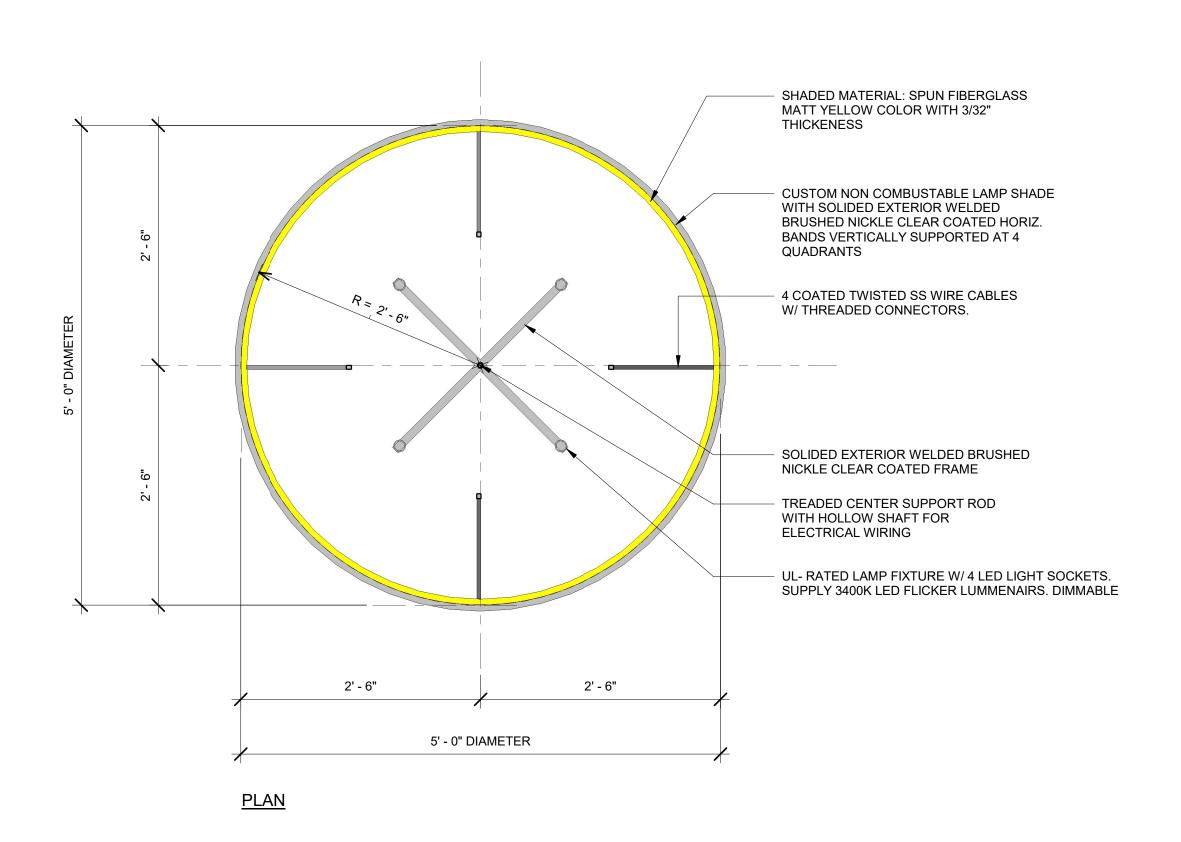

ELEVATION

LIGHT AND SHADE TO BE MANUFACTURED BY CRYSTAL LIGHTING, LLC

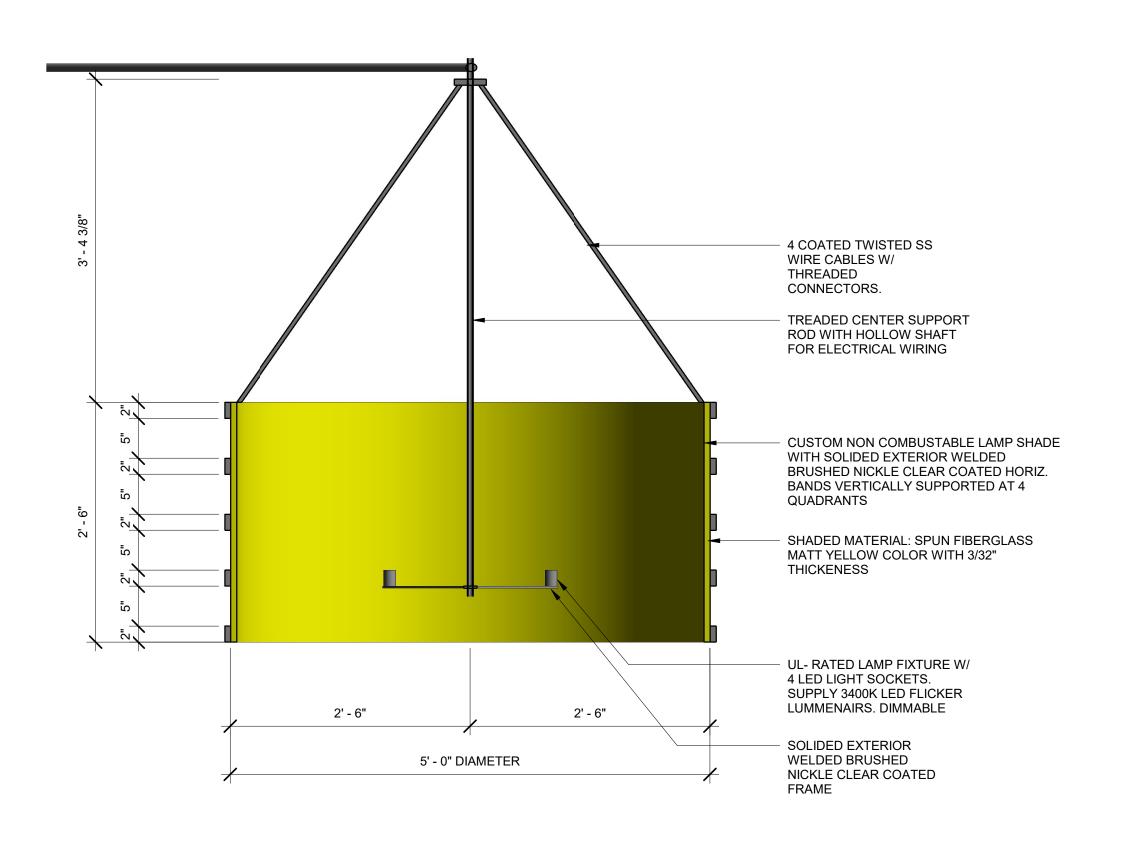




1" = 1'-0"

2 ISOMETRIC

Page 43 of 69

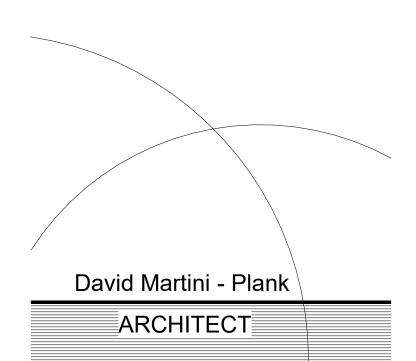

PROJECT TEAM:
ARCHITECT OF RECORD

David Martini - Plank, AIA
NC Registration: 5453
143 Village View Drive - Suite 203
Mooresville, NC 28117
704-777-4447
dmartiniplank@gmail.com
Architecture

Development

GENERAL CONTRACTOR
Kearey Builders
Ryan Kearey
2915 Charlotte Highway
Mooresville, NC 28117
980-444-6510

Interiors

Master Planning



<u>PROJEC</u>

DAVIDSON GATEWAY CENTER 635 DAVIDSON GATEWAY DRIVE DAVIDSON NC 28036

Seal:


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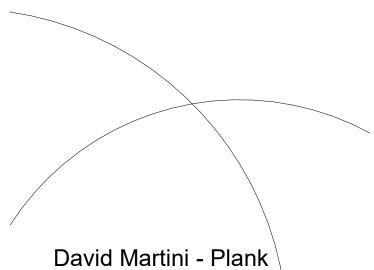
GRAND PATIO LIGHT

08/12/19

LS-100.00

SHEET:



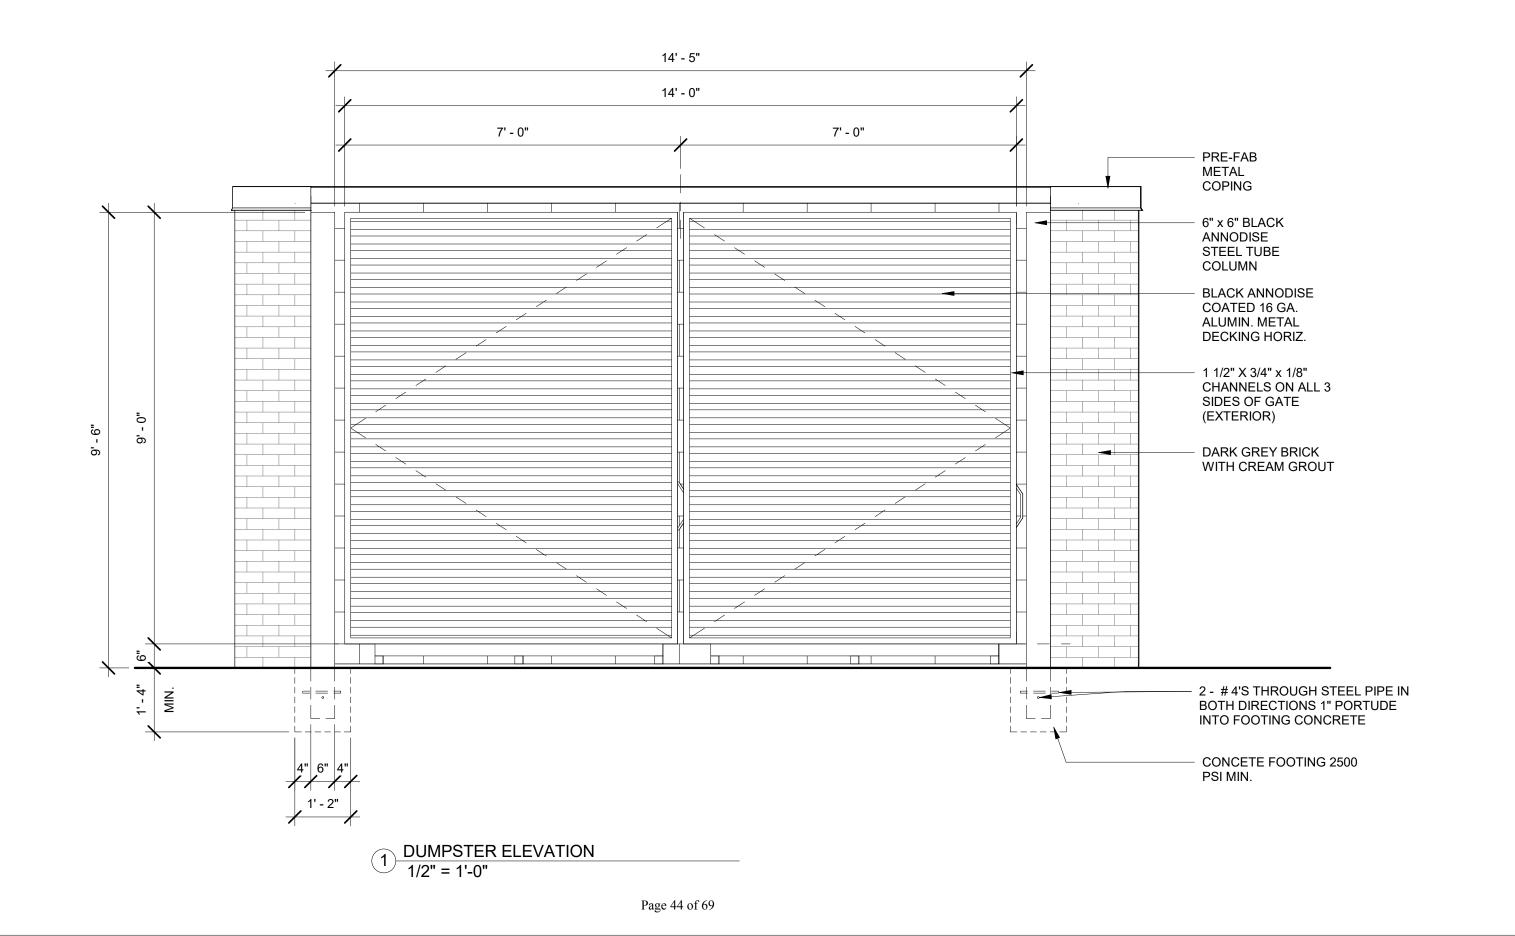

ARCHITECT

PROJECT TEAM: ARCHITECT OF RECORD David Martini - Plank, AIA NC Registration : 5453 143 Village View Drive - Suite 203 Mooresville, NC 28117 704-777-4447 dmartiniplank@gmail.com Architecture Interiors Master Planning Development

GENERAL CONTRACTOR
Kearey Builders
Ryan Kearey
2915 Charlotte Highway
Mooresville, NC 28117
980-444-6510



<u>PROJECT</u>

DAVIDSON GATEWAY CENTER 635 DAVIDSON GATEWAY DRIVE DAVIDSON NC 28036

Issue Date:

08/12/19

DUMPSTER DETAILS

A-440-00

SHEET:

Davidson Gateway Building – Proposed Renderings 9/18/19

1. Proposed Building (front view)



2. Proposed Building (front/angled view)



3. Proposed Building (roof top view)



4. Patio Fireplace View





Agenda Title: Davidson Green School Addition FYI

Summary:

ATTACHMENTS:

Description Upload Date Type

Davidson Green School Addition 9/6/2019 Exhibit

Town of Davidson, NC Design Review Board: Staff Analysis for FYI Review September 18, 2019

Project: Davidson Green School Addition FYI

Location: 511 South Main Street (Parcel ID 00705101)

Applicant: Jennifer Jakubecy

Designer: Labella

Planning Area: Village Infill (Purple Overlay)

This project is being presented as an FYI. The applicant proposes an addition off the western side of the existing principle structure located at 511 South Main Street. The building addition will be used for classroom/storage space. The addition will include a basement (+/-777 SF), first floor (+/-809 SF), and second floor (+/-694 SF). Design and colors of the addition will be in character with the principle structure and will mimic existing materials as much as possible. Materials include CMUs painted to match existing, hardi plank siding, stained wooden columns, and architectural shingles.

DAVIDSON PLANNING ORDINANCE:

Section 3.2.17 Elementary and Secondary School (Additional Requirements)

1. All principal structures, whether new construction or adaptive reuse shall meet the standards for institutional buildings set forth in Section 4.

Section 4.3.2 Guidelines for Development or Redevelopment in Existing Buildings

This section is intended to ensure the compatibility of infill development and redevelopment to surrounding neighborhoods and shall apply to new construction and the expansion of existing buildings. As a means to provide guidance for the design of buildings that integrate well into the context of Davidson, this section identifies the following key features necessary to ensure compatibility. When developing in the Village Infill Planning Area, in addition to the standards below, see Section 2 for development in the Village Infill Overlay District.

- A. Street Frontage: Street trees should be preserved
- **B. Rhythm of Development along the Street:** Established building rhythms along street frontages should be continues. Larger buildings can be integrated into smaller-scale neighborhoods by creating repetitive bays with façade articulation.
- **C. Building Orientation:** Main entrances, and other primary building façade elements should be oriented toward the street. Courtyard buildings should orient main entrances toward courtyards that open to the street and serve as a semi-public extension of the public realm.
- **D. Front Setback Patterns:** Established building setback patterns should be continued as practical. Deep front setbacks can compromise the pedestrian realm.

- **E. Building Form:** Massing, proportion, scale, setbacks, spaces between buildings, and their relative positions should be used to integrate new development into existing streetscapes.
- **F. Density:** Density should increase closer to mixed use and commercial nodes.
- **G. Building Design:** Buildings should be designed to respect the existing built environment, but not be explicit reproduction of past historical styles.

Section 4.4.1 Design Standards

E. Materials

- 1. Materials shall be selected for suitability to the type of building and design for which they are used.
- 2. Piecemeal embellishment and frequent changes in material should be avoided.
- 3. All sides of the building should use materials consistent with those on the front if visible from public streets or neighboring properties, and should be carefully designed with similar detailing, comparable quality, and compatible materials.
- 4. Building materials and colors shall be:
 - a. Complementary to the materials already being used in the neighborhood, or
 - b. If dissimilar materials are being proposed, other characteristics such as scale, proportion, form, architectural detailing, color, and texture shall be used to ensure that the building relates to the rest of the neighborhood.

F. Architectural Details

- Windows and door openings shall be arranged and proportioned so that vertical dimensions dominate horizontal dimensions. To the extent possible, upper story windows shall be vertically aligned with the location of windows and doors on the ground level, including storefront or display windows.
- 6. The main entry to a building should be emphasized at the street level. Appropriate methods include, but are not limited to:
 - a. Recessing the door within a larger cased opening.
 - b. Flanking the door with columns, decorative fixtures or other details.
 - c. An awning or canopy, providing a sheltered transition to the interior

Section 4.5.1 Institutional Building Type

Institutional buildings are typically used for public or semi-public purposes. These buildings must be designed appropriately to fit within neighborhoods as integral parts of the community. Institutional buildings serve as places of assembly. They have a sense of prominence within their respective neighborhoods. Their uses may include churches, libraries, post offices, and schools. All institutional buildings are subject to the Individual Building process and Design Review Board approval.


- A. The scale and architectural sophistication of these buildings should support their civic importance and complement Davidson's existing civic buildings.
- B. Complexes with multiple institutional buildings should arrange the buildings to front the streets or to frame common open space and amenities.



Davidson Green School Addition (Name of Project)

Development Process

Date Completed		Outline of Steps & Checklist		
Date completed				
		1. Initial Meeting		
		2. Application and Fee		
		3. Design Review Board Preliminary Review (Informational)		
		4. Planning Director Site Schematic Design Review		
		5. Design Review Board Approval		
		6. Building Construction Documents		
		7. Site and Landscape Construction Documents		
		8. Architect's Letter of Verification (Construction Documents)		
		9. Building Permit Approval		
		10. CD Submittal with PDF of All Approved Documents Required within 45 Days of Approval		
		11. Architect's Letter of Verification (Construction/As-Built)		
		12. Certificate of Occupancy		
* For further information see Davidson Planning Ordinance Sections 14.11 Individual Building - 14.12 Design Review. Note that the Town of Davidson encourages all paper submittals to be on 30% or greater recycled paper.				

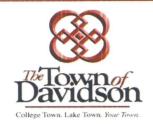

Davidson Green School Addition (Name of Project)

Application Requirements

Date Received						
2400110001104						
	Ш	Application Fee per Town of Davidson Fee Schedule				
		Contact Information				
		General Statement of Intent (Use, building type, approx. square footage, height, design features)				
		Statement of Compliance with Section 2				
		Master Plan or Conditional Planning Area (Including all documents, plans, maps, and conditions of approval)				
		Environmental Inventory in accordance with Section 14.15.1 (Including adjacent properties and buildings)				
		General Description (Including a description and color photographs to existing / adjacent site)				
		Site Schematic Design in accordance with Section 14.15.7				
		Building Schematic Design in accordance with Section 14.15.3 (Including rendered elevations of each façade per 14.15.3 C)				
		Landscape Schematic Design in accordance with Section 14.15.5				
		Building Perspective				
		Building Materials/Colors (Roofing, siding, doors, windows, etc.)				
As the applicant, I hereby confirm that all the required materials for this application are						
autne	ritic and no	ave been submitted to the Town of Davidson Planning Department.				
	8/14/19					
0	Applicant's Signature Date					



Davidson Green School Addition (Name of Project)

Contact Information

	Applicant's Information
Name:	Jennifer Jakubecy
E-Mail:	Jennifer@Davidsongreenschool.org
Mailing Address:	511 S. Main Street
	Davidson NC 28036
Business Phone:	Mobile Phone: 540-273-1000
	Property Owner's Information (If Different from Applicant)
Name:	Jennifer Jakubery & Jill Jacobson
E-Mail:	Jennifer@ Davidsongreenschool.org
Mailing Address:	310 South Street
	Davidson NC 28036
Business Phone:	Mobile Phone: <u>540-273-10</u> 00
	Architect's Information
Name of Firm:	LaBella
Architect's Name:	David Strange
E-Mail:	dstrange @ labellapc.com
Mailing Address:	455 S. Main St.
	Davidson, NC 28036
Business Phone:	704-941-21 Mobile Phone:



DGS Addition
(Name of Project)

Project Description

Application Date:	August 14, 2019
Project Location:	511 S. Main St., Davidson
Tax Parcel(s):	00705101
Planning Area:	Village Infill
Overlay District:	Purple
Master or Cond.Plan (Attach Conditions of Approval) Gen. Statement of Intent:	See attached.
Project Details: Project Type:	Individual Bldg. Master Plan Conditional Planning Area
• Building Type:	□ Detached House □ Townhouse □ Attached House (Tri- or Quadplex) □ Institutional □ Live/Work □ Multi-family (Apts., Condos, Flats) □ Workplace □ Storefront □ Accessory Structure
Use(s):Height & Stories:Square Footage:Building Materials:	Education
Architectural Features:	
Existing Site Conditions: See 14.12.2.D	



DGS Addition

(Name of Project)

Statement of Compliance

	а	For each category below that is applicable to the project submit a detailed nalysis describing how the project does or does not comply with the Davidson				
	Planning Ordinance and the specific regulations of each applicable section.					
	Planning Ordinance http://www.townofdavidson.org/1006/Planning-Ordinance (Includes all relevant criteria such as Planning Area, Permitted Uses & Building Types)					
	☐ s	ection 2 Planning Areas				
		Permitted Use/Add'l Req. Not Permitted				
		Permitted Building Type Not Permitted				
		Meets Setback Criteria Does Not Meet				
		Meets Open Space Criteria Does Not Meet				
		Meets Density Criteria Does Not Meet				
		ection 4 Design Standards				
		General Site Design Criteria (4.3)				
		General Building Design Criteria (4.4)				
		Specific Building Type Criteria (4.5)				
		Existing Industrial Campuses Criteria (4.6)				
		Renovation of Existing Structures Criteria (4.7)				
	Section 8 Parking & Driveways					
	Section 9 Tree Preservation, Landscaping & Screening					
	Section 10 Lighting					
		Section 22 Local Historic District Guidelines				

DRB Application Narrative

Project name: Davidson Green School Addition **Project location:** 511 S. Main Street, Davidson

General Statement of Intent:

The proposed project is to add an addition onto the principle structure. The building will be used for classroom and storage.

The project will provide space for our current activities and current number of students. We will not grow in student body. Because of our pedagogical approaches, we must maintain the small number of students and low student to teacher ratio. For example, we average 4 field trips per month, and upward of 7 overnight student trips per year. We also do the majority of our learning activities through hands-on projects. Growing in numbers would be detrimental to our mission as a school. The new structure would provide space for two of our current classes, and open up other space for a library, an art room, and makers'/engineering space.

General Description:

The addition will be in character with the principle structure as the design and colors mimics the principle structure as much as possible. More details will be in the architects' plans. Pictures of current building submitted.

We hope to start this project as soon as possible and finish before August 2020.

Statement of Compliance:

To the best of our knowledge, this project complies with the Town Ordinance in all applicable ways.


Town of Davidson

Post Office Box 579 Davidson, NC 28036 (704) 892-7591 20604

REGEIVED FR	OM Davidson	Green Ctr. 3 School	20_19
VISISh	Lev. Cw	Chk, # 1262	DOLLARS
Account Total	\$ 400.00		
Amount Paid		1 0	
Balance Due	\$	AZILAS	



Principle Building
The proposed accessory building will use the same materials and colors as the principle building.

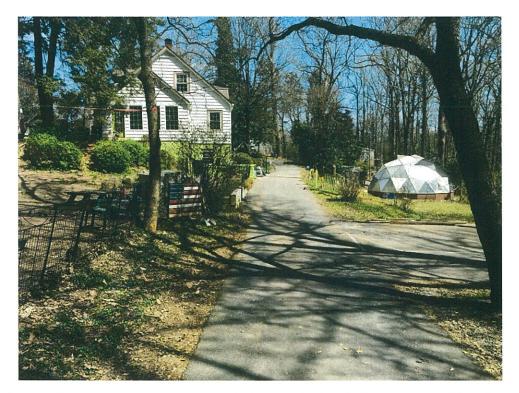

View from the driveway entrance off of Twin Oaks Road. The proposed building site cannot be seen from the public right of way.



View from the driveway exit off of S. Main Street. The proposed building site cannot be seen from the public right of way.



Current accessory building



Approximate location of proposed accessory building in relation to existing building.

DAVIDSON GREEN SCHOOL


DAVIDSON, NC








400 S. Tryon Street, Suite 1300 Charlotte, NC 28285 704-376-6423 labellapc.com

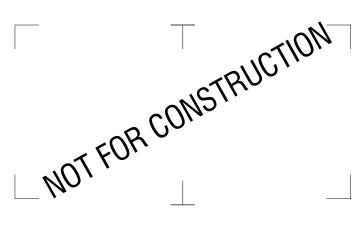

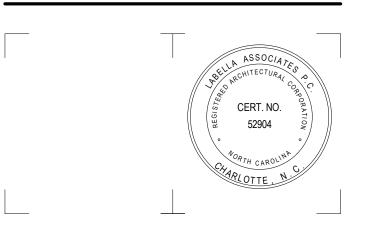

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DAVIDSON GREEN SCHOOL

511 S. Main Street Davidson, North Carolina 28036


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Revisions		
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DRAWN BY:		KRJ
REVIEWED I	BY:	REL
ISSUED FOR		ON REVIEW BOARD
DATE:		08.20.2019
DRAWING N	IAMF·	

COVER SHEET

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© 2019 LaBella Associates



DAVIDSON GREEN SCHOOL

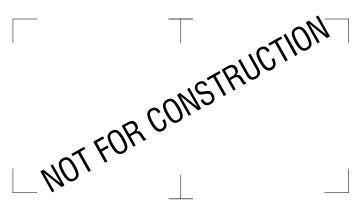511 S. Main Street Davidson, North Carolina 28036

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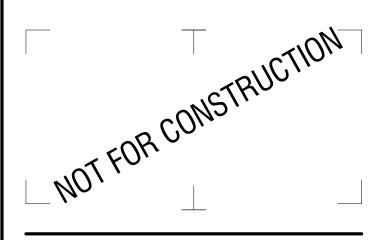
ARCHITECTURAL SITE PLAN

DRAWING NUMBER:

DRAWING NAME:

A1.0







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DAVIDSON GREEN SCHOOL


511 S. Main Street Davidson, North Carolina 28036

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Revisions			
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DRAWN BY	/ :	BAW	
REVIEWED	BY:	REL	
ISSUED FO		ON REVIEW BOAF	RD
DATE:		08.20.2019	


LOWER LEVEL FLOOR PLAN

DRAWING NUMBER:

A10

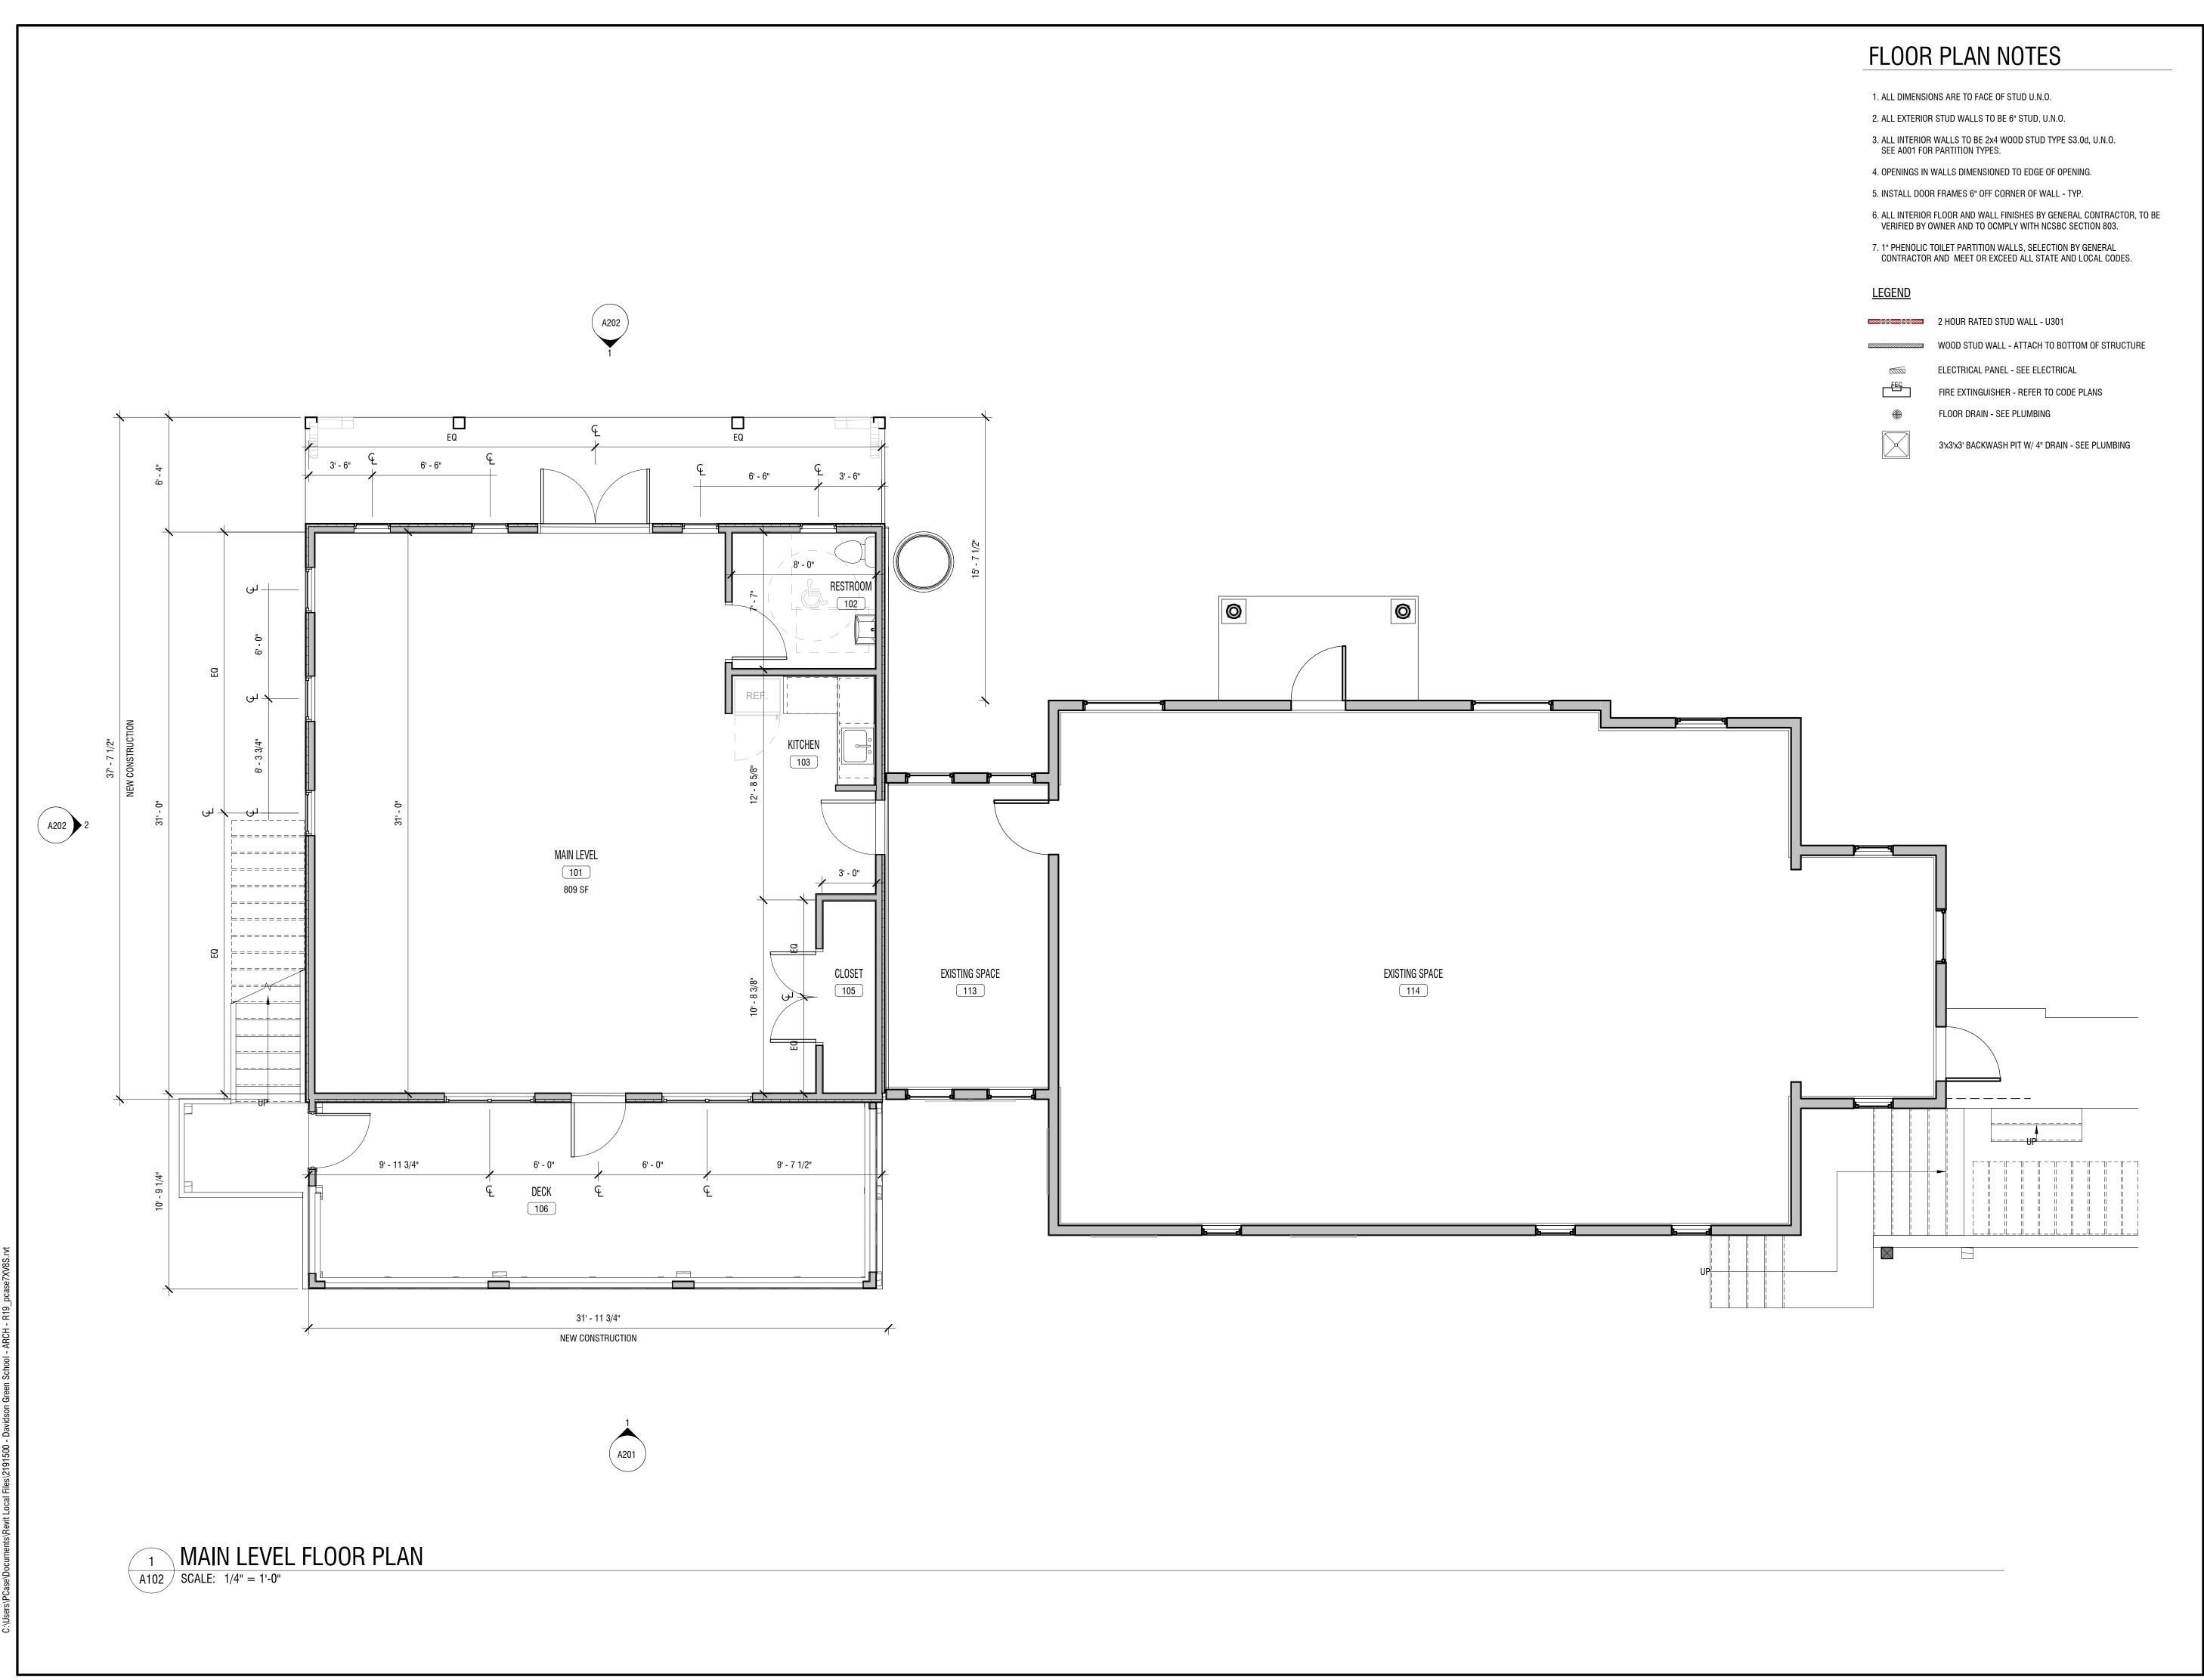



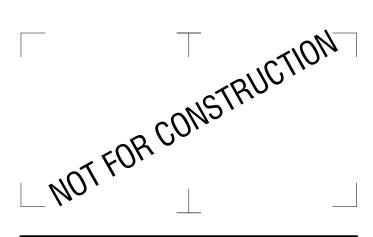



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DAVIDSON GREEN SCHOOL


511 S. Main Street Davidson, North Carolina 28036

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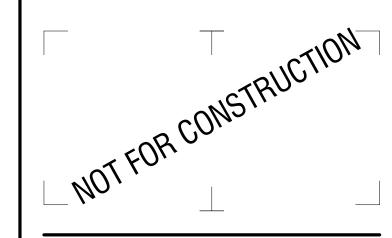
DRAWING NAME:

MAIN LEVEL FLOOR PLAN



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DAVIDSON GREEN SCHOOL

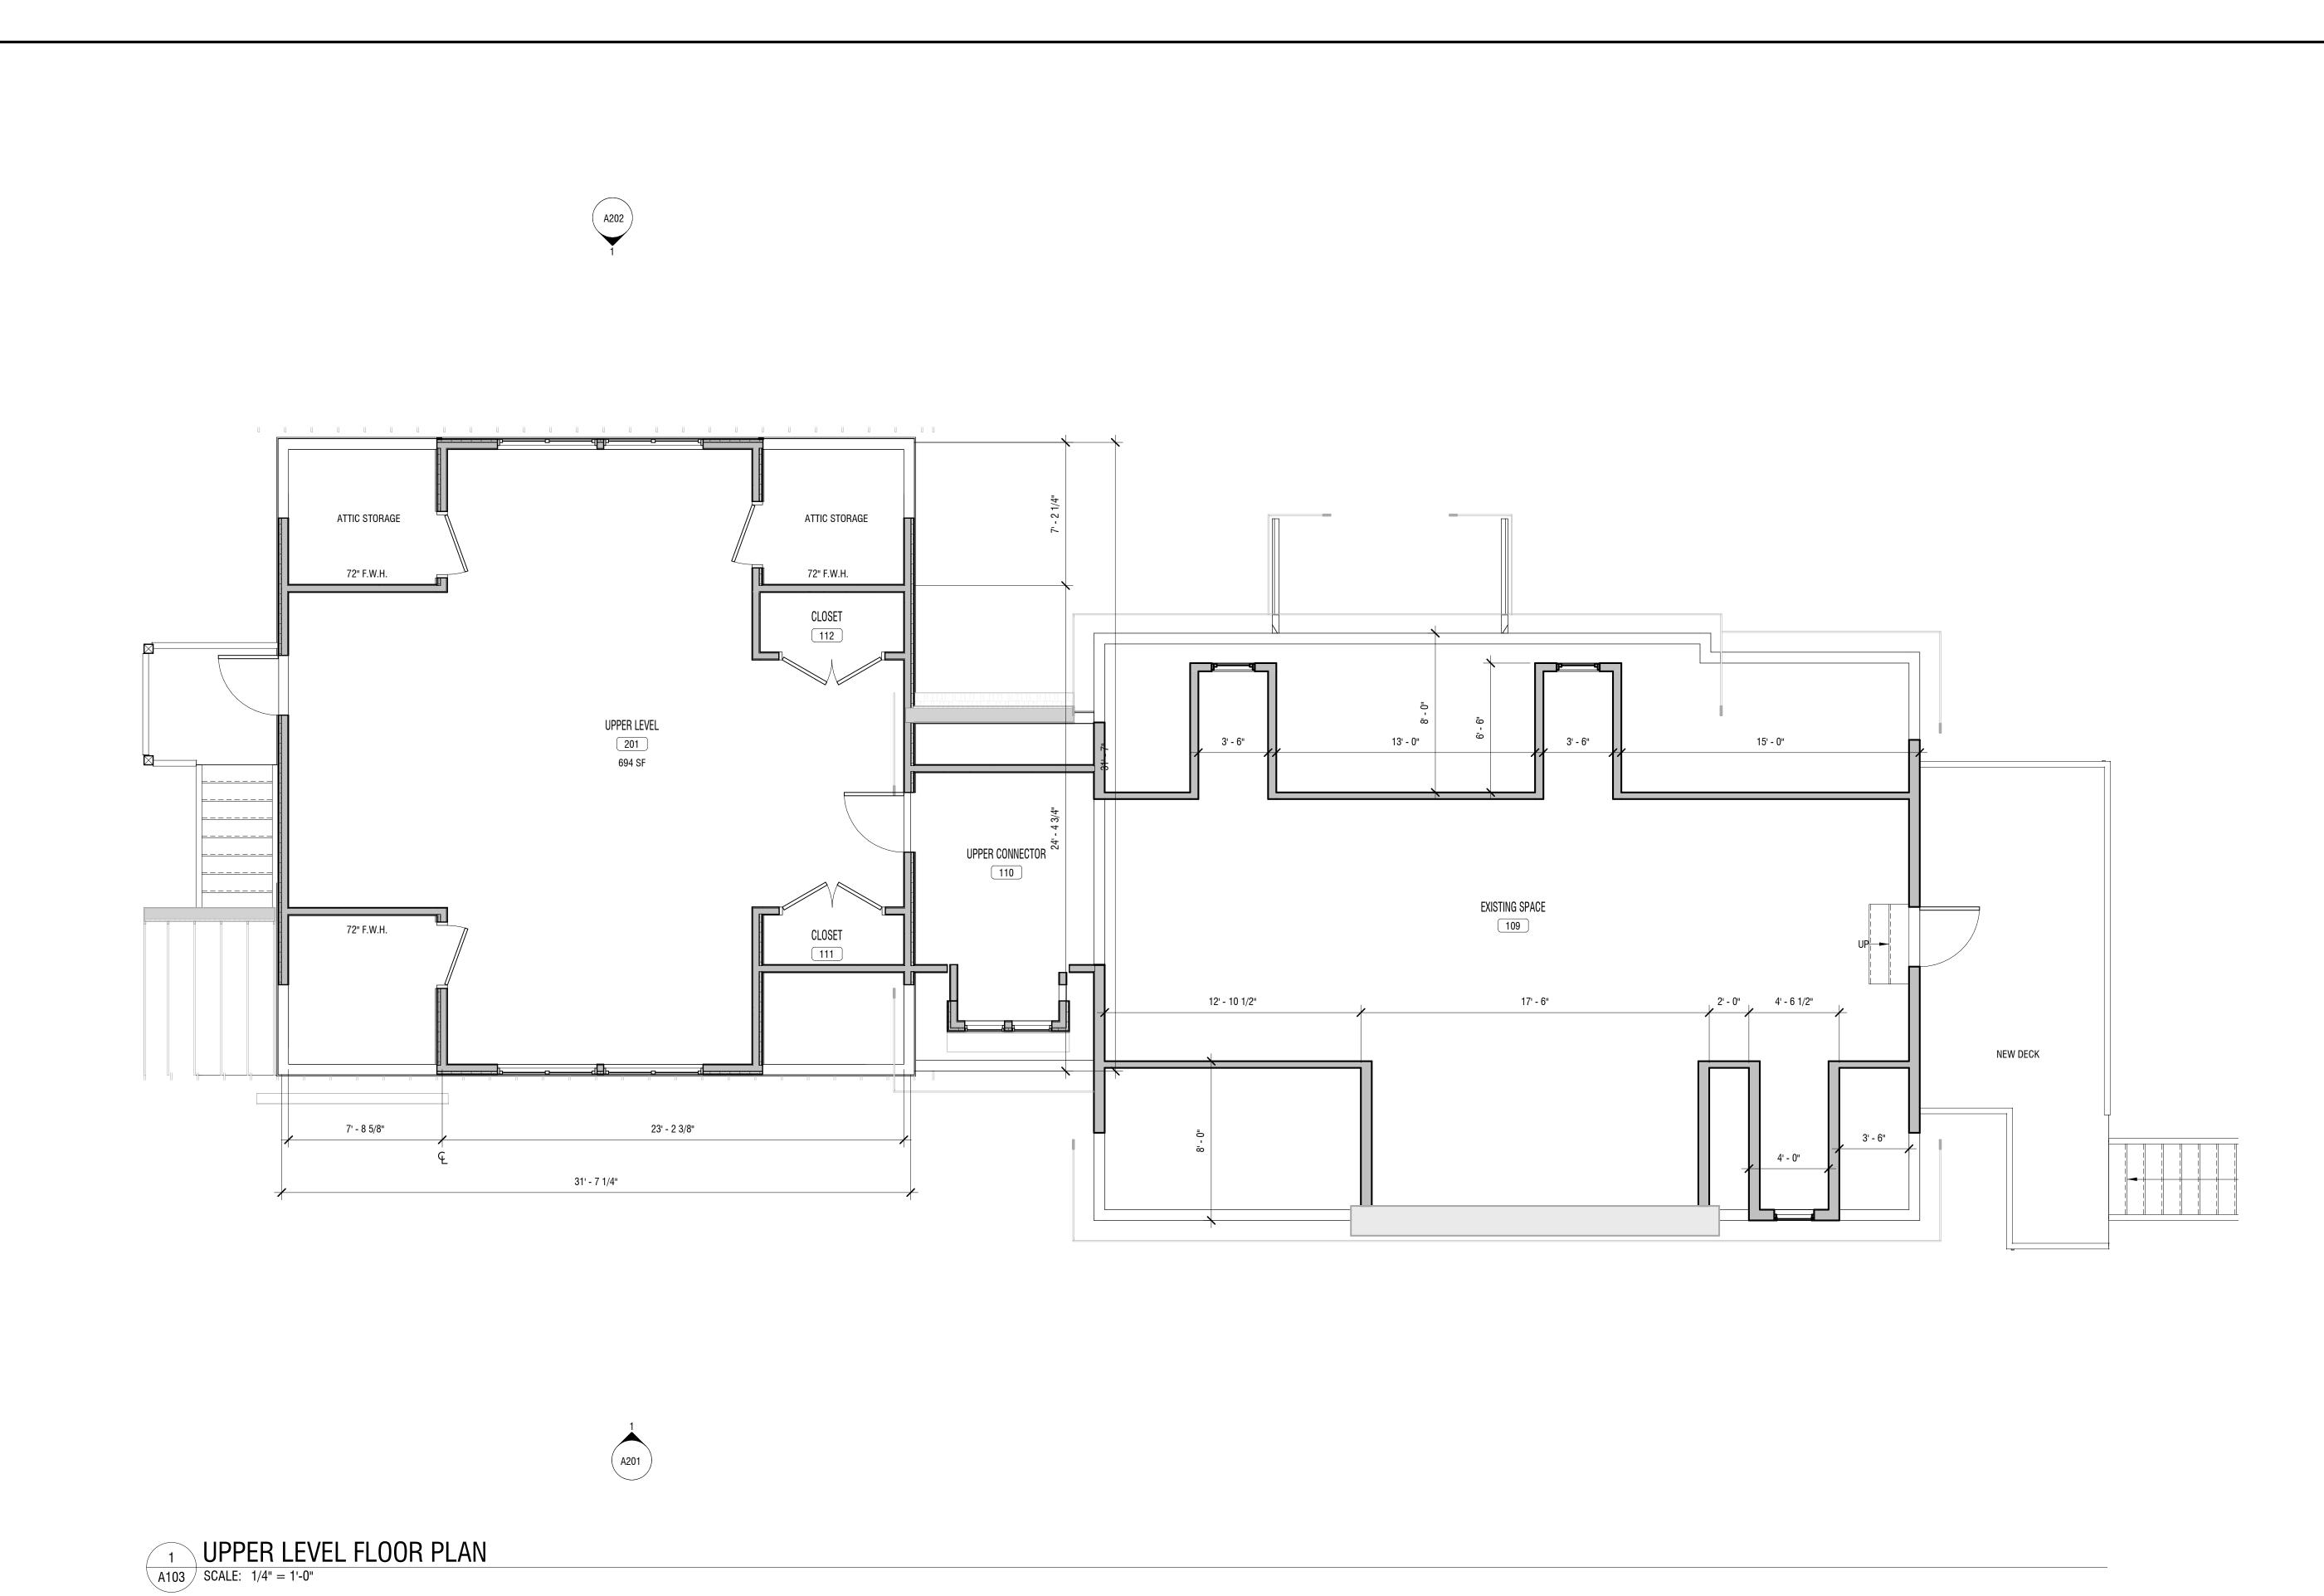511 S. Main Street Davidson, North Carolina 28036


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חבויוביאובה ה	V.	טראא
REVIEWED B	Υ:	REL

UPPER LEVEL FLOOR PLAN

DRAWING NUMBER:

DRAWING NAME:

A103

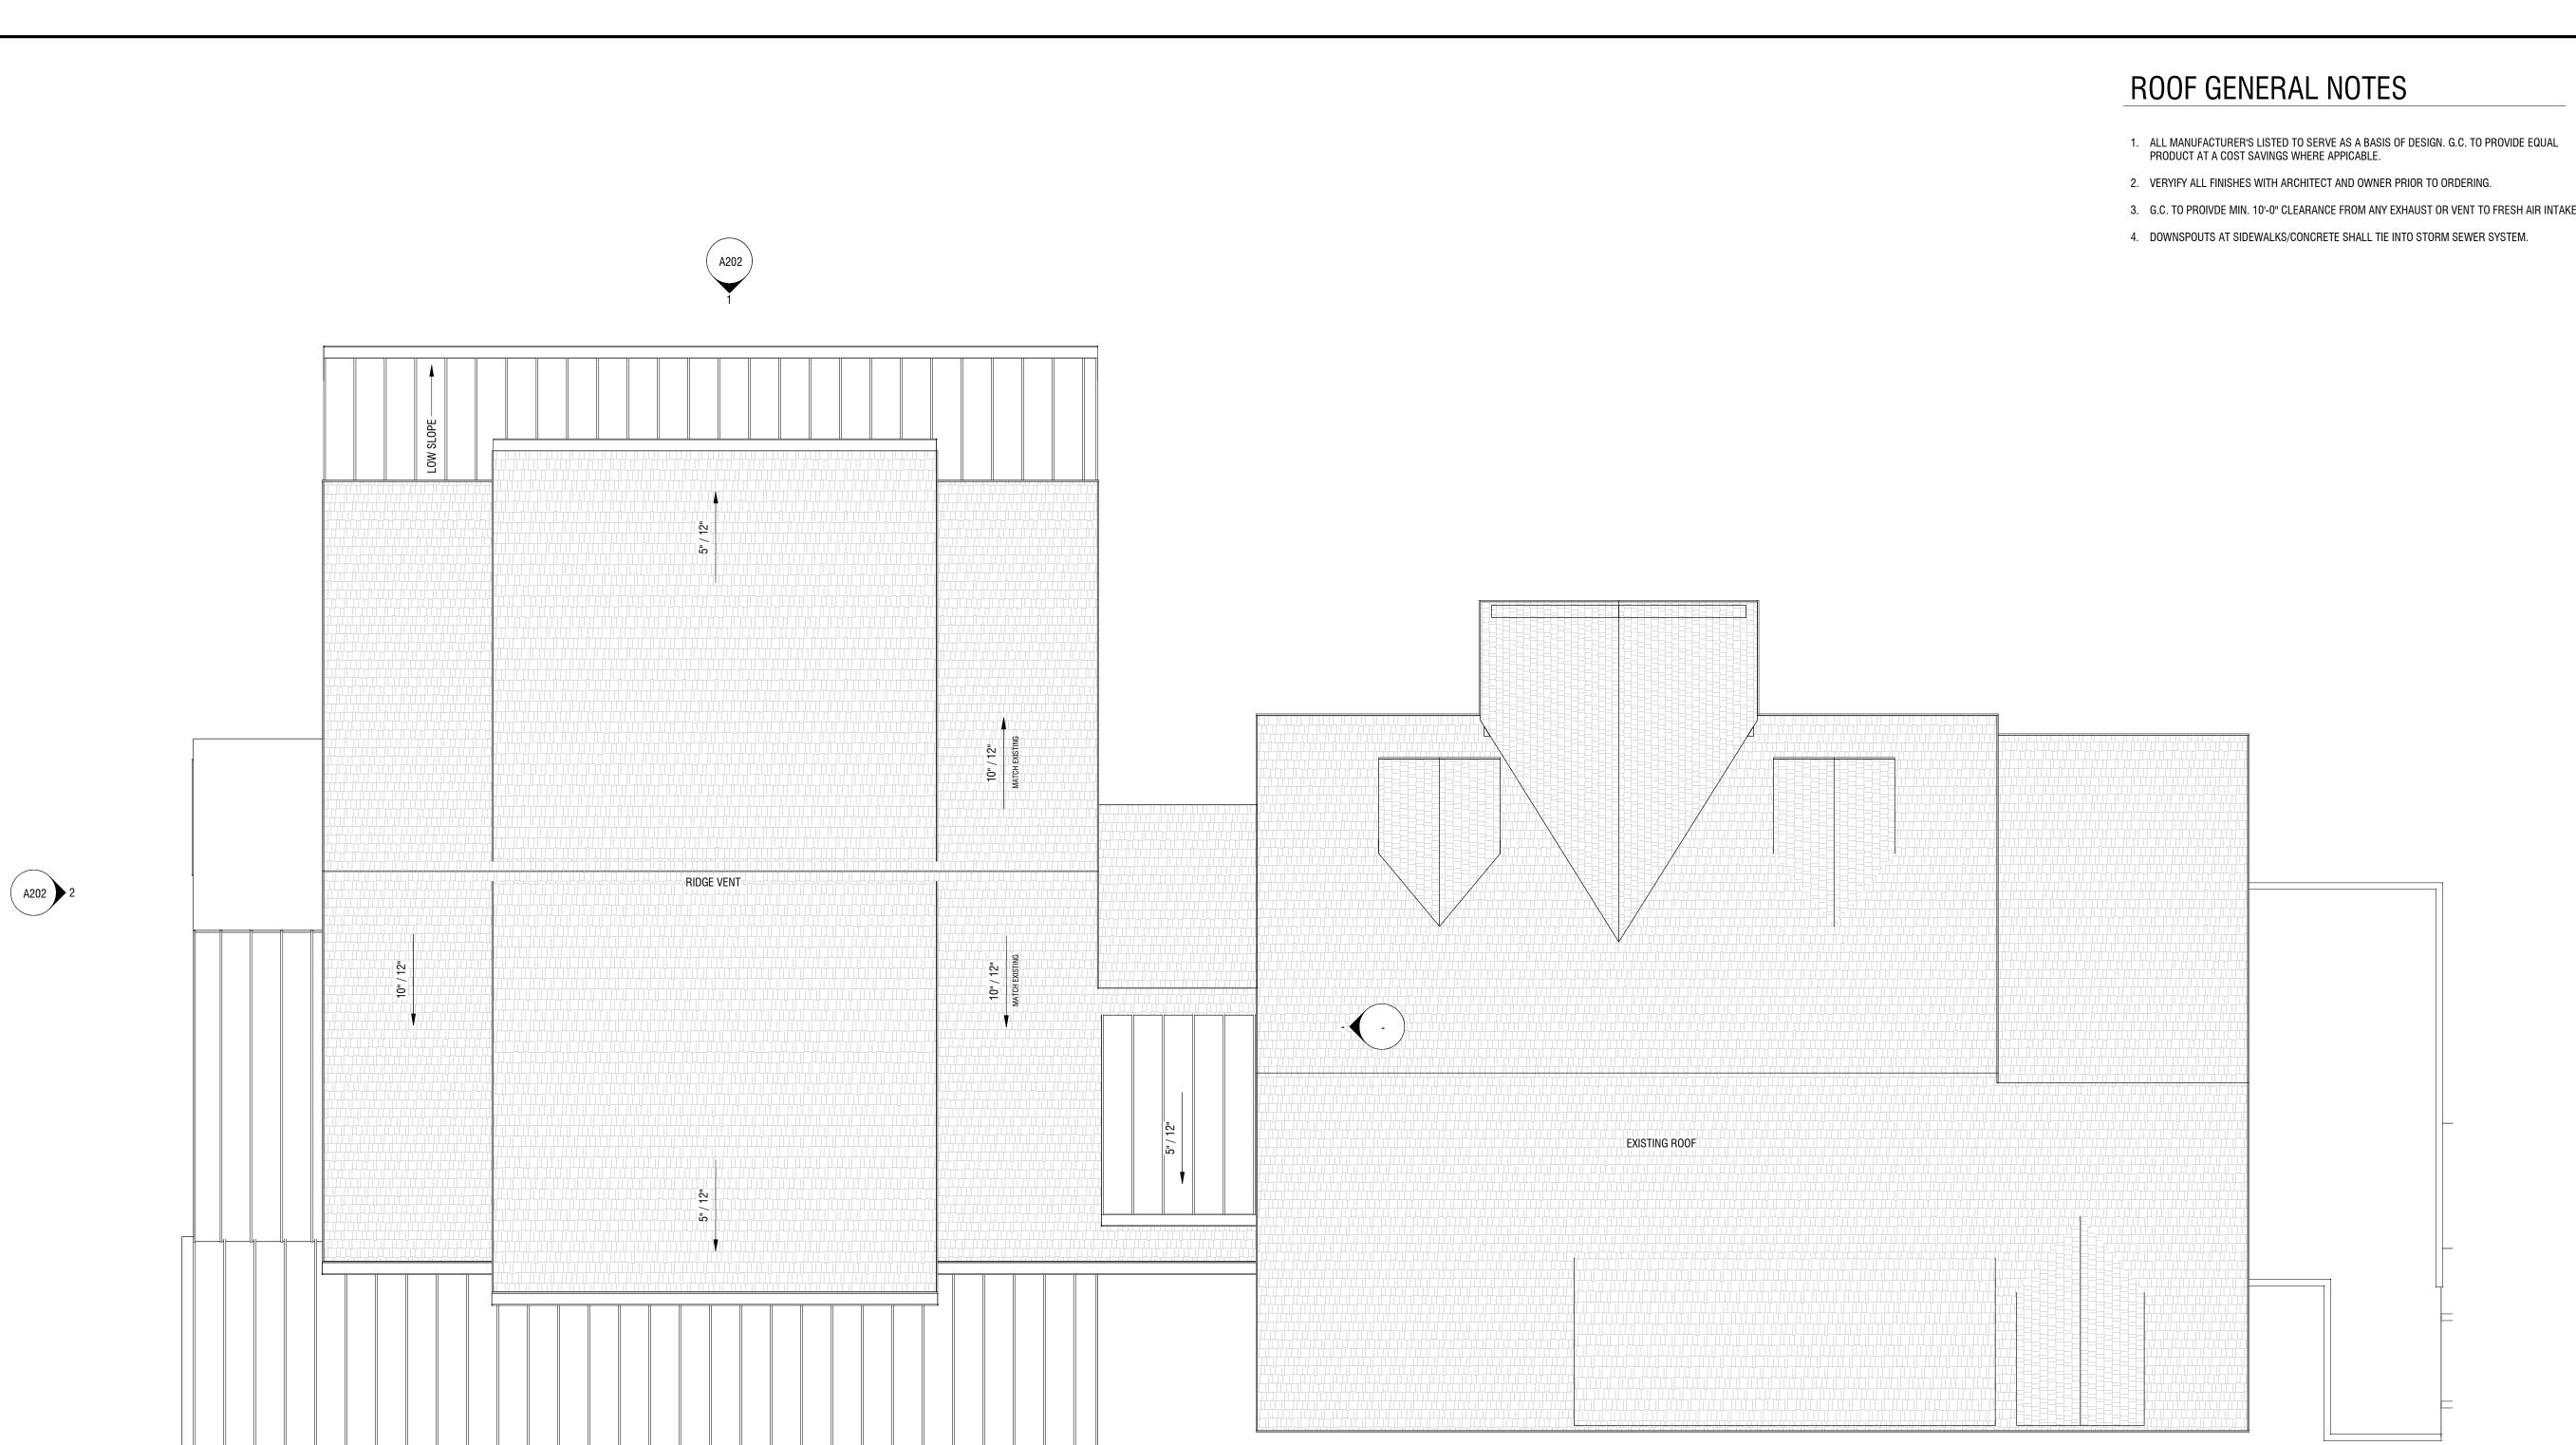




1 ROOF PLAN
A104 SCALE: 1/4" = 1'-0"

- ALL MANUFACTURER'S LISTED TO SERVE AS A BASIS OF DESIGN. G.C. TO PROVIDE EQUAL PRODUCT AT A COST SAVINGS WHERE APPICABLE.



400 S. Tryon Street, Suite 1300 Charlotte, NC 28285 704-376-6423 labellapc.com

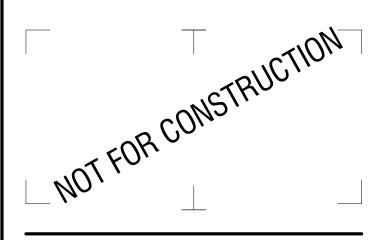



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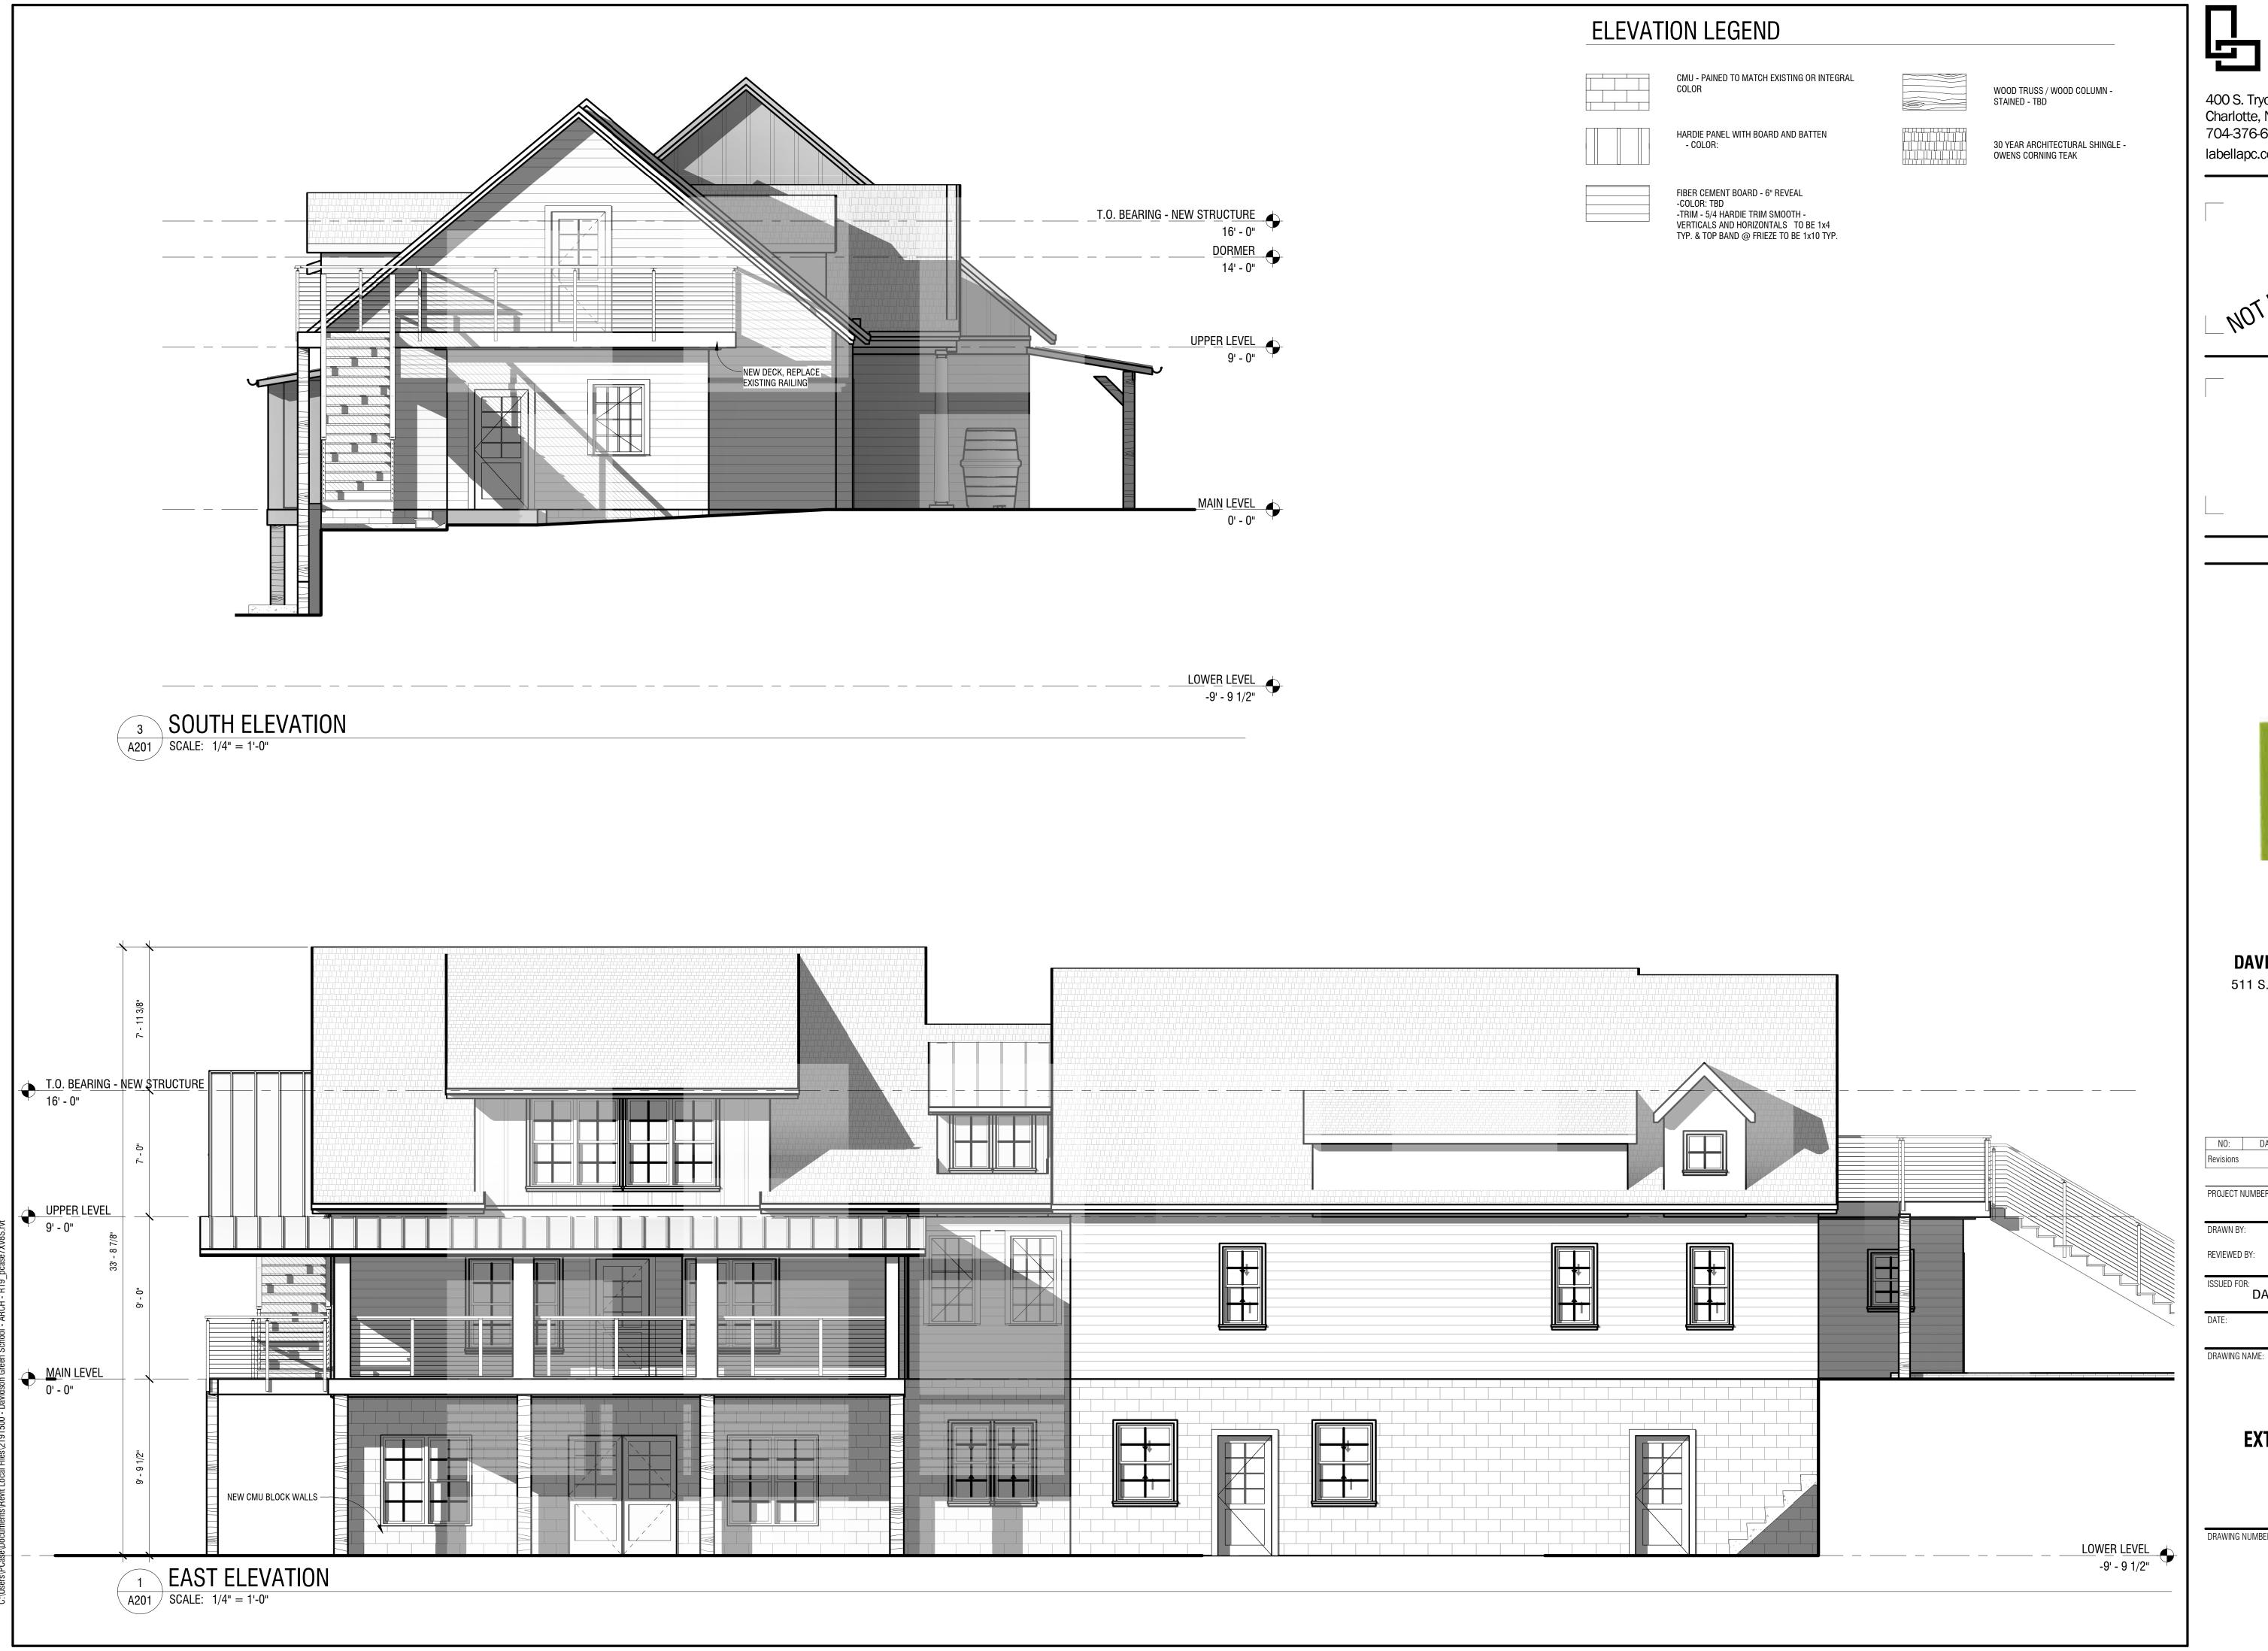
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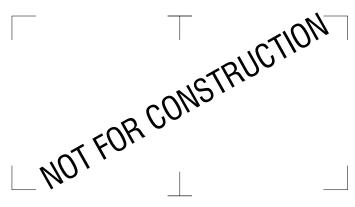
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ROOF PLAN









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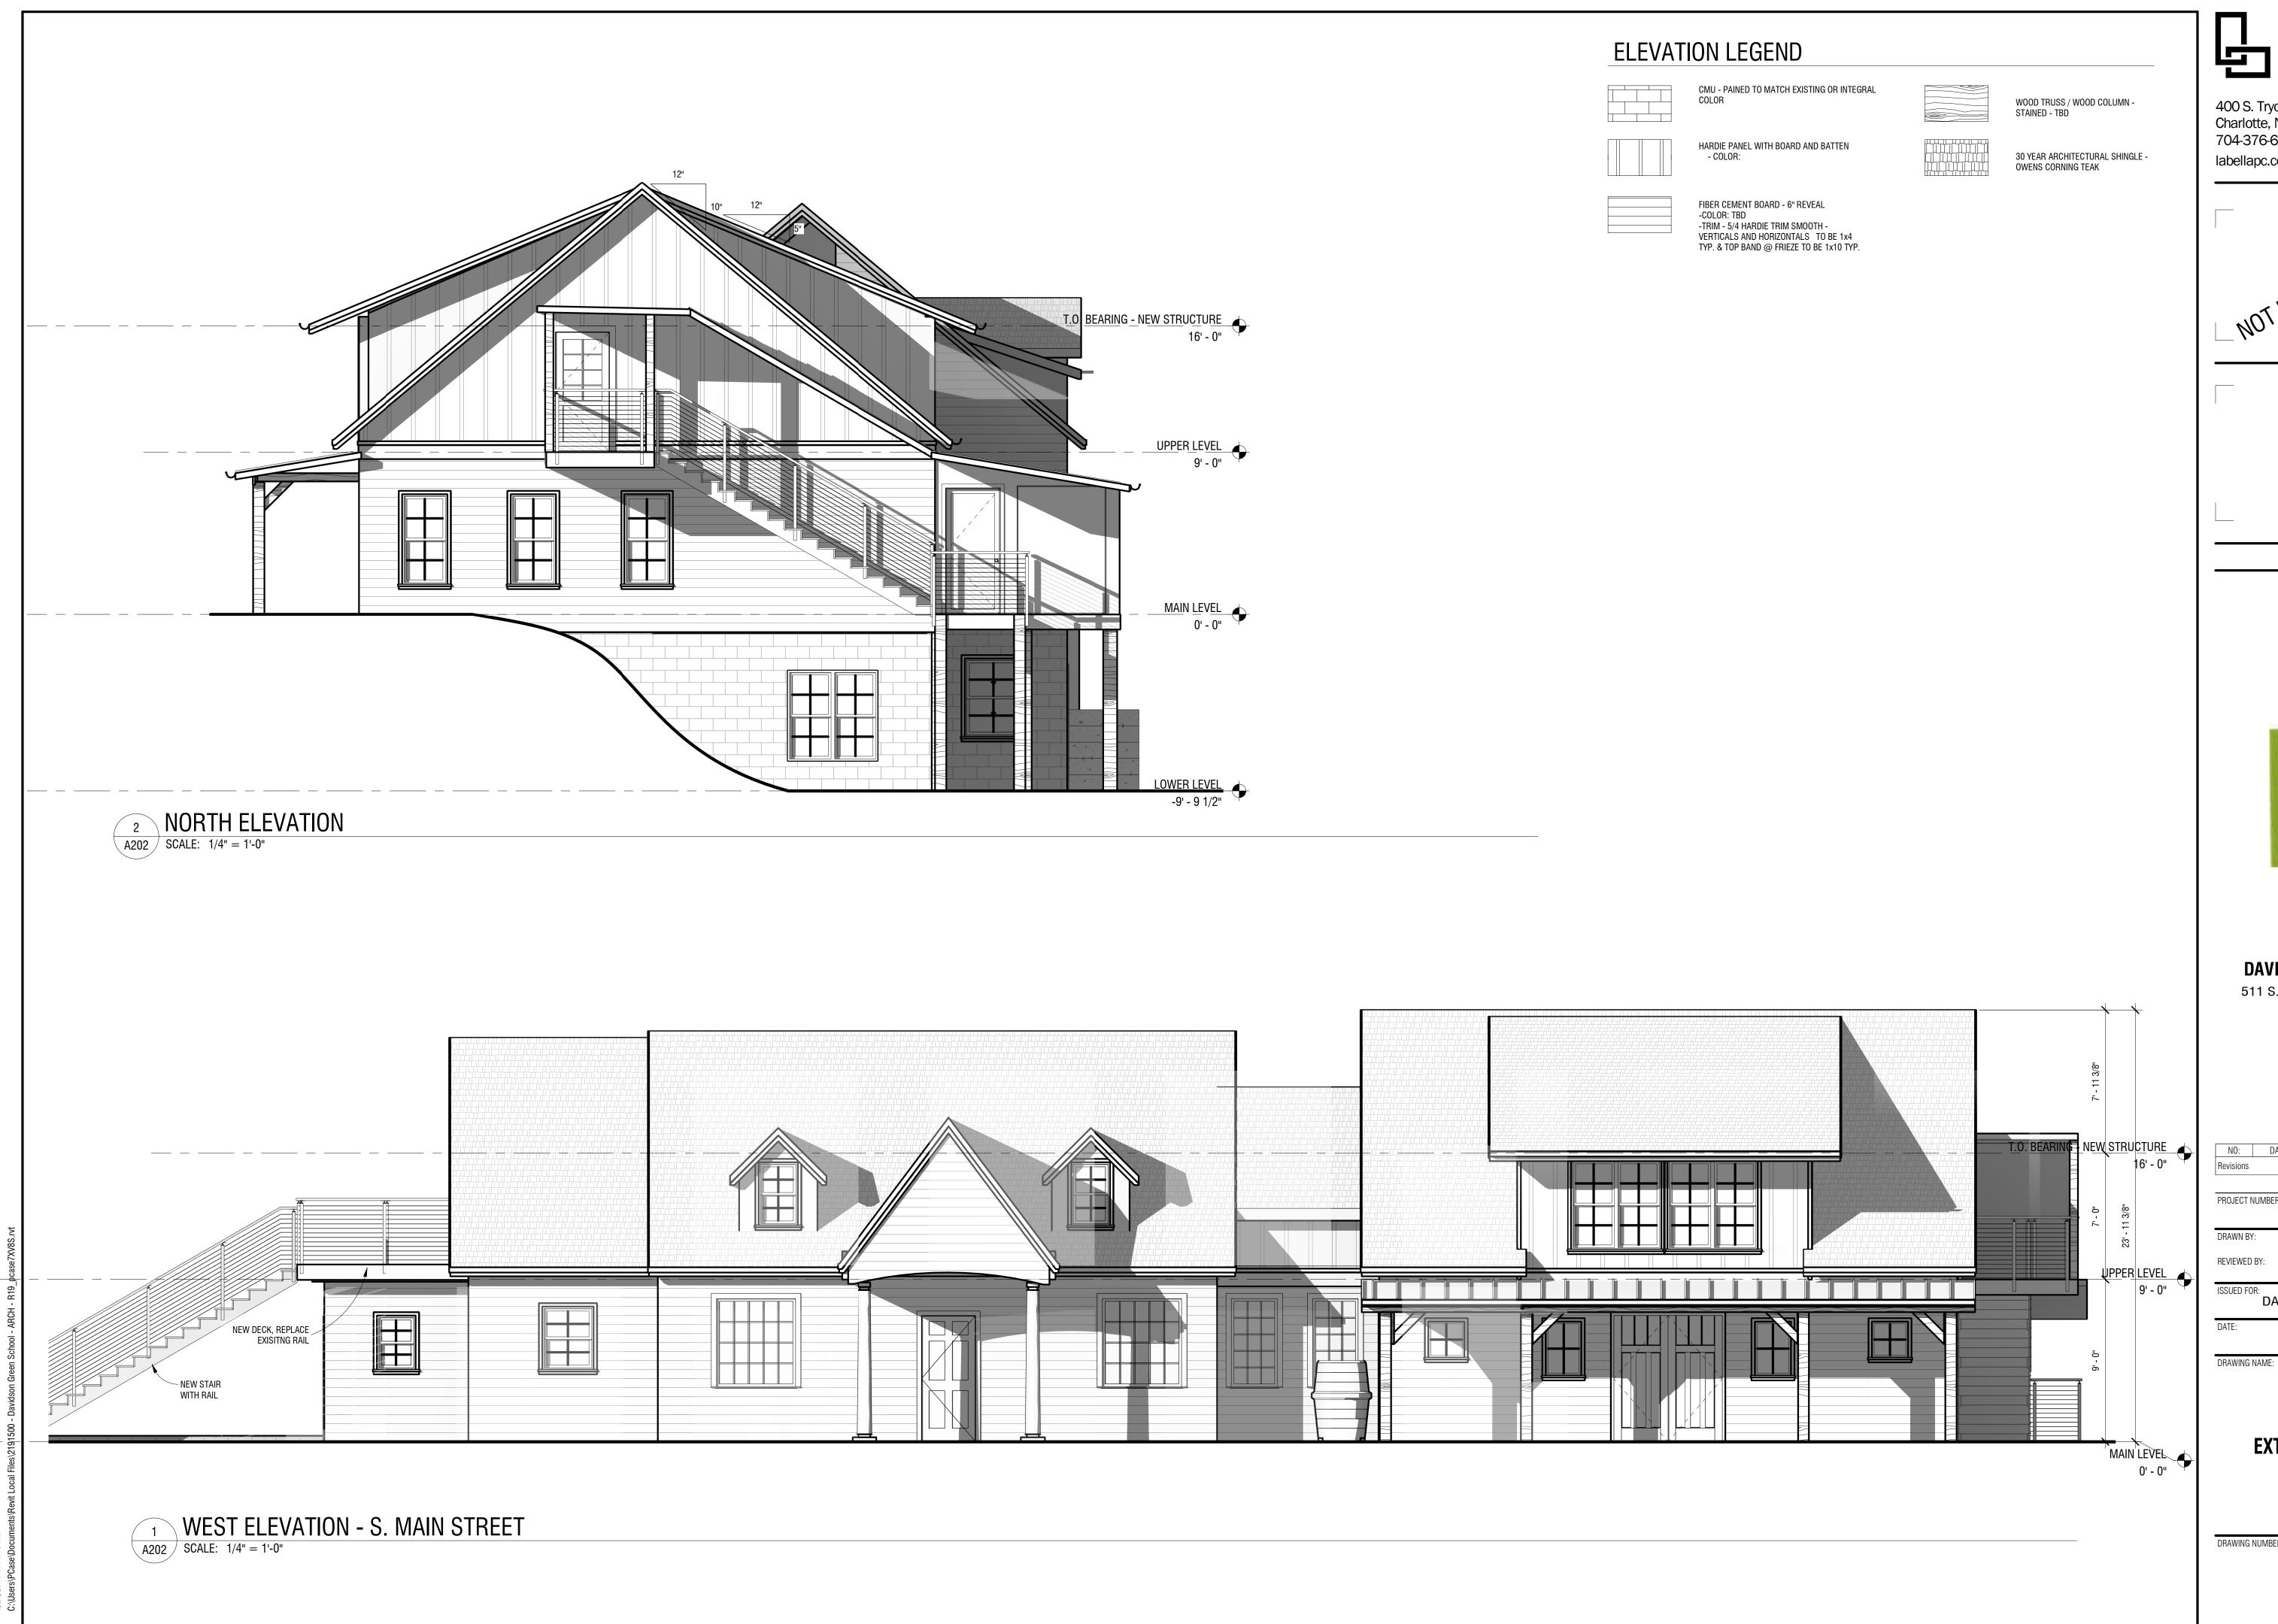



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EXTERIOR ELEVATIONS







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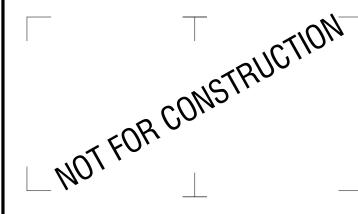
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EXTERIOR ELEVATIONS

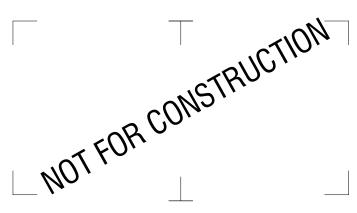







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3D VIEWS

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